PENNSYLVANIA CONVENTION CENTER RESTROOM RENOVATIONS

1101 ARCH STREET, PHILADELPHIA, PA 19107

DRAWING LIST				
Sheet Number	Sheet Name			
ADOLUTEOT! ID A!				
ARCHITECTURAL G000	COVER SHEET			
G000 G001	COVER SHEET CODE SUMMARY			
A000	GENERAL NOTES, SYMBOLS & KEYPLANS			
A000	OVERALL BUILDING PLANS - LEVEL 100			
A002	OVERALL BUILDING PLANS - LEVEL 200			
A003	OVERALL BUILDING PLANS - LEVEL 300 & BALLROOM			
A101	NOT USED			
A102	DEMOLITION & NEW FLOOR PLANS - ROOM F (EXHIBIT)			
A103	DEMOLITION & NEW FLOOR PLANS - ROOMS G & H (EXHIBIT)			
A104	DEMOLITION & NEW FLOOR PLANS - ROOM J (EXHIBIT)			
A105	DEMOLITION & NEW FLOOR PLANS - ROOM K (EXHIBIT)			
A106	DEMOLITION & NEW FLOOR PLANS - ROOMS N, O (EXHIBIT)			
A107	DEMOLITION & NEW FLOOR PLANS - ROOM P (EXHIBIT)			
A108	DEMOLITION & NEW FLOOR PLANS - ROOM Q (EXHIBIT)			
A109	DEMOLITION & NEW FLOOR PLANS - ROOM R (EXHIBIT)			
A110 A111	DEMOLITION & NEW FLOOR PLANS - ROOM S (EXHIBIT) DEMOLITION & NEW FLOOR PLANS - ROOM A (SEMINAR)			
A111 A112	DEMOLITION & NEW FLOOR PLANS - ROOM A (SEMINAR) DEMOLITION & NEW FLOOR PLANS - ROOMS B, C (SEMINAR)			
A112 A113	DEMOLITION & NEW FLOOR PLANS - ROOMS B, C (SEMINAR) DEMOLITION & NEW FLOOR PLANS - ROOM D (SEMINAR)			
A114	DEMOLITION & NEW FLOOR PLANS - ROOM I (SEMINAR)			
A115	DEMOLITION & NEW FLOOR PLANS - ROOMS L, M (SEMINAR)			
A116	DEMOLITION & NEW FLOOR PLANS - ROOM T (SEMINAR)			
A117	NOT USED			
A118	DEMOLITION & NEW FLOOR PLANS - ROOM V (SEMINAR)			
A119	DEMOLITION & NEW FLOOR PLANS - ROOM W (SEMINAR)			
A120	DEMOLITION & NEW FLOOR PLANS - ROOM X (SEMINAR)			
A121	DEMOLITION & NEW FLOOR PLANS - ROOM Y (SEMINAR)			
A122	DEMOLITION & NEW FLOOR PLANS - ROOM Z (SEMINAR)			
A123	DEMOLITION & NEW FLOOR PLANS - ROOM A1 (BALLROOM)			
A124	DEMOLITION & NEW FLOOR PLANS - ROOM A2 (BALLROOM)			
A400	TYPICAL SINK DETAILS			
A401	TYPICAL SINK DETAILS			
A500	TYPICAL WALL PARTITION TYPES			
A500.1	TYPICAL WALL PARTITION TYPES			
A500.2	TYPICAL DETAILS-EXHIBIT TYPICAL WALL PATTERN DETAILS-EXHIBIT			
A500.3 A500.4	TYPICAL WALL PATTERN DETAILS-EXHIBIT TYPICAL DETAILS-SEMINAR & BALLROOM			
A500.4 A500.5	TYPICAL DETAILS-SEMINAR & BALLROOM TYPICAL DETAILS-SEMINAR & BALLROOM			
A501	NOT USED			
A502	ELEVATIONS & DETAILS - ROOM F (EXHIBIT)			
A503	ELEVATIONS & DETAILS - ROOMS G, H (EXHIBIT)			
A504	ELEVATIONS & DETAILS - ROOM J (EXHIBIT)			
A505	ELEVATIONS & DETAILS - ROOM K (EXHIBIT)			
A506	ELEVATIONS & DETAILS - ROOMS N, O (EXHIBIT)			
A507	ELEVATIONS & DETAILS - ROOM P (EXHIBIT)			
A508	ELEVATIONS & DETAILS - ROOM Q (EXHIBIT)			
A509	ELEVATIONS & DETAILS - ROOM R (EXHIBIT)			
A510	ELEVATIONS & DETAILS - ROOM S (EXHIBIT)			
A511	ELEVATIONS & DETAILS - ROOM A (SEMINAR)			
A512	ELEVATIONS & DETAILS - ROOMS B, C (SEMINAR)			
A513	ELEVATIONS & DETAILS - ROOM D (SEMINAR)			
A514 A515	ELEVATIONS & DETAILS - ROOM I (SEMINAR) ELEVATIONS & DETAILS - ROOMS L, M (SEMINAR)			
A515 A516	ELEVATIONS & DETAILS - ROOMS L, M (SEMINAR)			
A517	NOT USED			
A518	ELEVATIONS & DETAILS - ROOM V (SEMINAR)			
A519	ELEVATIONS & DETAILS - ROOM W (SEMINAR)			
A520	ELEVATIONS & DETAILS - ROOMS X (SEMINAR)			
A521	ELEVATIONS & DETAILS - ROOMS Y (SEMINAR)			
A522	ELEVATIONS & DETAILS - ROOM Z (SEMINAR)			
A523	ELEVATIONS & DETAILS - ROOM A1 (BALLROOM)			
A524	ELEVATIONS & DETAILS - ROOM A2 (BALLROOM)			
A600	TYPICAL CEILING DETAILS & SCHEDULES			
A600.1	TYPICAL CEILING DETAILS & SCHEDULES			
A601	NOT USED			
A602	RCP & FINISH PLANS - ROOM F (EXHIBIT)			
A603	RCP & FINISH PLANS - ROOMS G, H (EXHIBIT)			
A604	RCP & FINISH PLANS - ROOM J (EXHIBIT)			
A605	RCP & FINISH PLANS - ROOM K (EXHIBIT)			
A606	RCP & FINISH PLANS - ROOMS N, O (EXHIBIT)			
A607	RCP & FINISH PLAN - ROOM P (EXHIBIT)			
A608 A609	RCP & FINISH PLAN - ROOM Q (EXHIBIT) RCP & FINISH PLAN - ROOM R (EXHIBIT)			
	0 - 0 - 0 - 0 - 0 - 0 - 0 - 0 - 0			

Sheet Number	Sheet Name
A611	RCP & FINISH PLANS - ROOM A (SEMINAR)
A612 A613	RCP & FINISH PLANS - ROOMS B, C (SEMINAR) RCP & FINISH PLAN - ROOM D (SEMINAR)
A614	RCP & FINISH PLAN - ROOM I (SEMINAR)
A615	RCP & FINISH PLANS - ROOMS L, M (SEMINAR)
A616	RCP & FINISH PLAN - ROOM T (SEMINAR)
A617	NOT USED
A618	RCP & FINISH PLAN - ROOM V (SEMINAR)
A619	RCP & FINISH PLAN - ROOM W (SEMINAR)
A620	RCP & FINISH PLANS - ROOM X (SEMINAR)
A621	RCP & FINISH PLANS - ROOM Y (SEMINAR)
A622	RCP & FINISH PLANS - ROOM Z (SEMINAR) RCP & FINISH PLAN - ROOM A1 (BALLROOM)
A623 A624	RCP & FINISH PLAN - ROOM A2 (BALLROOM)
A800	EXHIBIT TYPE ROOM SIGNAGE
A801	SEMINAR TYPE ROOM SIGNAGE
MECHANICAL	
M001	GENERAL NOTES ABBREVIATIONS & LEGEND
M101	NOT USED
M102	DEMOLITION & NEW FLOOR PLANS - ROOM F (EXHIBIT)
M103	DEMOLITION & NEW FLOOR PLANS - ROOMS G, H (EXHIBIT)
M104	DEMOLITION & NEW FLOOR PLANS - ROOM J (EXHIBIT)
M105	DEMOLITION & NEW FLOOR PLANS - ROOM K (EXHIBIT)
M106 M107	DEMOLITION & NEW FLOOR PLANS - ROOMS N, O (EXHIBIT) DEMOLITION & NEW FLOOR PLANS - ROOM P (EXHIBIT)
M108	DEMOLITION & NEW FLOOR PLANS - ROOM P (EXHIBIT)
M109	DEMOLITION & NEW FLOOR PLANS - ROOM R (EXHIBIT)
M110	DEMOLITION & NEW FLOOR PLANS - ROOM S (EXHIBIT)
M111	DEMOLITION & NEW FLOOR PLANS - ROOM A (SEMINAR)
M112	DEMOLITION & NEW FLOOR PLANS - ROOMS B, C (SEMINAR)
M113	DEMOLITION & NEW FLOOR PLANS - ROOM D (SEMINAR)
M114	DEMOLITION & NEW FLOOR PLANS - ROOM I (SEMINAR)
M115	DEMOLITION & NEW FLOOR PLANS - ROOMS L, M (SEMINAR)
M116	DEMOLITION & NEW FLOOR PLANS - ROOM T (SEMINAR)
M116A M117	DEMOLITION & NEW FLOOR PLANS - ROOM T (SEMINAR) NOT USED
M118	DEMOLITION & NEW FLOOR PLANS - ROOM V (SEMINAR)
M119	DEMOLITION & NEW FLOOR PLANS - ROOM W (SEMINAR)
M120	DEMOLITION & NEW FLOOR PLANS - ROOM X (SEMINAR)
M121	DEMOLITION & NEW FLOOR PLANS - ROOM Y (SEMINAR)
M122	DEMOLITION & NEW FLOOR PLANS - ROOM Z (SEMINAR)
M123	DEMOLITION & NEW FLOOR PLANS - ROOM A1 (BALLROOM)
M124	DEMOLITION & NEW FLOOR PLANS - ROOM A2 (BALLROOM)
M200	SCHEDULES AND DETAILS
M601 M602	NOT USED REFLECTED CEILING PLAN - ROOM F (EXHIBIT)
M603	REFLECTED CEILING PLAN - ROOMS G, H (EXHIBIT)
M604	REFLECTED CEILING PLAN - ROOM J (EXHIBIT)
M605	REFLECTED CEILING PLAN - ROOM K (EXHIBIT)
M606	REFLECTED CEILING PLAN - ROOMS N, O (EXHIBIT)
M607	REFLECTED CEILING PLAN - ROOM P (EXHIBIT)
M608	REFLECTED CEILING PLAN - ROOM Q (EXHIBIT)
M609	REFLECTED CEILING PLAN - ROOM R (EXHIBIT)
M610	REFLECTED CEILING PLAN - ROOM S (EXHIBIT)
M611	REFLECTED CEILING PLAN - ROOM A (SEMINAR)
M612 M613	REFLECTED CEILING PLAN - ROOMS B, C (SEMINAR) REFLECTED CEILING PLAN - ROOM D (SEMINAR)
M614	REFLECTED CEILING PLAN - ROOM D (SEMINAR) REFLECTED CEILING PLAN - ROOM I (SEMINAR)
M615	REFLECTED CEILING PLAN - ROOMS L, M (SEMINAR)
M616	REFLECTED CEILING PLAN - ROOM T (SEMINAR)
M617	NOT USED
M618	REFLECTED CEILING PLAN - ROOM V (SEMINAR)
M619	REFLECTED CEILIGN PLAN - ROOM W (SEMINAR)
M620	REFLECTED CEILING PLAN - ROOM X (SEMINAR)
M621	REFLECTED CEILING PLAN - ROOM Y (SEMINAR)
M622	REFLECTED CEILING PLAN - ROOM Z (SEMINAR)
M623	REFLECTED CEILING PLAN - ROOM A1 (SEMINAR)
M624	REFLECTED CEILIGN PLAN - ROOM A2 (SEMINAR)
M801 M802	PLUMBING RISERS PLUMBING RISERS
M803	PLUMBING RISERS
M804	PLUMBING RISERS
	and the contract of the contra
M805	PLUMBING RISERS

PLUMBING RISERS

	DRAWING LIST
Sheet Number	Sheet Name
ELECTRICAL E001	GENERAL NOTES, ABBREVIATIONS & LEGEND
E001	SITE POWER PLAN - LEVEL 100
E003	SITE POWER PLAN - LEVEL 200
E004	SITE POWER PLAN - LEVEL 300 AND BALLROOM
E101	NOT USED
E102	DEMOLITION & NEW FLOOR PLANS - ROOM F (EXHIBIT)
E103	DEMOLITION & NEW FLOOR PLANS - ROOMS G, H (EXHIBIT)
E104	DEMOLITION & NEW FLOOR PLANS - ROOM J (EXHIBIT)
E105	DEMOLITION & NEW FLOOR PLANS - ROOM K (EXHIBIT)
E106 E107	DEMOLITION & NEW FLOOR PLANS - ROOMS N, O (EXHIBIT) DEMOLITION & NEW FLOOR PLANS - ROOM P (EXHIBIT)
E107	DEMOLITION & NEW FLOOR PLANS - ROOM P (EXHIBIT) DEMOLITION & NEW FLOOR PLANS - ROOM Q (EXHIBIT)
E109	DEMOLITION & NEW FLOOR PLANS - ROOM R (EXHIBIT)
E110	DEMOLITION & NEW FLOOR PLANS - ROOM S (EXHIBIT)
E111	DEMOLITION & NEW FLOOR PLANS - ROOM A (SEMINAR)
E112	DEMOLITION & NEW FLOOR PLANS - ROOMS B, C (SEMINAR)
E113	DEMOLITION & NEW FLOOR PLANS - ROOM D (SEMINAR)
E114	DEMOLITION & NEW FLOOR PLANS - ROOM I (SEMINAR)
E115	DEMOLITION & NEW FLOOR PLANS - ROOMS L, M (SEMINAR)
E116	DEMOLITION & NEW FLOOR PLANS - ROOM T (SEMINAR)
E117 E118	NOT USED DEMOLITION & NEW FLOOR PLANS - ROOM V (SEMINAR)
E118 E119	DEMOLITION & NEW FLOOR PLANS - ROOM V (SEMINAR) DEMOLITION & NEW FLOOR PLANS - ROOM W (SEMINAR)
E120	DEMOLITION & NEW FLOOR PLANS - ROOM X (SEMINAR)
E121	DEMOLITION & NEW FLOOR PLANS - ROOM Y (SEMINAR)
E122	DEMOLITION & NEW FLOOR PLANS - ROOM Z (SEMINAR)
E123	DEMOLITION & NEW FLOOR PLANS - ROOM A1 (BALLROOM)
E124	DEMOLITION & NEW FLOOR PLANS - ROOM A2 (BALLROOM)
E601	NOT USED
E602	REFLECTED CEILING PLAN - ROOM F (EXHIBIT)
E603	REFLECTED CEILING PLAN - ROOMS G, H (EXHIBIT)
E604	REFLECTED CEILING PLAN - ROOM J (EXHIBIT) REFLECTED CEILING PLAN - ROOM K (EXHIBIT)
E605 E606	REFLECTED CEILING PLAN - ROOMS N, O (EXHIBIT)
E607	REFLECTED CEILING PLAN - ROOM P (EXHIBIT)
E608	REFLECTED CEILING PLAN - ROOM Q (EXHIBIT)
E609	REFLECTED CEILING PLAN - ROOM R (EXHIBIT)
E610	REFLECTED CEILING PLAN - ROOM S (EXHIBIT)
E611	REFLECTED CEILING PLAN - ROOM A (SEMINAR)
E612	REFLECTED CEILING PLAN - ROOMS B, C (SEMINAR)
E613	REFLECTED CEILING PLAN - ROOM D (SEMINAR)
E614 E615	REFLECTED CEILING PLAN - ROOM I (SEMINAR) REFLECTED CEILING PLAN - ROOMS L, M (SEMINAR)
E616	REFLECTED CEILING PLAN - ROOM'S L, M (SEMINAR) REFLECTED CEILING PLAN - ROOM T (SEMINAR)
E617	NOT USED
E618	REFLECTED CEILING PLAN - ROOM V (SEMINAR)
E619	REFLECTED CEILING PLAN - ROOM W (SEMINAR)
E620	REFLECTED CEILING PLAN - ROOM X (SEMINAR)
E621	REFLECTED CEILING PLAN - ROOM Y (SEMINAR)
E622	REFLECTED CEILING PLAN - ROOM Z (SEMINAR)
E623	REFLECTED CEILING PLAN - ROOM A1 (SEMINAR)
E624	REFLECTED CEILIGN PLAN - ROOM A2 (SEMINAR) ELECTRICAL DETAILS AND DIAGRAMS
E701 E702	LUMINARE SCHEDULE
E801	ELECTRICAL PANEL SCHEDULES - SHEET 1
E802	ELECTRICAL PANEL SCHEDULES - SHEET 2
E803	ELECTRICAL PANEL SCHEDULES - SHEET 3
E804	ELECTRICAL PANEL SCHEDULES - SHEET 4
E805	ELECTRICAL PANEL SCHEDULES - SHEET 5
E806	ELECTRICAL PANEL SCHEDULES - SHEET 6
E807	ELECTRICAL PANEL SCHEDULES - SHEET 7
E808	ELECTRICAL PANEL SCHEDULES - SHEET 8
E809	ELECTRICAL PANEL SCHEDULES - SHEET 9 ELECTRICAL PANEL SCHEDULES - SHEET 10
E810 E811	ELECTRICAL PANEL SCHEDULES - SHEET 10 ELECTRICAL PANEL SCHEDULES - SHEET 11
E011	ELECTRICAL PANEL SCHEDULES - SHEET 12

ELECTRICAL PANEL SCHEDULES - SHEET 12







PERSPECTIVE VIEW - SEMINAR TYPE RESTROOM

CONVERSE **WINKLER** ARCHITECTURE

ARCHITECTS: CONVERSE WINKLER ARCHITECTURE 331 Montgomery Avenue, Bala Cynwyd, PA, 19144

Ph: 610.664.0806 Fax: 215.664.1075

Contact: Elin Westrick e-mail: ewestrick@cwarc.com



P (610) 459-7900 | F (610) 459-7950 | aroraengineers.co

Contact: Kevin Sultanik e-mail: ksultanik@aroraengineers.com

STRUCTURAL ENGINEERS: CSA GROUP 1341 NORTH DELAWARE AVENUE,

PHILADELPHIA, PA 19125 Ph: 215.427.8700 Fax: 215.427.8752

Contact: Wing Au e-mail: wau@csagroup.com



Description

COVER SHEET

Project numb	er	CW1615
Date	November	25, 2019
Drawn by		KR/LC
Checked by		EW

G000

1/4" = 1'-0"

CODE SUMMARY

BUILDING INFORMATION:

Pennsylvania Convention Center 1101 Arch Street, Philadelphia, PA 19107

Existing Building: 3 stories plus 3 mezzanine levels; Floor area > 2,000,000 sf

Construction Type: 1A, Fully sprinklered Mixed use occupancy: A-3, B, S-1, S-2

Project Work Area: 17,673 sf

Work area is limited to public restrooms on 4 levels in original part of building (constructed in 1990s).

The building was originally constructed under the Philadelphia Code and has changed jurisdiction since its construction, as it is now State-owned.

GOVERNING CODES:

Adopted and enforced by the Pennsylvania Department of Labor & Industry:

(The Pennsylvania Convention Center is State-owned and therefore under PA L&I jurisdiction)

Uniform Construction Code (UCC)

Above code incorporates: 2015 ICC Codes

Other applicable codes and standards:

Philadelphia Code 2010, Title 4 - Philadelphia Building Construction and Occupancy Code (also applicable to state-owned

ICC/ANSI A117.1 - 2009

ADA Standards for Accessible Design - 2010

301.1.2 Work area compliance method - **SELECTED EVALUATION METHOD** Alterations shall be in compliance with applicable requirements of Chapters 5 through 13.

Chapter 2 - Definitions

Work Area - That portion or portions of a building consisting of all reconfigured spaces as indicated on the construction documents. Work area excludes other portions of the building where incidental work entailed by the intended work must be performed and portions of the building where work not initially intended by the owner is specifically required by this code.

Chapter 5 - Classification of Work

503.1 Level 1 Alterations - include the removal and replacement or the covering of existing materials, elements,

equipment, or fixtures using new ones that serve the same purpose. 503.2 Application. Level 1 alterations shall comply with the provisions of Chapter 6.

504.1 Level 2 Alterations - include the reconfiguration of space, the reconfiguration or extension of any system, or

the installation of any additional equipment. 504.2 Application. Level 2 alterations shall comply with the provisions of Chapters 6 and 7.

LEVEL 2 ALTERATIONS IN THIS PROJECT ARE LIMITED TO: 1. MINOR RELOCATION OF NON-BEARING WALLS FOR THE PURPOSE OF INCREASING

ACCESSIBILITY 2. ADDITION OF ELECTRIC HAND DRYERS WITHIN THE RESTROOMS.

Chapter 7 - Alterations - Level 1

Section 702 Building Elements and Materials

702.1 Interior wall & ceiling finishes shall comply with IBC Chapter 8. 702.2 Interior floor finishes shall comply with IBC Section 804.

702.6 Materials and methods - All new work shall comply with the ICC International Codes.

705.1 General. All elements that are altered must be made accessible unless technically infeasible. Where technically infeasible, alteration shall provide access to the greatest extent technically feasible.

Exceptions: 1) The altered element or space is not required to be on an accessible route. 2) Accessible means of egress are not required to be provided in existing facilities.

ALL ALTERED ELEMENTS ARE BEING MADE ACCESSIBLE.

Chapter 8 - Alterations - Level 2

801.3 Compliance. All new construction elements, components, systems, and spaces shall comply with the requirements of the IBC. Exception: Newly installed electrical equipment shall comply with the requirements of

806.1 General. A building or element that is altered shall comply with Section 605.

303.1 Use and Occupancy Classification of Work Area. A-3 Exhibition Halls

Chapter 6 - Types of Construction

Table 601 Fire-Resistance Rating Requirements for Building Elements - Construction Type 1A

Primary structural frame 3 hours Bearing walls - Exterior 3 hours Bearing walls - Interior 3 hours see Table 602

Nonbearing walls and partitions - Exterior Nonbearing walls and partitions - Interior 0 hours Floor construction 2 hours Roof construction 1 1/2 hours

Chapter 8 - Interior Finishes

803.1.1 Interior wall and ceiling finish materials shall be classified in accordance with ASTM E84. Such finish

materials shall be grouped in the following classes: Class A: flame spread 0-25, smoke developed 0-450

Class B: flame spread 26-75, smoke developed 0-450

Class C: flame spread 76-200, smoke developed 0-450 Table 803.11 Interior Wall and Ceiling Finishes by Occupancy Group Rooms and Enclosed Spaces

Class C

Chapter 9 - Fire Protection Systems 903.2.1.3 Group A-3. An automatic sprinkler system shall be provided for Group A-3 occupancies. **BUILDING IS FULLY SPRINKLERED.**

Chapter 10 - Means of Egress

1003.3.3 Protruding objects - Horizontal projections shall not project horizontally more than 4 inches over any walking surface between the heights of 27 and 80 inches above the walking surface.

1004 Occupant Load. NO CHANGE IS PROPOSED TO BUILDING OCCUPANT LOAD. 1008.3.5 Means of egress illumination level shall not be less than 1 foot-candle at the walking surface.

OCCUPANT LOAD CALCULA	ATIONS (PER	TABLE 1004.1.1)		
LOCATION	FUNCTION	FLOOR AREA ALLOWANCE	CALCULATED OCCUPANT LOAD	EXISTING POSTE OCCUPANT LOA
100 Level Meeting Rooms	A3	7 sf / occupant net	6,562	6,90
100 Level Lecture Hall	A3	fixed seats	615	61
100 Level Exhibition Hall F	A3	15 sf / occupant net	7,699	8,01
			14,876	15,539
200 Level Exhibition Hall A	A3	15 sf / occupant net	8,891	8,88
200 Level Exhibition Hall B	A3	15 sf / occupant net	5,973	5,92
200 Level Exhibition Hall C	A3	15 sf / occupant net	5,961	5,92
200 Level Meeting Rooms	A3	7 sf / occupant net	3,823	3,94
200 Level Grand Hall	A3	7 sf / occupant net	8,078	8,07
			32,726	32,742
300 Level Overlook Meeting Rooms	A3	7 sf / occupant net	1,522	1,47
			1,522	1,471
Ballroom Level	A3	7 sf / occupant net	4,453	4,45
			4,453	4,453
TOTAL OCCUPANT LOAD IN	PROJECT A	REA:	53,577	54,205

IBC 2015 (continued)

Chapter 11 - Accessibility

1101.2 Design. Buildings and facilities shall be designed to be accessible according to this code and ICC A117.1. 1109.2 Toilet and Bathing Facilities. Each toilet room shall be accessible. At least one of each type of fixture, element, control, or dispenser in each accessible toilet room shall be accessible. Exception: Where only one urinal is provided in a room, it is not required to be accessible.

1109.2.2 Water closet compartment. At least 5% of water closet compartments shall be wheelchair accessible. Where combined number of compartments and urinals provided is six or more, 5% of compartments shall be ambulatory accessible, provided in addition to the wheelchair-accessible compartment. 1109.2.3 Lavatories. At least 5% of lavatories provided, but not less than one, shall be accessible. Where total

lavatories provided is six or more, at least one lavatory with enhanced reach ranges shall be provided. (Per ICC A117.1 section 606.5, Where enhanced reach range is required at lavatories, faucet and soap dispenser controls shall have a reach depth of 11 inches maximum or, if automatic, shall be activated within a reach depth of 11 inches maximum).

1109.5 Drinking fountains. 1109.5.1 Minimum number. No fewer than two drinking fountains shall be provided; one complying with requirements for wheelchair-users, and one for standing persons.

1109.5.2 Where more than the minimum number of drinking fountains is provided, 50% shall comply for wheelchairusers and 50% shall comply for standing persons.

1111.2 Directional signage indicating the route to the nearest like accessible element shall be provided at inaccessible public toilets. Directional signs shall include the International Symbol of Accessibility and sign characters shall meet the visual character requirements of ICC A117.1.

E107.2 Signage designations. Signs shall be visual characters, raised characters, and braille complying with ICC A117.1. Where pictograms are provided, they shall have visual characters, raised characters, and braille complying

E107.3 Directional signs shall contain visual characters complying with ICC A117.1.

PROPOSED NEW ROOM ENTRY SIGNAGE IS COMPLIANT WITH IBC, ICC ANSI A117.1 2009 AND ADA REQUIREMENTS - SEE SHEETS A800 AND A801.

Chapter 12 - Interior Environment

Chapter 13 - Energy Efficiency

1205.3 Artificial light shall provide an average illumination of 10 foot-candles over the area of the room at a height of 30" above the floor level.

1205.5 Emergency egress lighting. The means of egress shall be illuminated in accordance with Section 1008.1. 1210.2.1 Floors and wall base finish materials. Toilet room floor finish materials shall have a smooth, hard. nonabsorbent surface. The intersections of such floors with walls shall have a smooth, hard, nonabsorbent vertical base that extends up the wall at least 4 inches.

1210.2.2 Walls and partitions within 2 feet of urinals and water closets shall have a smooth, hard, nonabsorbent surface, to a height of 4 feet above the floor. Accessories provided on or within walls shall be installed and sealed to protect structural elements from moisture.

1301.1.1 Buildings shall be designed and constructed in accordance with the International Energy Conservation

IBC 2015 (continued)

Chapter 29 - Plumbing Systems

2902 Minimum Plumbing Fixtures. Table 2902.1 Minimum Number of Required Plumbing Fixtures - SEE TABLES BELOW

Note: The required plumbing fixture calculation is being provided as a component of this code analysis. Actual existing and proposed new fixture counts in the project area are provided in the second table below.

As most of the proposed work consists of Level 1 alterations, no change is proposed to the plumbing fixture count in those rooms. This data was reviewed by the Industrial Board along with a request to reduce the existing total plumbing fixture count by 6 fixtures over six rooms in order to provide wheelchair-accessible toilet compartments in some rooms.

A VARIANCE TO WAIVE THE REQUIREMENT OF PROVIDING THE MANDATORY NUMBER OF PLUMBING FIXTURES IN ROOMS I, L, M, & X WAS GRANTED BY THE INDUSTRIAL BOARD ON 4/25/2017.

2902.3.2 Location. Toilet facilities shall be located not more than 1 story above or below the space to be served. Path of travel to facilities is not to exceed 500 feet.

2902.4 Signage. A legible sign designating the sex shall be provided in a readily visible location near the entrance to each toilet facility. Signs for accessible toilet facilities shall comply with Section 1111.

2903.2 Urinal partitions. Each urinal shall have partitions to provide privacy. The partitions shall begin at a height not more than 12 inches from and extend to not less than 60 inches above the finished floor surface. The partitions shall extend out from the wall a minimum of 18 inches or not less than 6 inches beyond the front lip of the urinal, whichever is greater.

LOCATION (IN PROJECT AREA)	OCCUPANTS	WATER CLOSETS/URINALS		LAVA	DRINKING	
		MALE	FEMALE	MALE	FEMALE	FOUNT
		1 per 125	1 per 65	1 per 200	1 per 200	1 per
100 Level Meeting Rooms						
- original west block	7,523	30	58	19	19	
100 Level Exhibition Hall F	8,016	32	62	20	20	
200 Level	32,742	131	252	82	82	
300 Level	1,471	6	11	4	4	
Ballroom	4,453	18	34	11	11	

¹ Totals shown are based on occupant loads for assembly spaces in the general project area, not for the entire

LOCATION	WATER CLOSETS/URINALS		LAVATORIES		DRINKING	
	MALE	FEMALE	MALE	FEMALE	FOUNTAINS	
100 Level Meeting Rooms - original west block	28	28	12	20	12	
100 Level Exhibition Hall F	22	26	12	16	4	
200 Level	116	113	62	62	32	
300 Level	8	8	6	6	6	
Ballroom	20	20	12	12	4	
ACTUAL TOTALS1:	194	195	104	116	58	

¹ Totals include public restrooms E and U, recently renovated as prototypes in project area. Totals **do not** include additional gang and family/assisted use toilet rooms in 2011 building expansion, which are open to the original building and can also be accessed by building occupants.

² Variance for decreased plumbing fixture count in rooms I, L, M, & X was granted by Industrial Board on 4/25/2017. ³ Quantity of lavatories increased due to replacement of individual bowl sinks with dual-station trough sink type. ⁴ Drinking fountains are being replaced in kind in project area, in exhibit halls under this contract and in corridors under separate contract.

Contact: Elin Westrick e-mail: ewestrick@cwarc.com

· · · · · CONVERSE

ARCHITECTS:

Ph: 610.664.0806 Fax: 215.664.1075

MEP ENGINEERS:

CONVERSE WINKLER ARCHITECTURE

331 Montgomery Avenue, Bala Cynwyd, PA, 19144

WINKLER ARCHITECTURE 331 MONTGOMERY AVE BALA CYNWYD, PA 19144

Arora Engineers, Inc. **ARORA**° Chadds Ford, PA 19317

P (610) 459-7900 | F (610) 459-7950 | aroraengineers.com


Contact: Kevin Sultanik e-mail: ksultanik@aroraengineers.com

STRUCTURAL ENGINEERS: CSA GROUP 1341 NORTH DELAWARE AVENUE,

SUITE 507 PHILADELPHIA, PA 19125

Ph: 215.427.8700 Fax: 215.427.8752

Contact: Wing Au e-mail: wau@csagroup.com

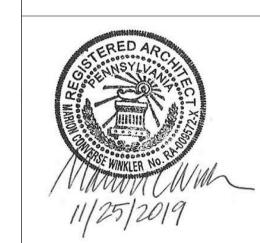

REVISIONS: Description

> /ANIA CENTER PENNSYLV NVENTION

CODE SUMMARY

CW1615 Project number November 25, 2019

KR/LC

EW

Checked by

Drawn by

1/4" = 1'-0"

GENERAL NOTES

1. IN THE DRAWINGS, THE TERM "EXHIBIT" REFERS TO THE ROOM TYPE OF RESTROOMS E, F, G, H, J, K, N, O, P, Q, R, & S. THE TERM "SEMINAR" REFERS TO THE ROOM TYPE OF RESTROOMS A, B, C, D, I, L, M, T, U, V, W, X, Y, & Z. THE TERM "BALLROOM" REFERS TO THE ROOM TYPE OF RESTROOMS A1 & A2.

2. ALL DETAILS, INSTRUCTIONS, NOTES, FINISHES, MATERIALS, AND

- DIMENSIONS SHALL BE CONSIDERED TYPICAL FOR SIMILAR CONDITIONS, UNLESS NOTED OTHERWISE.

 3 ALL NOTES DESCRIBE NEW CONSTRUCTION UNLESS STATED
- ALL NOTES DESCRIBE NEW CONSTRUCTION UNLESS STATED OTHERWISE.
- 4. DO NOT SCALE DRAWINGS. WRITTEN DIMENSIONS TAKE PRECEDENCE OVER SCALED DIMENSIONS.
- 5. ALL DIMENSIONS ARE TO THE FACE OF FINISH MATERIALS UNLESS OTHERWISE NOTED.
- 6. ALL EXISTING CONDITIONS MUST BE FIELD VERIFIED BY CONTRACTOR. ANY DISCREPANCIES BETWEEN THE DRAWINGS AND ACTUAL SITE CONDITIONS SHALL BE BROUGHT TO THE IMMEDIATE ATTENTION OF THE ARCHITECT AND OWNER PRIOR TO PROCEEDING WITH THE WORK.
- 7. THE CONTRACTOR SHALL PROVIDE ALL MATERIALS, LABOR, EQUIPMENT, TRANSPORTATION, AND SERVICES NECESSARY FOR SUCCESSFUL COMPLETION OF THE WORK. ALL WORK SHALL COMPLY WITH APPLICABLE FEDERAL, STATE, AND LOCAL CODES, AND SHALL BE INSTALLED ACCORDING TO THE MANUFACTURER'S SPECIFICATIONS. NOTIFY THE ARCHITECT OF ANY INCONSISTENCY BETWEEN THESE PLANS AND ANY GOVERNING BUILDING CODES AND ORDINANCES.
- 8. THE BUILDING WILL BE OCCUPIED THROUGHOUT CONSTRUCTION.
 THE CONTRACTOR SHALL TAKE ALL MEASURES NECESSARY TO
 PERMIT CONTINUED USE OF THE OCCUPIED AREAS OF THE
 BUILDING DURING CONSTRUCTION, INCLUDING MINIMIZING
 CONSTRUCTION ACCESS THROUGH SUCH AREAS, SECURITY
 AGAINST UNAUTHORIZED ENTRY, PROTECTION FROM DIRT AND
 EYCESS NOISE
- EXCESS NOISE.


 9. THE CONTRACTOR SHALL PROVIDE ALL NECESSARY PERMITS AND
- INSPECTIONS.

 10. THE CONTRACTOR SHALL COORDINATE WORK WITH OWNER'S
- SCHEDULE.

 11. A STAMPED SET OF APPROVED PLANS SHALL BE KEPT AT THE JOB
- SITE AT ALL TIMES.

 12. THE CONTRACTOR IS RESPONSIBLE FOR THE DISPOSAL AND REMOVAL FROM THE SITE OF ALL CONSTRUCTION AND DEMOLITION DEBRIS.
- DEBRIS.

 13. ALSO REFER TO OWNER'S GENERAL CONDITIONS OF THE CONTRACT FOR ADDITIONAL INFORMATION.

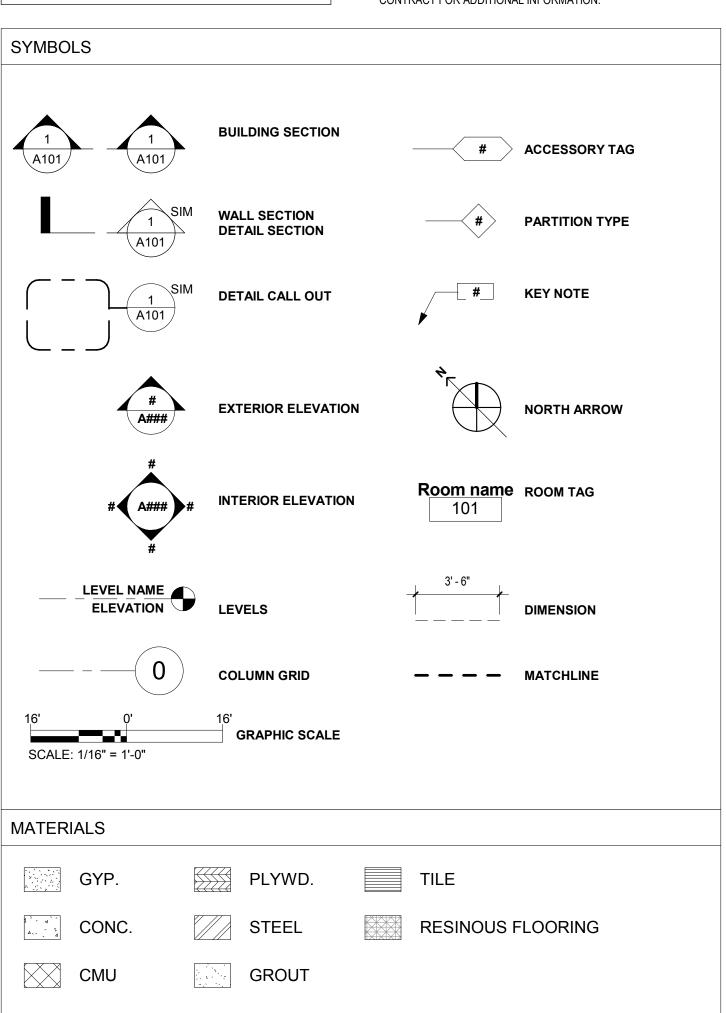

WALL LEGEND


NEW WALL

- - - - - - -

- - - - - -


EXISTING WALL TO REMAIN


WALL TO BE DEMOLISHED

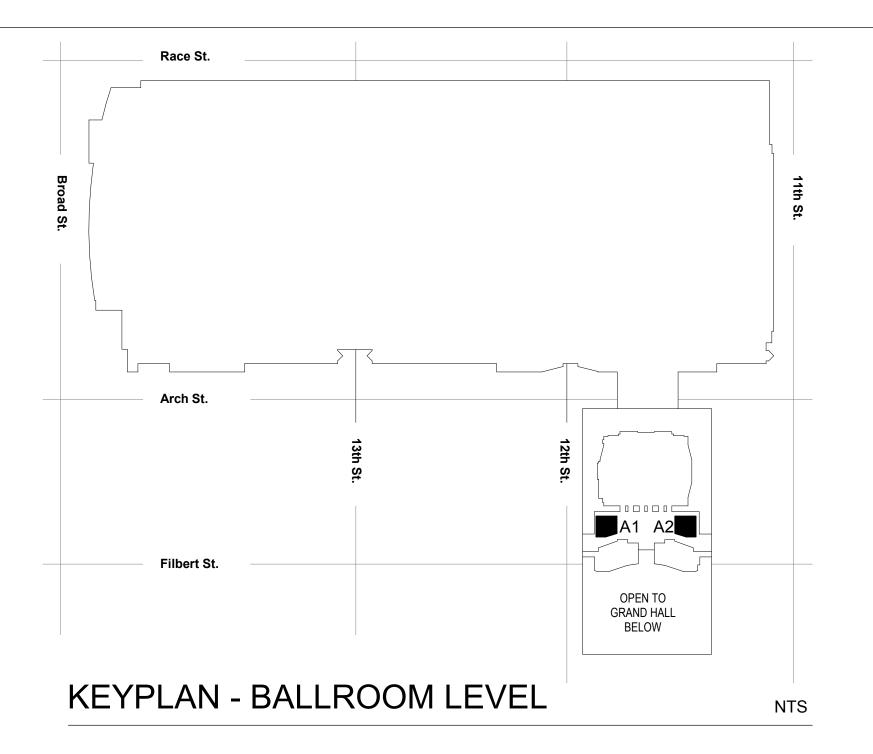



SEE ELECTRICAL DRAWINGS FOR ELECTRICAL PANEL LOCATIONS.

RESTROOMS IN PROJECT

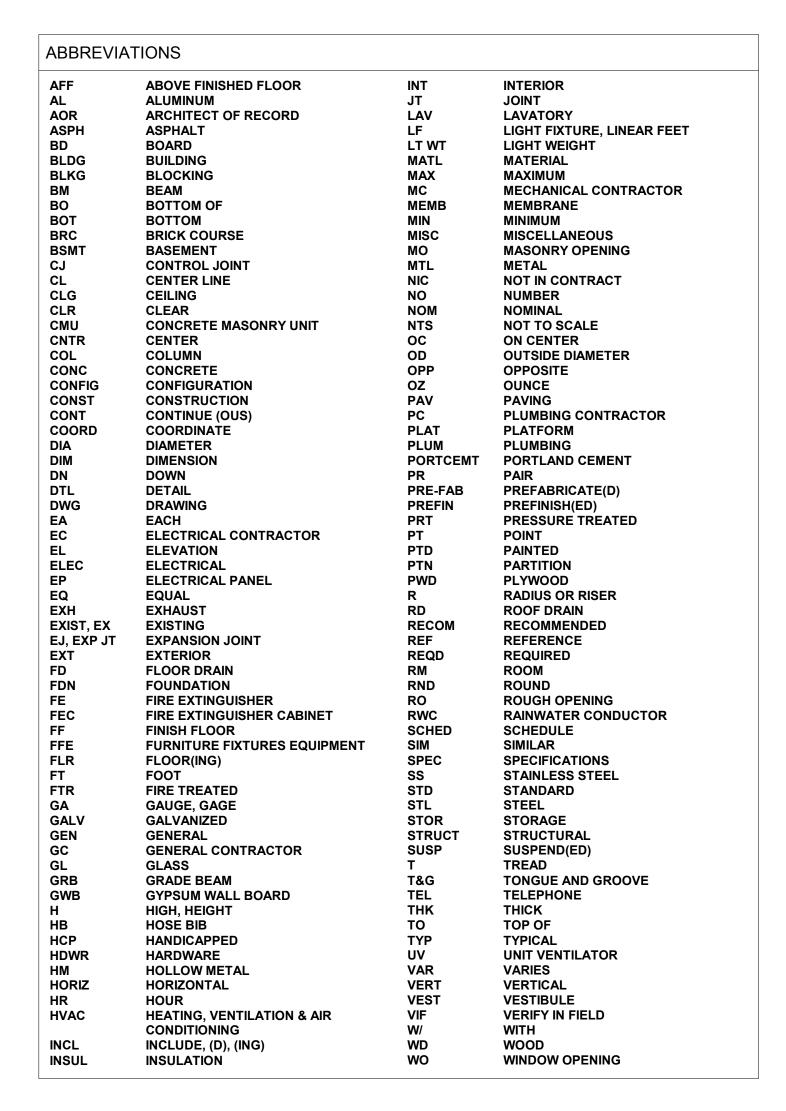

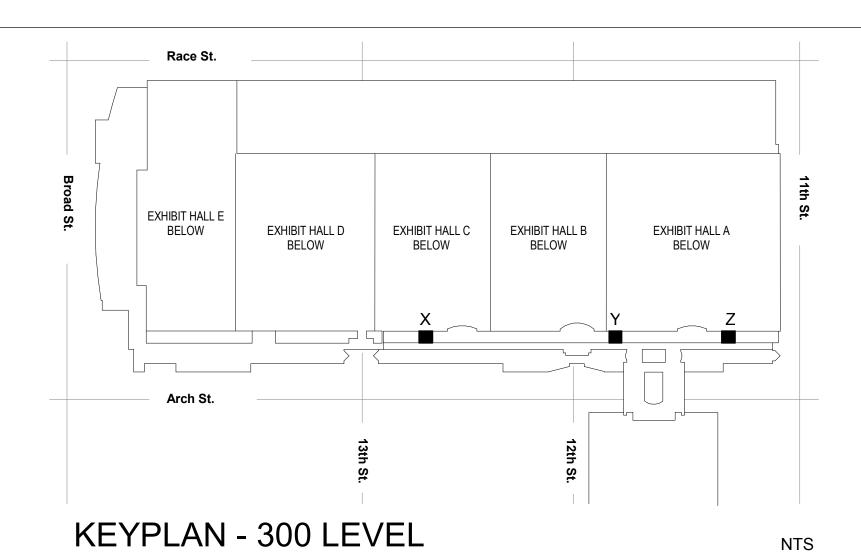

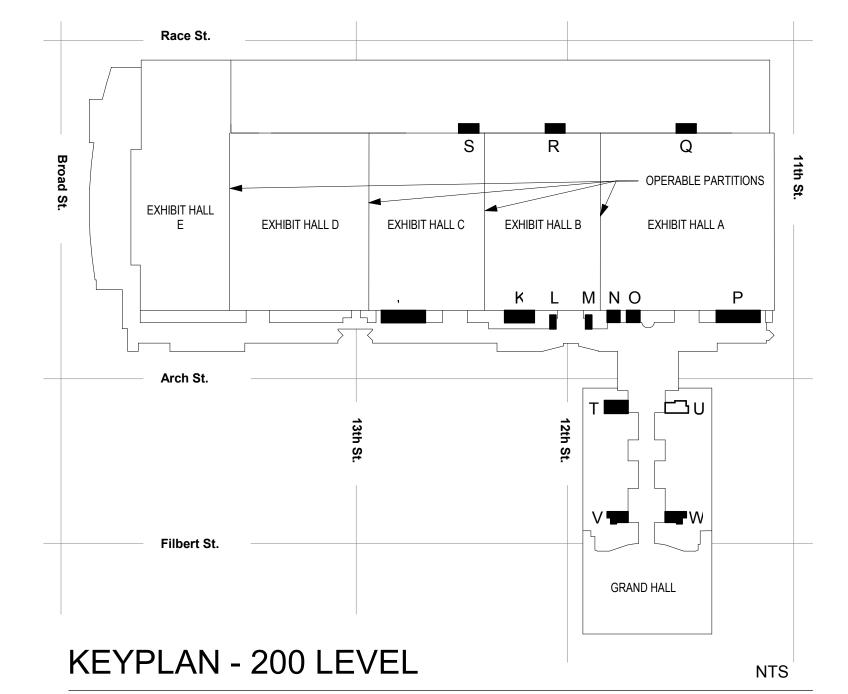

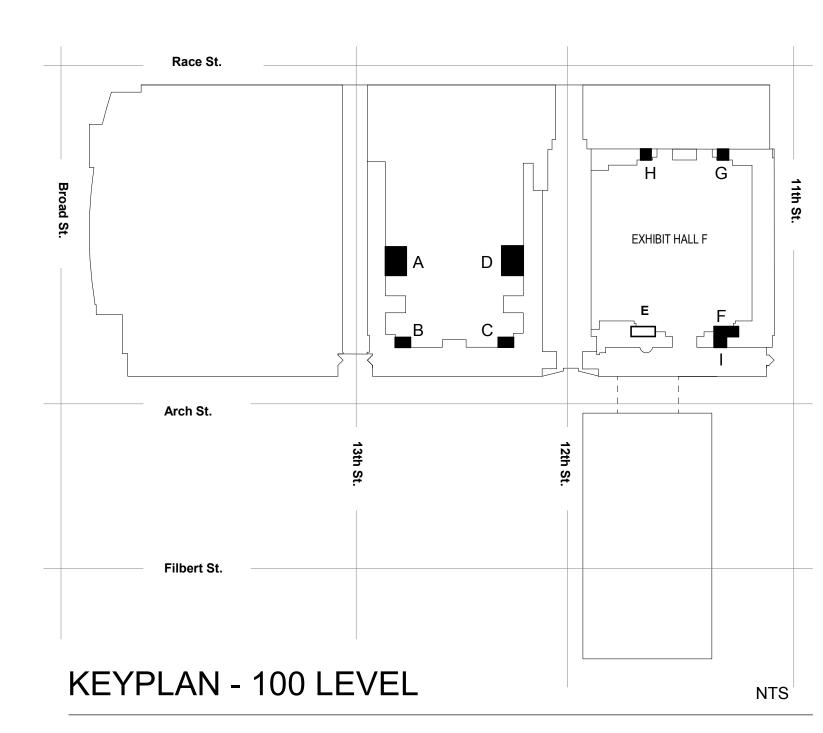



ARCHITECTS: CONVERSE WINKLER ARCHITECTURE 331 Montgomery Avenue, Bala Cynwyd, PA, 19144

Ph: 610.664.0806 Fax: 215.664.1075

Contact: Elin Westrick

e-mail: ewestrick@cwarc.com



P (610) 459-7900 F (610) 459-7950 aroraengineers.com
Contact: Kevin Sultanik
e-mail: ksultanik@aroraengineers.com

STRUCTURAL ENGINEERS:

CSA GROUP
1341 NORTH DELAWARE AVENUE,
SUITE 507
PHILADELPHIA, PA 19125

Ph: 215.427.8700 Fax: 215.427.8752

Contact: Wing Au e-mail: wau@csagroup.com



REVISIONS:

No. Description Date

PENNSYLVANIA
CONVENTION CENTER
RESTROOM RENOVATIONS
1101 ARCH STREET, PHILADELPHIA, PA 19107

GENERAL NOTES, SYMBOLS & KEYPLANS


Project number CW1615

Date November 25, 2019

Drawn by KR/LC

Checked by EW



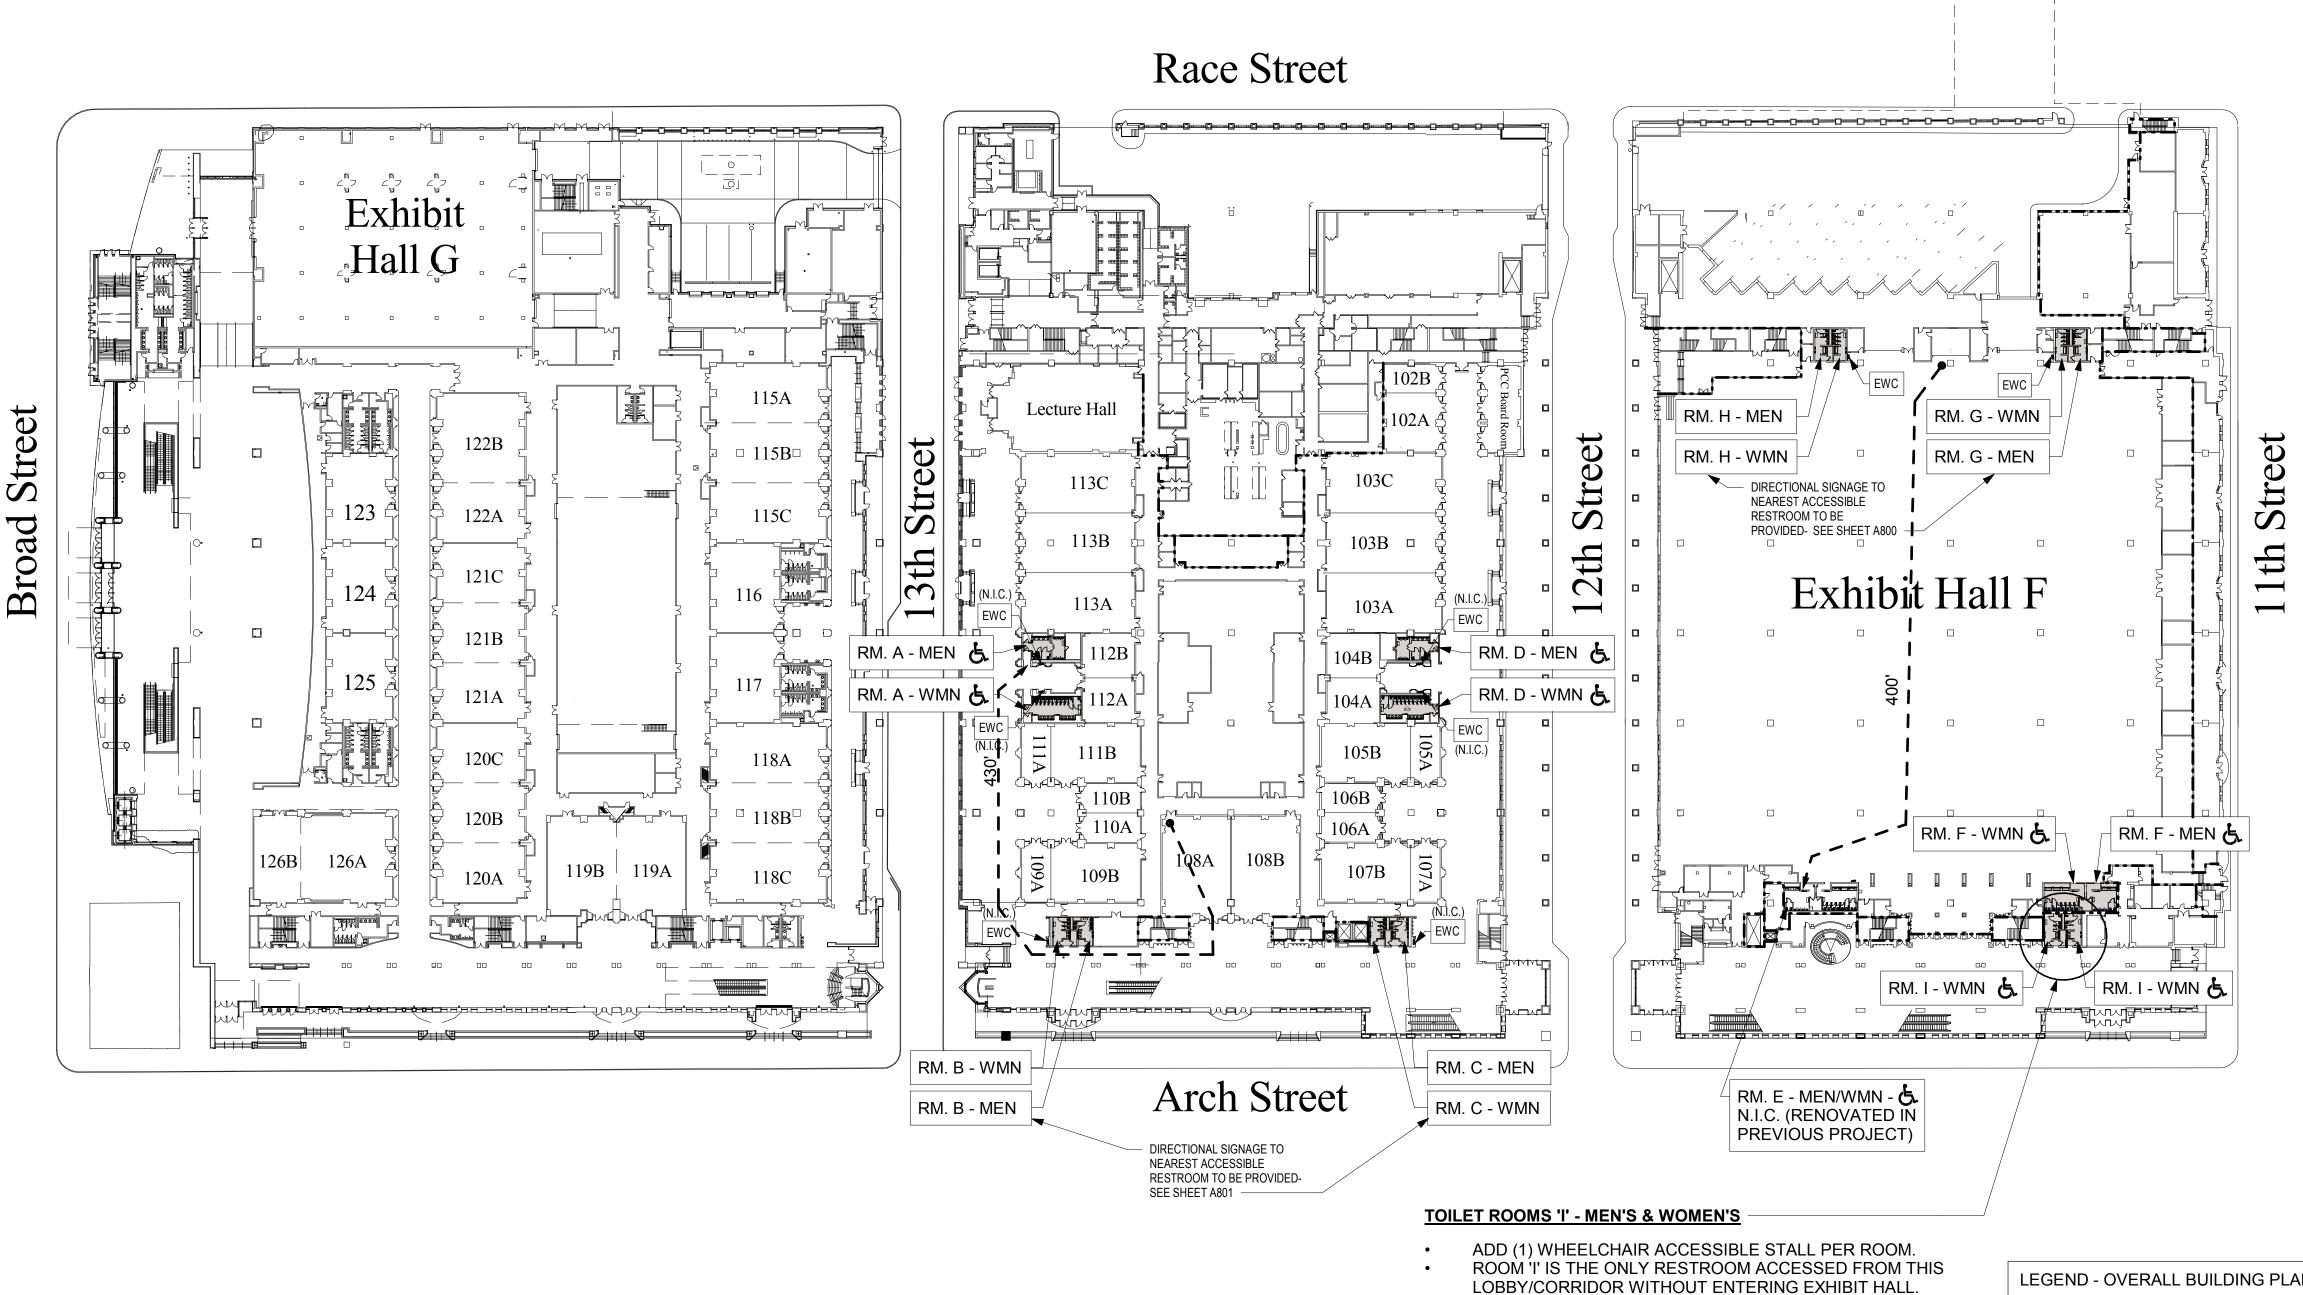

RENOVATION ACCESSIBILITY STRATEGY SUMMARY


- RESTROOMS A, D, F, J, K, P, T, V, W, Y, A1, & A2 CURRENTLY HAVE WHEELCHAIR-ACCESSIBLE TOILET STALLS. WHEELCHAIR STALLS WILL BE RETAINED. AMBULATORY ACCESSIBLE STALLS WILL BE CREATED IN ROOMS WITH SIX OR MORE WATER CLOSETS/URINALS.
- RESTROOMS B, C, G, H, N, O, Q, R, S, & Z CURRENTLY DO NOT HAVE WHEELCHAIR ACCESSIBLE STALLS. ALL OF THESE ROOMS CURRENTLY HAVE AMBULATORY ACCESSIBLE STALLS, WHICH WILL BE RETAINED.
- RESTROOMS I, L, M, & X CURRENTLY DO NOT HAVE WHEELCHAIR-ACCESSIBLE TOILET STALLS. WHEELCHAIR ACCESSIBLE STALLS WILL BE ADDED, THEREBY ELIMINATING TOTAL OF 6 PLUMBING FIXTURES.

VARIANCE FOR DECREASE IN PLUMBING FIXTURE COUNT IN ROOMS I, L, M, & X WAS GRANTED BY INDUSTRIAL BOARD ON 4/25/2017.

PROPOSED ACCESSIBILITY UPGRADES:

- ADD SIX WHEELCHAIR ACCESSIBLE STALLS TO ROOMS 'I', 'L', 'M', & 'X'. 'I' = MEN'S & WOMEN'S (2 STALLS)
 - 'L' = WOMEN'S (1 STALL)
 - 'M' = MEN'S (1 STALL)
- 'X' = MEN'S & WOMEN'S (2 STALLS)
- ADD 14 AMBULATORY ACCESSIBLE STALLS WHERE REQUIRED.

DECREASE TRAVEL DISTANCE TO ACCESSIBLE RESTROOM TO NOT GREATER THAN 500 FEET.

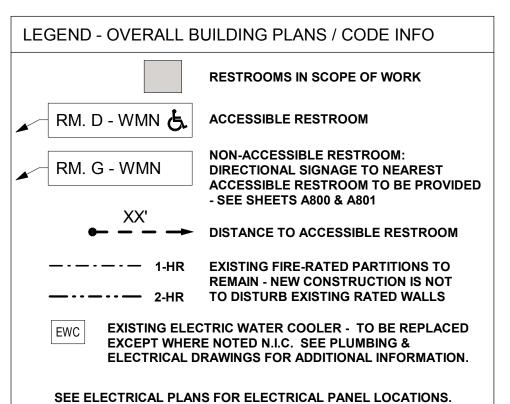

LEVEL 100 (STREET LEVEL) BUILDING PLAN A001 SCALE: 1/64" = 1'-0"



ARCHITECTS:
CONVERSE WINKLER ARCHITECTURE 331 Montgomery Avenue,

Bala Cynwyd, PA, 19144 Ph: 610.664.0806 Fax: 215.664.1075

Contact: Elin Westrick e-mail: ewestrick@cwarc.com

MEP ENGINEERS

61 Wilmington-West Chester Chadds Ford, PA 19317 **ARORA**°

Contact: Kevin Sultanik


e-mail: ksultanik@aroraengineers.com

STRUCTURAL ENGINEERS: CSA GROUP 1341 NORTH DELAWARE AVENUE. SUITE 507

PHILADELPHIA, PA 19125

Ph: 215.427.8700 Fax: 215.427.8752

Contact: Wing Au e-mail: wau@csagroup.com

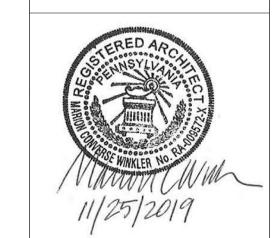

REVISIONS: Description


VANIA N CENTER

RESTROOM RENOVATIONS PENNSYLV, CONVENTION (

OVERALL BUILDING PLANS - LEVEL 100

CW1615 Project number November 25, 2019 KR/LC Drawn by ΕW Checked by

1/64" = 1'-0"

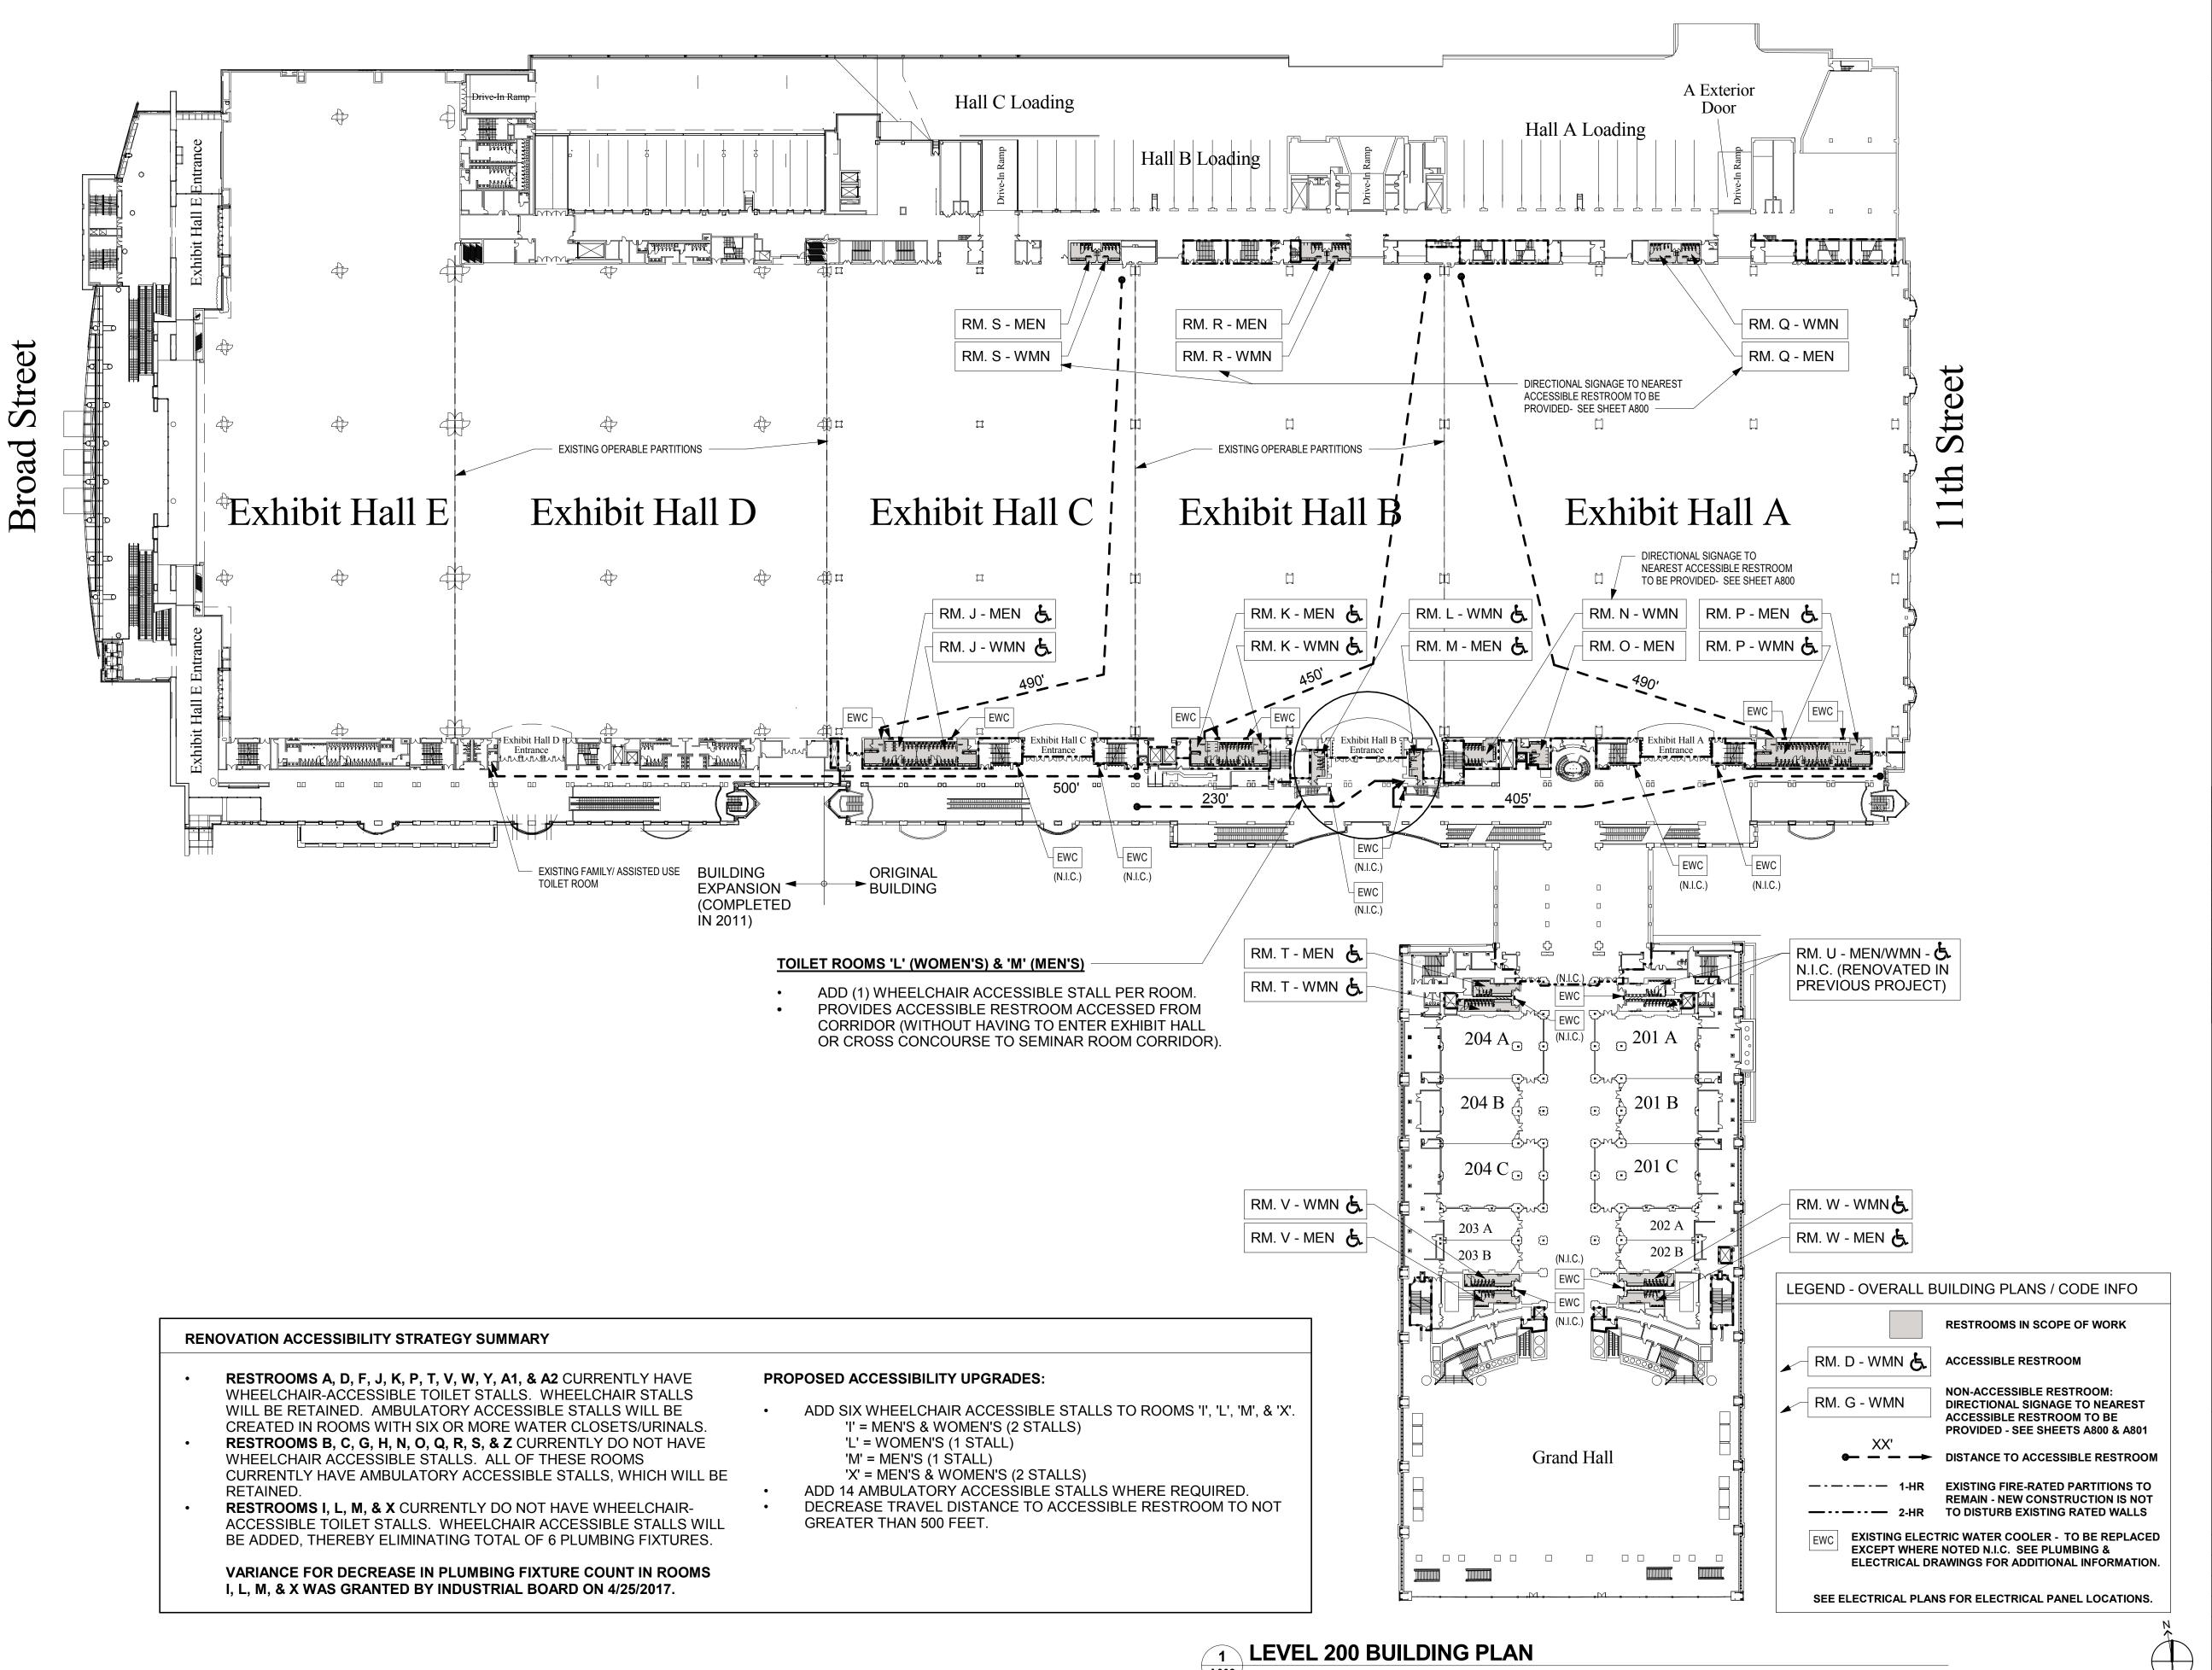

CONVERSE WINKLER ARCHITECTURE 331 MONTGOMERY AVE BALA CYNWYD, PA 19144

ARCHITECTS: CONVERSE WINKLER ARCHITECTURE 331 Montgomery Avenue, Bala Cynwyd, PA, 19144

Ph: 610.664.0806 Fax: 215.664.1075

Contact: Elin Westrick e-mail: ewestrick@cwarc.com

MEP ENGINEERS



Contact: Kevin Sultanik e-mail: ksultanik@aroraengineers.com

STRUCTURAL ENGINEERS: CSA GROUP

1341 NORTH DELAWARE AVENUE, SUITE 507 PHILADELPHIA, PA 19125

Ph: 215.427.8700 Fax: 215.427.8752

Contact: Wing Au e-mail: wau@csagroup.com



REVISIONS: Description

/ANIA CENTER


PENNSYLV, CONVENTION (

OVERALL BUILDING PLANS - LEVEL 200

CW1615 Project number November 25, 2019 KR/LC Drawn by ΕW Checked by

1/64" = 1'-0"

A002 | SCALE: 1/64" = 1'-0"

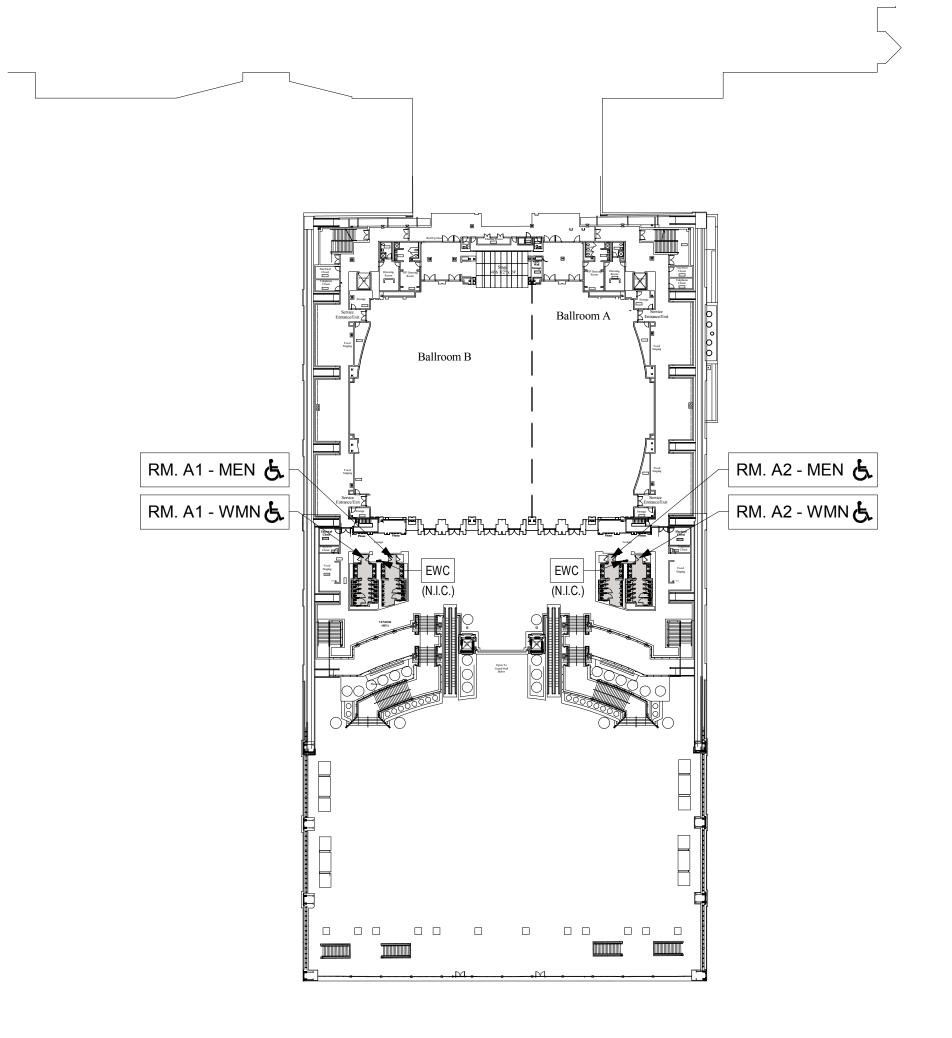


2 BALLROOM LEVEL BUILDING PLAN A003 SCALE: 1/64" = 1'-0"

RM. Z - WMN

DIRECTIONAL SIGNAGE TO NEAREST ACCESSIBLE RESTROOM TO BE

RM. Y - MEN 💍

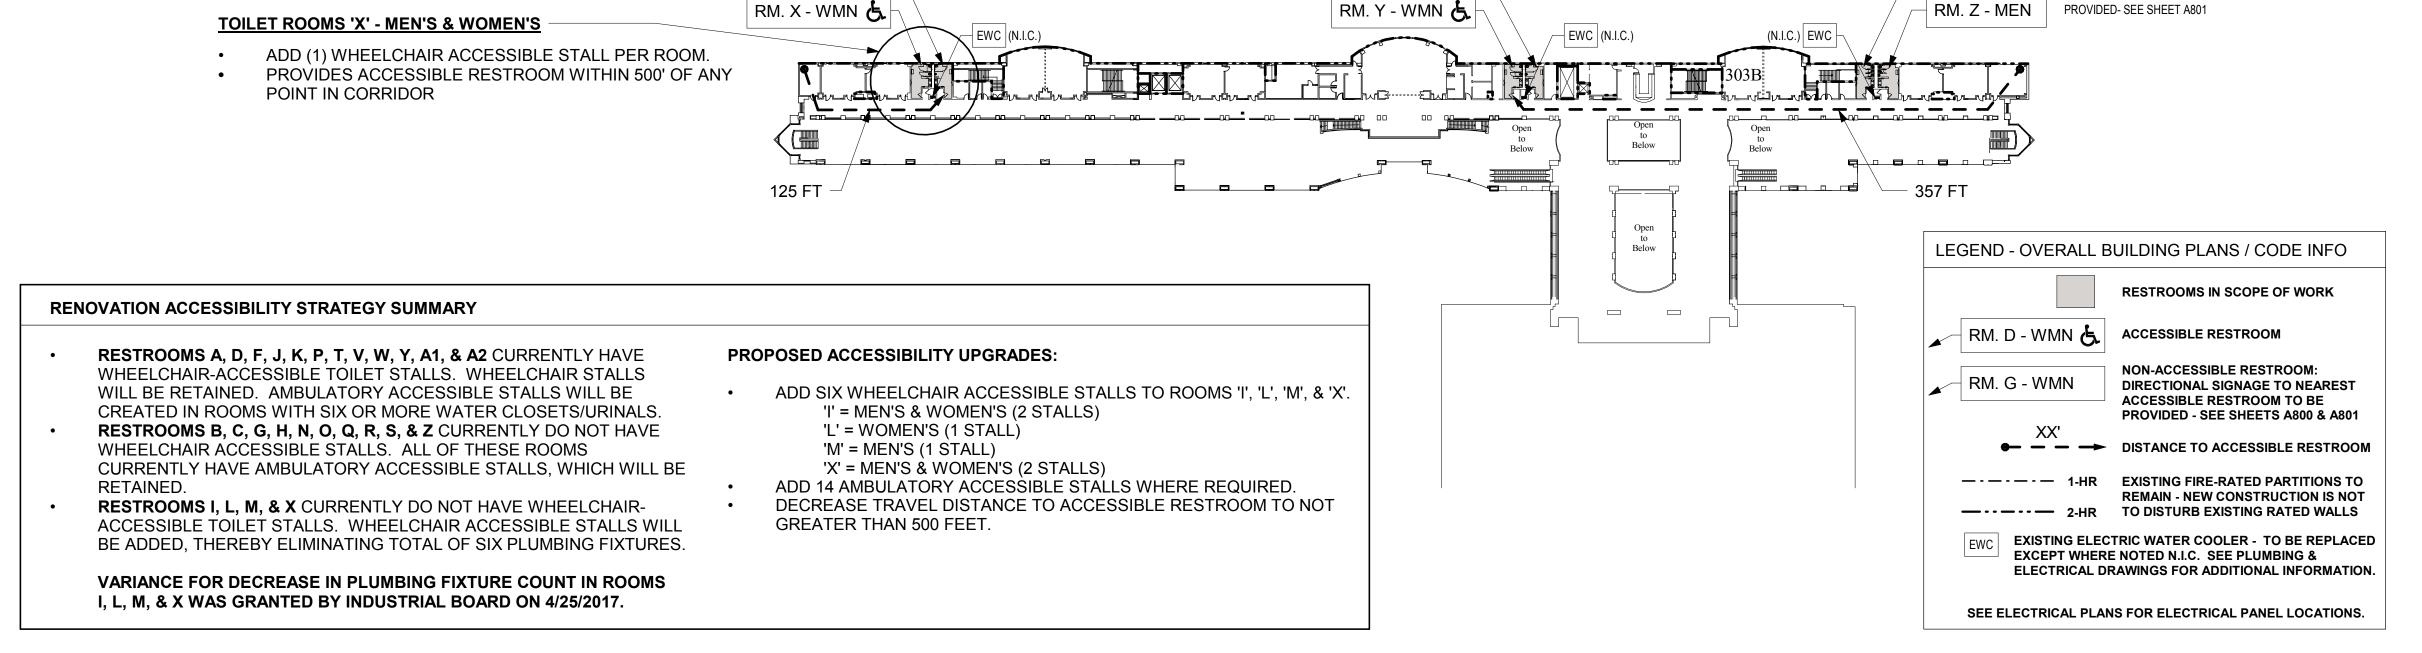

RM. X - MEN

1 LEVEL 300 OVERLOOK BUILDING PLAN
A003 SCALE: 1/64" = 1'-0"



CONVERSE
WINKLER
ARCHITECTURE
331 MONTGOMERY AVE
BALA CYNWYD, PA 19144

ARCHITECTS:
CONVERSE WINKLER
ARCHITECTURE
331 Montgomery Avenue,
Bala Cynwyd, PA, 19144

Ph: 610.664.0806 Fax: 215.664.1075

Contact: Elin Westrick e-mail: ewestrick@cwarc.com

MEP ENGINEERS:

Arora Engi
61 Wilming

ARORA° Arora Engineers, Inc.
61 Wilmington-West Chest
Chadds Ford, PA 19317

P (610) 459-7900 | F (610) 459-7950 | aroraengineers.com

Contact: Kevin Sultanik
e-mail: ksultanik@aroraengineers.com

STRUCTURAL ENGINEERS: CSA GROUP

1341 NORTH DELAWARE AVENUE, SUITE 507 PHILADELPHIA, PA 19125

Ph: 215.427.8700 Fax: 215.427.8752

Contact: Wing Au e-mail: wau@csagroup.com



REVISIONS:

No. Description Date

ANIA CENTER

CONVENTION CENTER

OVERALL
BUILDING PLANS
- LEVEL 300 &
BALLROOM

Project number CW1615

Date November 25, 2019

Drawn by KR/LC

Checked by EW

A003

1/64" = 1'-0"

EXHIBIT HALL N.I.C. (EXCEPT DRINKING FOUNTAINS & SIGNAGE, TYP.) THRESHOLD AT SEE SHEET A800 FOR NEW WALLS IN SAME EXHIBIT HALL, TYP. LOCATION AS EXISTING SIGNAGE INFO. A500.2 30"X48" CLR FLR SPACE CENTERED ON A400 FAUCET ENTRY WALL ENTRY WALL **PANELS PANELS** ST. STL. ST. STL. WALL WALL END CAP END CAP 17' - 2 1/2" V.I.F 30"X48" CLR A502 **WOMEN** 18 FLR SPACE 5' TURNING_ L - - - + J CENTERED ON **RADIUS RADIUS** FAUCET - EXISTING FLOOR (F-W-1) (F-M-1) ~1' - 10 1/2" V.I.F. CLEANOUT 2'-10" | 8" | 2'-2" | 8" | 2'-2" | 8" | 2'-2" | 8" | 2'-2" | 3' - 0" THRESHOLD, A502 TYP. -AMB EXISTING DOORS -SEE GENERAL NOTES EQ EQ JANITOR'S CLOSET EQ EQ EQ N.I.C. 1' - 3" MIN, TYP - J | 1' - 4" | 2' - 8" | 2' - 8" | 2' - 8" 1'-5" 5'-61/2" 3'-0" 2'-11" 2'-11" 2'-11" 1'-51/2" 1'-4" 2'-8" 2'-8" 2'-8" 1'-5" 1'-5" FOR GRAB BAR DIMENSIONS & LOCATIONS, TYP.




F MEN'S - EXISTING



F WOMEN'S- EXISTING

FLOOR PLAN - MEN'S & WOMEN'S ROOM F

A102 | SCALE: 1/4" = 1'-0"

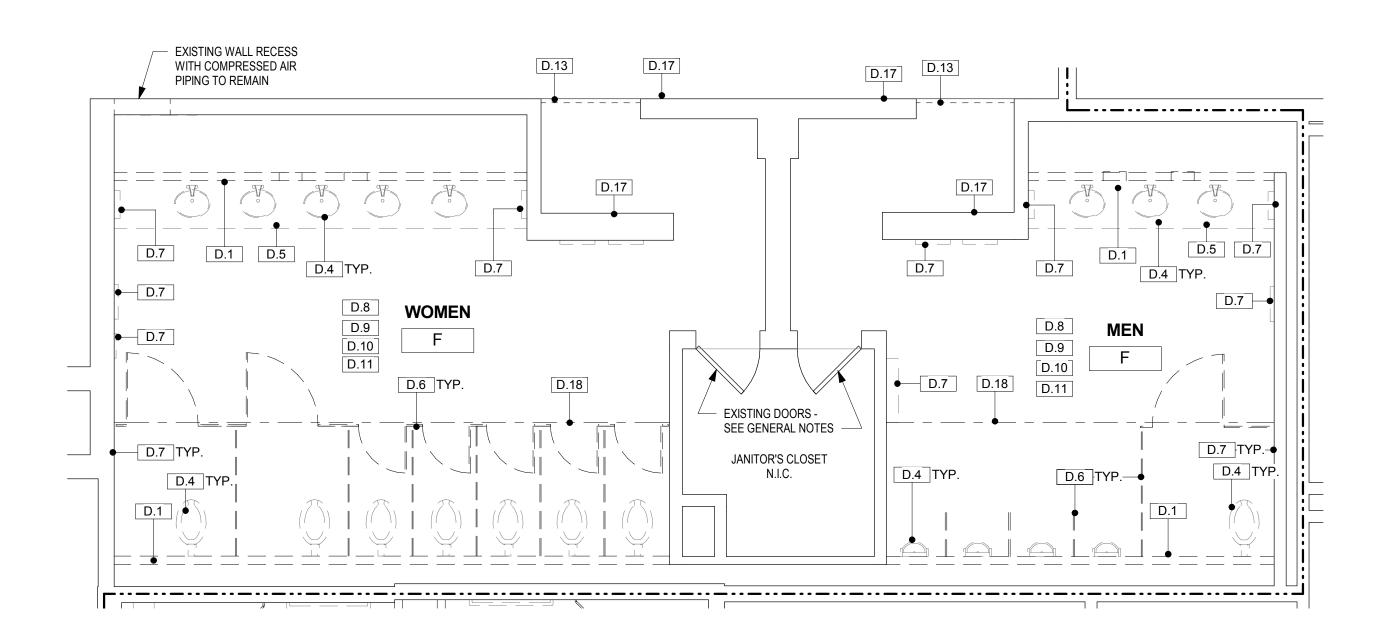

DEMO PLAN - MEN'S & WOMEN'S ROOM F

A102 SCALE: 1/4" = 1'-0"

DRAWING GENERAL NOTES

- 1. JANITOR CLOSET DOORS, HOLLOW METAL FRAMES, AND HARDWARE ARE TO REMAIN AND TO BE REPAINTED AS SCHEDULED. ENTRY DOORS AT SEMINAR- AND BALLROOM-TYPE ROOMS ARE TO BE REPLACED IN KIND IN EXISTING FRAMES. SEE
- DOOR SCHEDULE ON A600.1 FOR ADDITIONAL INFORMATION. 2. JANITOR CLOSETS ARE NOT IN CONTRACT, EXCEPT TO REPAINT INTERIOR AND EXTERIOR OF DOORS AND FRAMES AND TO PROVIDE NEW DOOR THRESHOLDS.
- 3. CONTRACTOR IS TO VERIFY THE CONDITION OF EXISTING SUBSTRATES TO RECEIVE NEW FINISHES AND CONFIRM SUITABILITY. IF EXISTING FLOORS DO NOT MEET MEET ALLOWABLE TOLERANCES PER ANSI STANDARDS FOR LARGE-FORMAT TILE, FLASH FLOORS TO LEVEL. SCRIBE WALL TILE AS NECESSARY TO ACCOMMODATE FLOOR LEVEL WITHIN ALLOWABLE TOLERANCE.
- 4. INFILL AND/OR PATCH FLOORS AND WALLS WHERE TOILET PARTITIONS, ACCESSORIES, OR WALLS REMOVED, AND PROVIDE A SOUND AND LEVEL SURFACE TO RECEIVE NEW FINISH. 5. IN SEMINAR/BALLROOM TYPE ROOMS, EXISTING CERAMIC WALL
- TILE IS TO REMAIN ON WALLS TO REMAIN AND NEW SCHEDULED TILE IS TO BE INSTALLED OVER EXISTING TILE. CONTRACTOR TO VERIFY THAT LEVELNESS OF SURFACE IS WITHIN REQUIRED TOLERANCES FOR SPECIFIED NEW TILE FINISH.

- NOT USED. 7. GC TO VERIFY THICKNESS OF CERAMIC TILE ASSEMBLY TO BE REMOVED AND ACCOUNT FOR ANY DIFFERENCE IN THICKNESS OF NEW TILE ASSEMBLY.
- 8. NEW PLUMBING FIXTURE LOCATIONS DIFFER FROM EXISTING FIXTURE LOCATIONS. FIXTURE CARRIERS AND ASSOCIATED PLUMBING ARE TO BE RELOCATED TO DIMENSIONS SHOWN ON DRAWINGS.
- 9. SEE SHEET A500 FOR ENLARGED PLANS AND ELEVATIONS OF TYPICAL TOILET COMPARTMENTS AND TYPICAL ACCESSORY
- MOUNTING HEIGHTS. 10. SEE SHEET A500.1 FOR PARTITION TYPES. NEW WALLS ARE TO BE CONSTRUCTED IN THE IN SAME LOCATION AS EXISTING
- DEMOLISHED WALLS, UNLESS NOTED OTHERWISE. 11. SEE A600 SERIES SHEETS FOR REFLECTED CEILING PLANS,
- FINISH PLANS, AND FINISH SCHEDULES. 12. SEE OVERALL BUILDING PLANS ON SHEETS A001, A002, & A003 FOR LOCATIONS OF ALL DRINKING FOUNTAINS IN PROJECT.

ACCESSORY/EQUIPMENT LEGEND - EXHIBIT HALL-TYPE RESTROOMS

- 2 PAPER TOWEL DISPENSER AUTO, SEMI-RECESSED
- 3 PAPER TOWEL/TRASH COMBO UNIT AUTO, SEMI-RECESSED
- 4 TRASH SEMI-RECESSED WALL MTD.
- 6 DIAPER CHANGING STATION SURFACE-MTD. (UNLESS
- OTHERWISE NOTED) 8 TOILET PAPER DISPENSER - DUAL JUMBO ROLL (TYP. IN
- EACH STALL) 9 SEAT COVER DISPENSER (TYP. IN EACH STALL)
- (11) SANITARY DISPOSAL (TYP. IN EACH WOMEN'S STALL)
- (14) TOILET PARTITIONS 1 COMPACT LAMINATE (PHENOLIC). FLOOR-MOUNTED & OVERHEAD BRACED, 58" H, 12" A.F.F.; URINAL SCREENS 20" D X 48" H, WALL-MOUNTED
- 18 MIRROR FULL LENGTH 24" X 72"
- (19) MIRROR DOUBLE WIDTH 42" X 54"
- (20) MIRROR SINGLE WIDTH 24" X 54"
- 23 MIRROR SINGLE WIDTH, NARROW 18" X 54"
- 24 MIRROR DOUBLE WIDTH, WIDE 48" X 54" 26 MIRROR - TRIPLE WIDTH, WIDE - 76" X 54"
- NOTE: SEE SPECIFICATIONS FOR ADDITIONAL INFORMATION.



PLANS AND ELEVATIONS.

NO SYMBOL UNLESS OTHERWISE NOTED, TOILET COMPARTMENTS ARE STANDARD.

--- EXISTING 2-HR FIRE RATED WALL (PER AS-BUILT DRAWINGS) TO REMAIN

ADA / ICC ANSI A117.1 REQUIRED CLEARANCES

PARTITION TYPE - SEE SHEET A500.1

DEMOLITION GENERAL NOTES

- 1. SEE PHOTOS ON SOME SHEETS FOR IMAGES OF TYPICAL EXISTING TOILET ROOMS.
- WORK AND MEP DRAWINGS.
- 3. COORDINATE WITH OWNER FOR REMOVED
- AND SIGNAGE TO BE SALVAGED.
- 5. FOR STEEL BEAMS INDICATED TO BE REMOVED, GC BUILDING ELEMENT PRIOR TO DEMOLITION. AS NOT TO DAMAGE ANY ADJACENT
- DURING CONSTRUCTION. CONSTRUCTION. BEAMS APPEAR TO HAVE PARTITIONS, BUT ARE NO LONGER IN USE.

DEMOLITION KEY NOTES

D.1	REMOVE EXISTING 4" CMU CHASE WALL (AT ROOMS T,V, & W, EXISTING WALL IS 4" METAL FRAMING)
D.4	REMOVE EXISTING PLUMBING FIXTURE - SEE PLUMBING DWGS
D.5	REMOVE EXISTING COUNTERTOP & SUPPORT FRAMING
D.6	REMOVE EXISTING TOILET/URINAL PARTITIONS
D.7	REMOVE EXISTING WALL-MOUNTED ACCESSORIES
D.8	REMOVE EXISTING CERAMIC FLOOR TILE TO CONCRETE SLAB
D.9	REMOVE EXISTING CERAMIC WALL TILE & BASE ON ALL INTERIOR WALLS (EXHIBIT ROOMS ONLY, U.N.O.)
D.10	REMOVE EXISTING GWB CEILING, SUPPORT STRUCTURE, & CEILING-MOUNTED DEVICES THROUGHOUT ROOM - SEE MEP

REMOVE EXISTING DOOR THRESHOLD (ALUMINUM THRESHOLD AT EXHIBIT-TYPE ROOMS; MARBLE THRESHOLD AT SEMINAR-TYPE REMOVE EXISTING WALL-MOUNTED SIGNAGE

REMOVE EXISTING LIGHT FIXTURES - SEE ELECTRICAL DWGS.

REMOVE EXISTING STEEL BEAM (6" TO 10" DEEP) ABOVE CEILING

DWGS.

—Arch St. -Filbert St.

KEY PLAN - LEVEL 100



DEMOLITION & NEW FLOOR PLANS - ROOM F (EXHIBIT)

CONVERSE **WINKLER**

ARCHITECTURE 331 MONTGOMERY AVE BALA CYNWYD, PA 19144

ARCHITECTS:

ARCHITECTURE

Ph: 610.664.0806

Fax: 215.664.1075

MEP ENGINEERS:

Contact: Kevin Sultanik

CSA GROUP

Ph: 215.427.8700

Fax: 215.427.8752

Contact: Wing Au

REVISIONS:

VANIA N CENTER

PENNSYLV, CONVENTION (

Description

SUITE 507

STRUCTURAL ENGINEERS:

PHILADELPHIA, PA 19125

e-mail: wau@csagroup.com

Contact: Elin Westrick

e-mail: ewestrick@cwarc.com

P (610) 459-7900 | F (610) 459-7950 | aroraengineers.com

e-mail: ksultanik@aroraengineers.com

1341 NORTH DELAWARE AVENUE,

Arora Engineers, Inc.

Chadds Ford, PA 19317


CONVERSE WINKLER


331 Montgomery Avenue,

Bala Cynwyd, PA, 19144

CW1615 November 25, 2019 Date LC/KR Drawn by ΕW Checked by

- 2. COORDINATE DEMOLITION SCOPE ITEMS WITH NEW
- ACCESSORIES, PLUMBING FIXTURES, LIGHTING FIXTURES, CEILING DEVICES, TOILET PARTITIONS,
- 4. JANITOR CLOSET DOORS TO REMAIN. PROTECT
- TO VERIFY THAT BEAMS ARE NOT SUPPORTING ANY EXERCISE CARE WHEN REMOVING THE BEAMS SO PREVIOUSLY SUPPORTED CEILING-HUNG TOILET

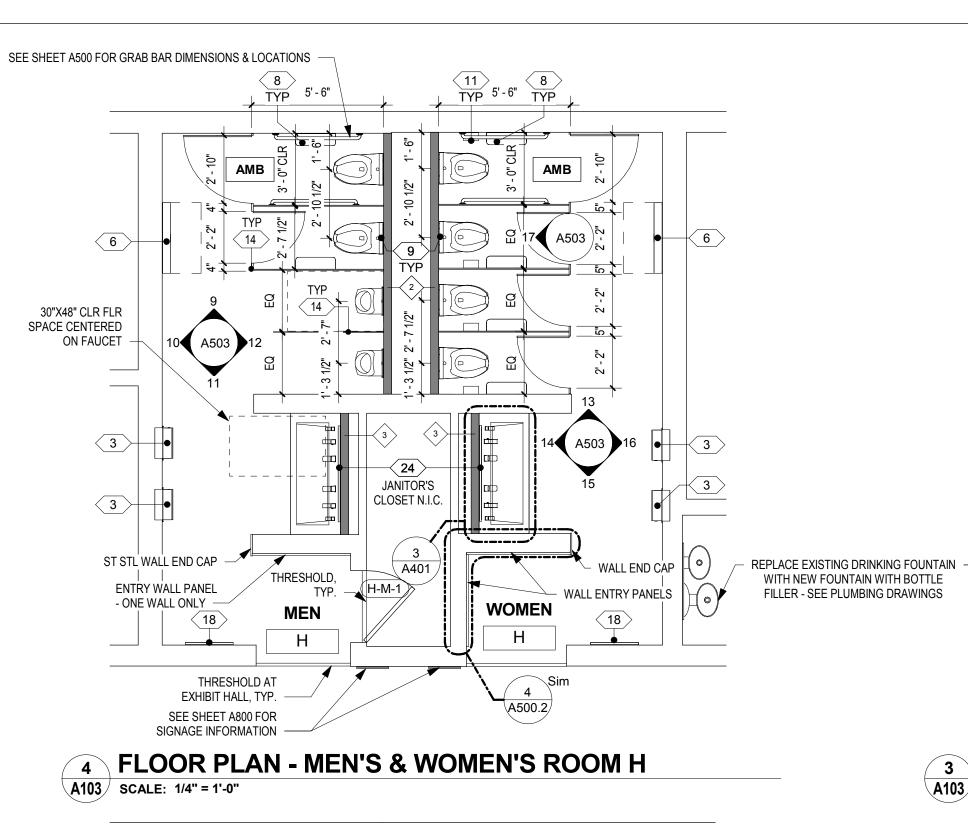

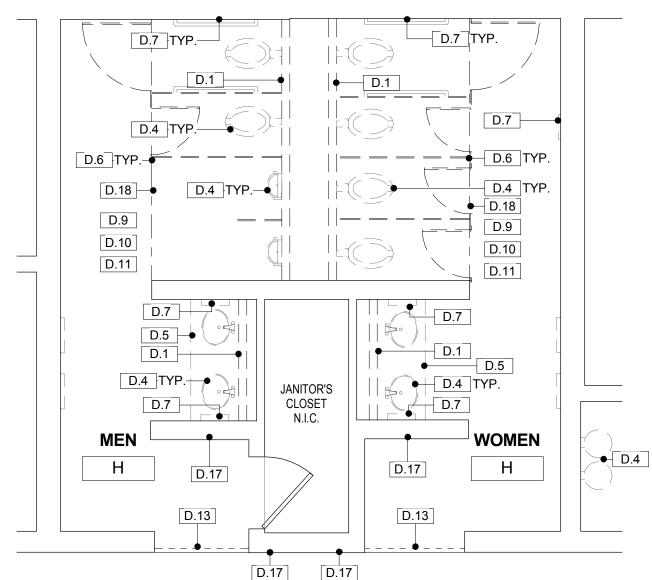


DEMO PLAN - MEN'S & WOMEN'S ROOM H




A103 SCALE: 1/4" = 1'-0"

TYPICAL SMALL EXHIBIT RESTROOM -H MEN'S- EXISTING



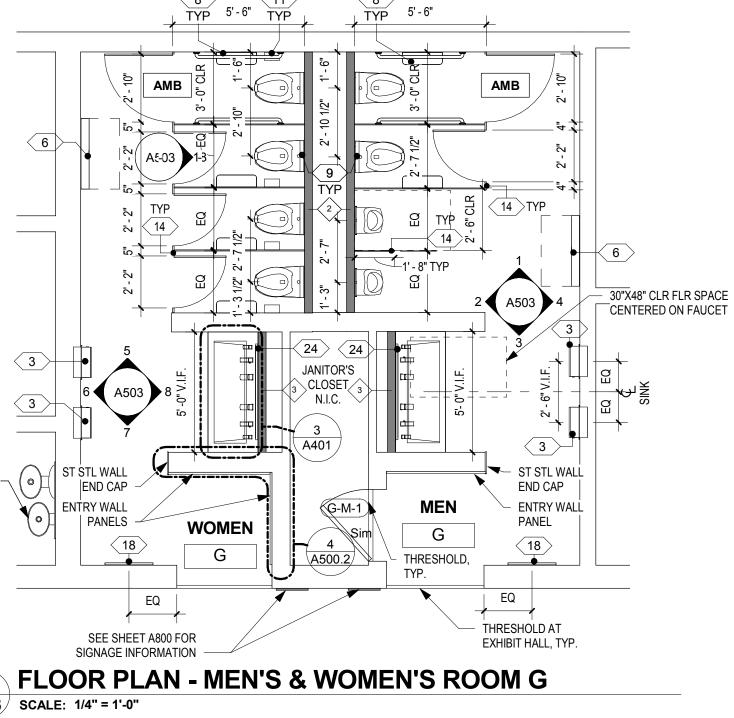

A103 SCALE: 1/4" = 1'-0"

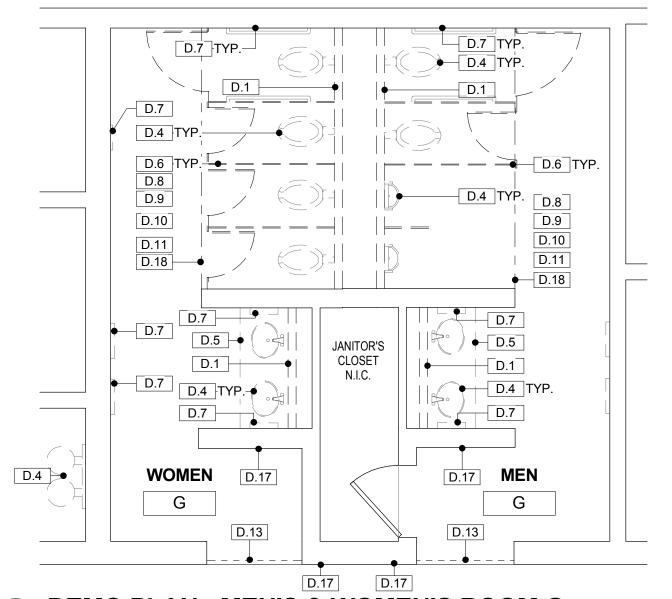

DEMO PLAN - MEN'S & WOMEN'S ROOM G A103 | SCALE: 1/4" = 1'-0"



TYPICAL SMALL EXHIBIT RESTROOM -**G WOMEN'S- EXISTING**



G MEN'S- EXISTING

DRAWING GENERAL NOTES

- 1. JANITOR CLOSET DOORS, HOLLOW METAL FRAMES, AND HARDWARE ARE TO REMAIN AND TO BE REPAINTED AS SCHEDULED. ENTRY DOORS AT SEMINAR- AND BALLROOM-TYPE ROOMS ARE TO BE REPLACED IN KIND IN EXISTING FRAMES. SEE DOOR SCHEDULE ON A600.1 FOR ADDITIONAL INFORMATION.
- 2. JANITOR CLOSETS ARE NOT IN CONTRACT, EXCEPT TO REPAINT INTERIOR AND EXTERIOR OF DOORS AND FRAMES AND TO PROVIDE NEW DOOR THRESHOLDS.
- 3. CONTRACTOR IS TO VERIFY THE CONDITION OF EXISTING SUBSTRATES TO RECEIVE NEW FINISHES AND CONFIRM SUITABILITY. IF EXISTING FLOORS DO NOT MEET MEET ALLOWABLE TOLERANCES PER ANSI STANDARDS FOR LARGE-FORMAT TILE, FLASH FLOORS TO LEVEL. SCRIBE WALL TILE AS NECESSARY TO ACCOMMODATE FLOOR LEVEL WITHIN
- ALLOWABLE TOLERANCE. 4. INFILL AND/OR PATCH FLOORS AND WALLS WHERE TOILET PARTITIONS, ACCESSORIES, OR WALLS REMOVED, AND PROVIDE
- A SOUND AND LEVEL SURFACE TO RECEIVE NEW FINISH. 5. IN SEMINAR/BALLROOM TYPE ROOMS, EXISTING CERAMIC WALL TILE IS TO REMAIN ON WALLS TO REMAIN AND NEW SCHEDULED TILE IS TO BE INSTALLED OVER EXISTING TILE. CONTRACTOR TO VERIFY THAT LEVELNESS OF SURFACE IS WITHIN REQUIRED TOLERANCES FOR SPECIFIED NEW TILE FINISH.

- NOT USED. GC TO VERIFY THICKNESS OF CERAMIC TILE ASSEMBLY TO BE REMOVED AND ACCOUNT FOR ANY DIFFERENCE IN THICKNESS OF NEW TILE ASSEMBLY.
- . NEW PLUMBING FIXTURE LOCATIONS DIFFER FROM EXISTING FIXTURE LOCATIONS. FIXTURE CARRIERS AND ASSOCIATED PLUMBING ARE TO BE RELOCATED TO DIMENSIONS SHOWN ON
- 9. SEE SHEET A500 FOR ENLARGED PLANS AND ELEVATIONS OF TYPICAL TOILET COMPARTMENTS AND TYPICAL ACCESSORY MOUNTING HEIGHTS.
- 10. SEE SHEET A500.1 FOR PARTITION TYPES. NEW WALLS ARE TO BE CONSTRUCTED IN THE IN SAME LOCATION AS EXISTING
- DEMOLISHED WALLS. UNLESS NOTED OTHERWISE. 11. SEE A600 SERIES SHEETS FOR REFLECTED CEILING PLANS. Contact: Elin Westrick FINISH PLANS. AND FINISH SCHEDULES. e-mail: ewestrick@cwarc.com 12. SEE OVERALL BUILDING PLANS ON SHEETS A001, A002, & A003

FOR LOCATIONS OF ALL DRINKING FOUNTAINS IN PROJECT. **MEP ENGINEERS:**

CONVERSE

331 MONTGOMERY AVE BALA CYNWYD, PA 19144

ARCHITECTURE

Arora Engineers, Inc.

Chadds Ford, PA 19317

P (610) 459-7900 | F (610) 459-7950 | aroraengineers.com

e-mail: ksultanik@aroraengineers.com

1341 NORTH DELAWARE AVENUE,

Contact: Kevin Sultanik

CSA GROUP

Ph: 215.427.8700

Fax: 215.427.8752

Contact: Wing Au

REVISIONS:

PENNSYLVANIA CONVENTION CENTER

Description

SUITE 507

STRUCTURAL ENGINEERS:

PHILADELPHIA, PA 19125

e-mail: wau@csagroup.com

WINKLER

ARCHITECTS:

ARCHITECTURE

Ph: 610.664.0806

Fax: 215.664.1075

CONVERSE WINKLER

331 Montgomery Avenue,

Bala Cynwyd, PA, 19144

ACCESSORY/EQUIPMENT LEGEND - EXHIBIT HALL-TYPE RESTROOMS

- 2 PAPER TOWEL DISPENSER AUTO, SEMI-RECESSED
- 3 PAPER TOWEL/TRASH COMBO UNIT AUTO, SEMI-RECESSED
- 4 TRASH SEMI-RECESSED WALL MTD.
- 6 DIAPER CHANGING STATION SURFACE-MTD. (UNLESS OTHERWISE NOTED)
- 8 TOILET PAPER DISPENSER DUAL JUMBO ROLL (TYP. IN
- EACH STALL) 9 SEAT COVER DISPENSER (TYP. IN EACH STALL)
- (11) SANITARY DISPOSAL (TYP. IN EACH WOMEN'S STALL)
- (14) TOILET PARTITIONS 1 COMPACT LAMINATE (PHENOLIC), FLOOR-MOUNTED & OVERHEAD BRACED, 58" H, 12" A.F.F.; URINAL SCREENS 20" D X 48" H, WALL-MOUNTED
- (18) MIRROR FULL LENGTH 24" X 72"
- 19 MIRROR DOUBLE WIDTH 42" X 54"
- 20 MIRROR SINGLE WIDTH 24" X 54"
- 23 MIRROR SINGLE WIDTH, NARROW 18" X 54"
- 24 MIRROR DOUBLE WIDTH, WIDE 48" X 54" 26 MIRROR - TRIPLE WIDTH, WIDE - 76" X 54"
- NOTE: SEE SPECIFICATIONS FOR ADDITIONAL INFORMATION.



NO SYMBOL UNLESS OTHERWISE NOTED, TOILET COMPARTMENTS ARE STANDARD.

ADA / ICC ANSI A117.1 REQUIRED CLEARANCES

PARTITION TYPE - SEE SHEET A500.1

--- EXISTING 2-HR FIRE RATED WALL (PER AS-BUILT DRAWINGS) TO REMAIN


1. SEE PHOTOS ON SOME SHEETS FOR IMAGES OF

DEMOLITION GENERAL NOTES


- 2. COORDINATE DEMOLITION SCOPE ITEMS WITH NEW
- WORK AND MEP DRAWINGS. 3. COORDINATE WITH OWNER FOR REMOVED ACCESSORIES, PLUMBING FIXTURES, LIGHTING FIXTURES, CEILING DEVICES, TOILET PARTITIONS,

AND SIGNAGE TO BE SALVAGED.
JANITOR CLOSET DOORS TO REMAIN. PROTECT
DURING CONSTRUCTION.
FOR STEEL BEAMS INDICATED TO BE REMOVED, GC
TO VERIFY THAT BEAMS ARE NOT SUPPORTING ANY
BUILDING ELEMENT PRIOR TO DEMOLITION.
EXERCISE CARE WHEN REMOVING THE BEAMS SO
AS NOT TO DAMAGE ANY ADJACENT
CONSTRUCTION. BEAMS APPEAR TO HAVE
PREVIOUSLY SUPPORTED CEILING-HUNG TOILET
PARTITIONS, BUT ARE NO LONGER IN USE.

DEMOLITION KEY NOTES				
D.1	REMOVE EXISTING 4" CMU CHASE WALL (AT ROOMS T,V, & W, EXISTING WALL IS 4" METAL FRAMING)			
D.4	REMOVE EXISTING PLUMBING FIXTURE - SEE PLUMBING DWGS			
D.5	REMOVE EXISTING COUNTERTOP & SUPPORT FRAMING			
D.6	REMOVE EXISTING TOILET/URINAL PARTITIONS			
D.7	REMOVE EXISTING WALL-MOUNTED ACCESSORIES			
D.8	REMOVE EXISTING CERAMIC FLOOR TILE TO CONCRETE SLAB			
D.9	REMOVE EXISTING CERAMIC WALL TILE & BASE ON ALL INTERIOR WALLS (EXHIBIT ROOMS ONLY, U.N.O.)			
D.10	REMOVE EXISTING GWB CEILING, SUPPORT STRUCTURE, & CEILING-MOUNTED DEVICES THROUGHOUT ROOM - SEE MEP DWGS.			
D.11	REMOVE EXISTING LIGHT FIXTURES - SEE ELECTRICAL DWGS.			
D.13	REMOVE EXISTING DOOR THRESHOLD (ALUMINUM THRESHOLD AT EXHIBIT-TYPE ROOMS; MARBLE THRESHOLD AT SEMINAR-TYPE ROOMS)			
D.17	REMOVE EXISTING WALL-MOUNTED SIGNAGE			
D.18	REMOVE EXISTING STEEL BEAM (6" TO 10" DEEP) ABOVE CEILING			

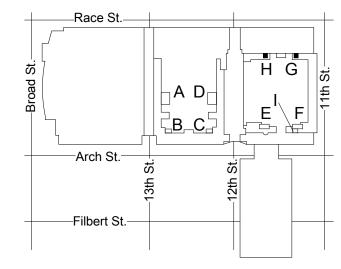

KEY PLAN - LEVEL 100

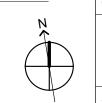

DEMOLITION & NEW FLOOR PLANS - ROOMS G & H (EXHIBIT)

CW1615 Project number November 25, 2019 LC/KR Drawn by EW Checked by

A103



JANITOR'S CLOSET

THRESHOLD, TYP.

RADIUS

10' - 2" V.I.F.

A400

30"X48" CLR

FLR SPACE

CENTERED

ON FAUCET

J MEN'S - EXISTING

ENTRY WALL

ST. STL. WALL

PANELS

END CAP

A504

EQ



PATCH

FLOOR

WHERE

WALLS

REMOVED

TYPICAL LARGE EXHIBIT RESTROOM -J WOMEN'S- EXISTING

1' - 6"

SEE SHEET A800 FOR SIGNAGE INFORMATION

REPLACE EXISTING DRINKING FOUNTAIN

WITH NEW FOUNTAIN WITH BOTTLE

FILLER - SEE PLUMBING DRAWINGS

FULL-HEIGHT

1 > CHASE WALL

PARTIAL

CHASE WALL ₹

_ FIXEDJTRACK

5' - 6"

AROUND 3 SIDES

HEIGHT

WHEELCHAIR ACCESSIBLE TOILET COMPARTMENT - SEE A500 FOR TYPICAL ENLARGED PLANS AND ELEVATIONS.

AMBULATORY ACCESSIBLE TOILET COMPARTMENT - SEE A500 FOR TYPICAL ENLARGED PLANS AND ELEVATIONS.

NO SYMBOL UNLESS OTHERWISE NOTED, TOILET COMPARTMENTS ARE STANDARD.

ADA / ICC ANSI A117.1 REQUIRED CLEARANCES

EXISTING 2-HR FIRE RATED WALL (PER AS-BUILT DRAWINGS) TO REMAIN

EQ A

2' - 2" | 10" | 2' - 2" | 10" | 2' - 2"

2' - 2" | 10" | 2' - 2" | 10" | 2' - 2"

(14)

REMOVABLE PANEL IN FIXED 3-SIDED TRACK -

TO MATCH TYPE IN

RESTROOMS

NEWER EXHIBIT HALL

EQ A

2' - 11 1/2" 1' - 5 1/2" 1' - 5 3/4" 3' - 0"

EQ A

PARTITION TYPE - SEE SHEET A500.1

2' - 11 1/2" 1' - 5 1/2" 1' - 5 1/2"

EQ A

ACCESSORY/EQUIPMENT LEGEND - EXHIBIT HALL-TYPE RESTROOMS

- 2 PAPER TOWEL DISPENSER AUTO, SEMI-RECESSED < 14 > TOILET PARTITIONS 1 - COMPACT LAMINATE (PHENOLIC),
- 3 > PAPER TOWEL/TRASH COMBO UNIT AUTO, SEMI-RECESSED 4 TRASH - SEMI-RECESSED WALL MTD.
- 6 DIAPER CHANGING STATION SURFACE-MTD. (UNLESS
- OTHERWISE NOTED)
- 8 TOILET PAPER DISPENSER DUAL JUMBO ROLL (TYP. IN EACH STALL)
- 9 SEAT COVER DISPENSER (TYP. IN EACH STALL)

3' - 0" ¯

EQ B

⁻3' - 0"

EQ B

<11 > SANITARY DISPOSAL (TYP. IN EACH WOMEN'S STALL)

SEE SHEET A800 FOR SIGNAGE INFORMATION -

REPLACE EXISTING DRINKING FOUNTAIN

EQ B

2' - 2" | 10" | 2' - 2" | 10" | 2' - 2"

FIXED TRACK AROUND

EQ B

AMB

WITH NEW FOUNTAIN WITH BOTTLE

FILLER - SEE PLUMBING DRAWINGS

EQ B

FLOOR-MOUNTED & OVERHEAD BRACED, 58" H, 12" A.F.F.; URINAL SCREENS 20" D X 48" H, WALL-MOUNTED

NOTE: SEE SPECIFICATIONS FOR ADDITIONAL INFORMATION.

THRESHOLD AT

- ENTRY WALL PANELS

ST STL WALL END CAP

(J-W-1)

10' - 0 3/4" V.I.F

WOMEN

14' - 8 1/2" V.I.F.

THRESHOLD, TYP.

JANITOR'S CLOSET

EXHIBIT HALL, TYP.

A500.2

(18)

A504

_ EQ

< 19 MIRROR - DOUBLE WIDTH - 42" X 54"

<23 MIRROR - SINGLE WIDTH, NARROW - 18" X 54"</p>

24 MIRROR - DOUBLE WIDTH, WIDE - 48" X 54"

26 MIRROR - TRIPLE WIDTH, WIDE - 76" X 54"

< 20 > MIRROR - SINGLE WIDTH - 24" X 54"


- 1. JANITOR CLOSET DOORS, HOLLOW METAL FRAMES, AND HARDWARE ARE TO REMAIN AND TO BE REPAINTED AS SCHEDULED. ENTRY DOORS AT SEMINAR- AND BALLROOM-TYPE < 18 > MIRROR - FULL LENGTH - 24" X 72"
 - DOOR SCHEDULE ON A600.1 FOR ADDITIONAL INFORMATION. 2. JANITOR CLOSETS ARE NOT IN CONTRACT, EXCEPT TO REPAINT

 - SUBSTRATES TO RECEIVE NEW FINISHES AND CONFIRM SUITABILITY. IF EXISTING FLOORS DO NOT MEET MEET ALLOWABLE TOLERANCES PER ANSI STANDARDS FOR LARGE-FORMAT TILE, FLASH FLOORS TO LEVEL. SCRIBE WALL TILE AS NECESSARY TO ACCOMMODATE FLOOR LEVEL WITHIN
 - 4. INFILL AND/OR PATCH FLOORS AND WALLS WHERE TOILET PARTITIONS, ACCESSORIES, OR WALLS REMOVED, AND PROVIDE A SOUND AND LEVEL SURFACE TO RECEIVE NEW FINISH.
 - 5. IN SEMINAR/BALLROOM TYPE ROOMS, EXISTING CERAMIC WALL TILE IS TO REMAIN ON WALLS TO REMAIN AND NEW SCHEDULED TILE IS TO BE INSTALLED OVER EXISTING TILE. CONTRACTOR TO
 - NOT USED. 7. GC TO VERIFY THICKNESS OF CERAMIC TILE ASSEMBLY TO BE
 - FIXTURE LOCATIONS. FIXTURE CARRIERS AND ASSOCIATED PLUMBING ARE TO BE RELOCATED TO DIMENSIONS SHOWN ON
 - TYPICAL TOILET COMPARTMENTS AND TYPICAL ACCESSORY
 - MOUNTING HEIGHTS. 10. SEE SHEET A500.1 FOR PARTITION TYPES. NEW WALLS ARE TO BE CONSTRUCTED IN THE IN SAME LOCATION AS EXISTING
 - DEMOLISHED WALLS, UNLESS NOTED OTHERWISE. 11. SEE A600 SERIES SHEETS FOR REFLECTED CEILING PLANS,
 - 12. SEE OVERALL BUILDING PLANS ON SHEETS A001, A002, & A003 FOR LOCATIONS OF ALL DRINKING FOUNTAINS IN PROJECT.

DEMOLITION GENERAL NOTES

- 1. SEE PHOTOS ON SOME SHEETS FOR IMAGES OF
- 2. COORDINATE DEMOLITION SCOPE ITEMS WITH NEW WORK AND MEP DRAWINGS.
- ACCESSORIES, PLUMBING FIXTURES, LIGHTING FIXTURES, CEILING DEVICES, TOILET PARTITIONS,
- 4. JANITOR CLOSET DOORS TO REMAIN. PROTECT DURING CONSTRUCTION.
- BUILDING ELEMENT PRIOR TO DEMOLITION. AS NOT TO DAMAGE ANY ADJACENT CONSTRUCTION. BEAMS APPEAR TO HAVE PARTITIONS, BUT ARE NO LONGER IN USE.

D.1	REMOVE EXISTING 4" CMU CHASE WALL (AT ROOMS T,V, & W, EXISTING WALL IS 4" METAL FRAMING)
D.3	REMOVE PORTION OF EXISTING WALL
D.4	REMOVE EXISTING PLUMBING FIXTURE - SEE PLUMBING DWGS
D.5	REMOVE EXISTING COUNTERTOP & SUPPORT FRAMING
D.6	REMOVE EXISTING TOILET/URINAL PARTITIONS
D.7	REMOVE EXISTING WALL-MOUNTED ACCESSORIES
D.8	REMOVE EXISTING CERAMIC FLOOR TILE TO CONCRETE SLAB
D.9	REMOVE EXISTING CERAMIC WALL TILE & BASE ON ALL INTERIOR WALLS (EXHIBIT ROOMS ONLY, U.N.O.)
D.10	REMOVE EXISTING GWB CEILING, SUPPORT STRUCTURE, & CEILING-MOUNTED DEVICES THROUGHOUT ROOM - SEE MEP DWGS.
D.11	REMOVE EXISTING LIGHT FIXTURES - SEE ELECTRICAL DWGS.
D.12	REMOVE EXISTING MOVABLE ROOM-DIVIDING PANEL & FIXED FRAME
D.13	REMOVE EXISTING DOOR THRESHOLD (ALUMINUM THRESHOLD AT EXHIBIT-TYPE ROOMS; MARBLE THRESHOLD AT SEMINAR-TYPE ROOMS)
D.14	REMOVE EXISTING PLUMBING & CAP BELOW FLOOR/ABOVE CEILING (WHERE WALL RECONFIGURED)
D.17	REMOVE EXISTING WALL-MOUNTED SIGNAGE

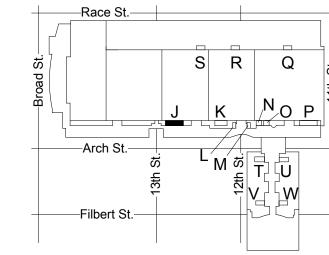

KEY PLAN - LEVEL 200

November 25, 2019 Date Drawn by LC/KR ΕW Checked by

DEMOLITION &

NEW FLOOR


PLANS - ROOM J

(EXHIBIT)

14' - 10" V.I.F. EQ A EQ B EQ A 2' - 11 1/4" EQ A 3' - 0" 3' - 0" 1' - 5 1/2" 2' - 11 1/2" 1' - 5 1/2" 1' - 5 1/2" 3' - 0" 2" | 3'-0" | 1'-51/2" | 1'-51/2" | SEE SHEET A500 FOR GRAB BAR FURR WALL TO ALIGN WITH DIMENSIONS & LOCATIONS URINAL WALL OPPOSITE, SIM TO PARTITION TYPE 4 -FLOOR DRAIN CENTERED UNDER FLOOR DRAIN CENTERED UNDER TOILET PARTITION, 3'-0" FROM WALL TOILET PARTITION, 3'-0" FROM WALL

10" 2' - 2" 10" 2' - 2"

FLOOR PLAN - MEN'S & WOMEN'S ROOM J

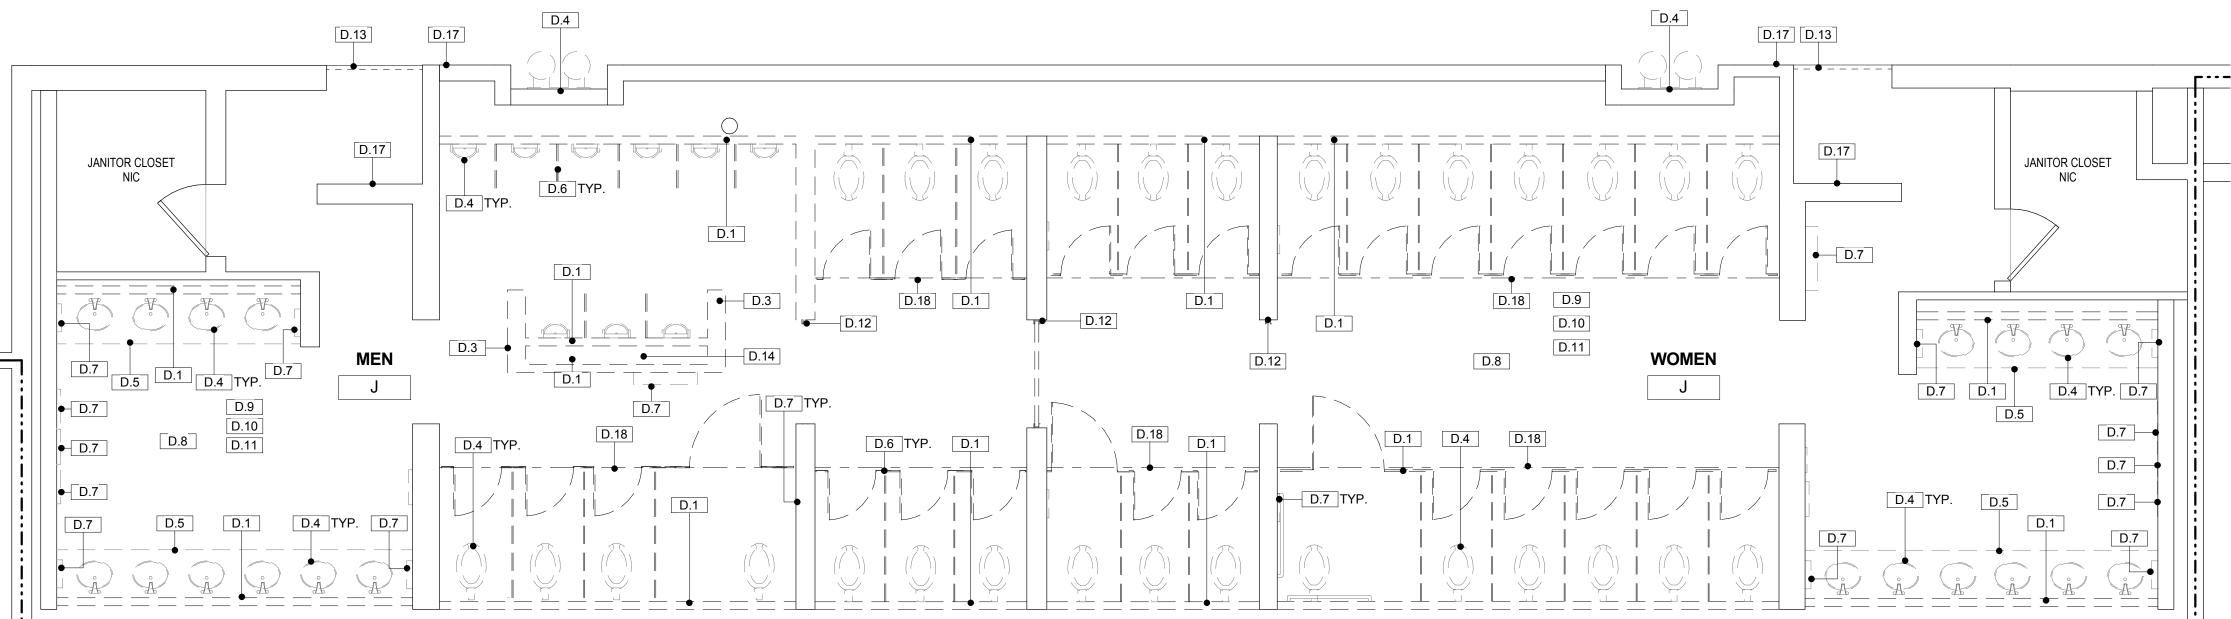

DEMO PLAN - MEN'S & WOMEN'S ROOM J A104 SCALE: 1/4" = 1'-0"

DRAWING GENERAL NOTES

ROOMS ARE TO BE REPLACED IN KIND IN EXISTING FRAMES. SEE

INTERIOR AND EXTERIOR OF DOORS AND FRAMES AND TO PROVIDE NEW DOOR THRESHOLDS. 3. CONTRACTOR IS TO VERIFY THE CONDITION OF EXISTING

Contact: Elin Westrick ALLOWABLE TOLERANCE. e-mail: ewestrick@cwarc.com

MEP ENGINEERS: Chadds Ford, PA 19317 VERIFY THAT LEVELNESS OF SURFACE IS WITHIN REQUIRED

CONVERSE

BALA CYNWYD, PA 19144

e-mail: ksultanik@aroraengineers.com

1341 NORTH DELAWARE AVENUE,

STRUCTURAL ENGINEERS:

PHILADELPHIA, PA 19125

e-mail: wau@csagroup.com

CSA GROUP

Ph: 215.427.8700

Fax: 215.427.8752

Contact: Wing Au

REVISIONS:

PENNSYLVANIA CONVENTION CENTER

RESTROOM RENOVATIONS

CW1615

As indicated

Description

SUITE 507

ARCHITECTURE

WINKLER

ARCHITECTS:

ARCHITECTURE

Ph: 610.664.0806

Fax: 215.664.1075

CONVERSE WINKLER

331 Montgomery Avenue,

Bala Cynwyd, PA, 19144

TOLERANCES FOR SPECIFIED NEW TILE FINISH. P (610) 459-7900 | F (610) 459-7950 | aroraengineers.com Contact: Kevin Sultanik

REMOVED AND ACCOUNT FOR ANY DIFFERENCE IN THICKNESS OF NEW TILE ASSEMBLY. 8. NEW PLUMBING FIXTURE LOCATIONS DIFFER FROM EXISTING

DRAWINGS 9. SEE SHEET A500 FOR ENLARGED PLANS AND ELEVATIONS OF

FINISH PLANS, AND FINISH SCHEDULES.

TYPICAL EXISTING TOILET ROOMS.

3. COORDINATE WITH OWNER FOR REMOVED


AND SIGNAGE TO BE SALVAGED.

5. FOR STEEL BEAMS INDICATED TO BE REMOVED, GC TO VERIFY THAT BEAMS ARE NOT SUPPORTING ANY

EXERCISE CARE WHEN REMOVING THE BEAMS SO PREVIOUSLY SUPPORTED CEILING-HUNG TOILET


DEMOLITION KEY NOTES

REMOVE EXISTING STEEL BEAM (6" TO 10" DEEP) ABOVE CEILING

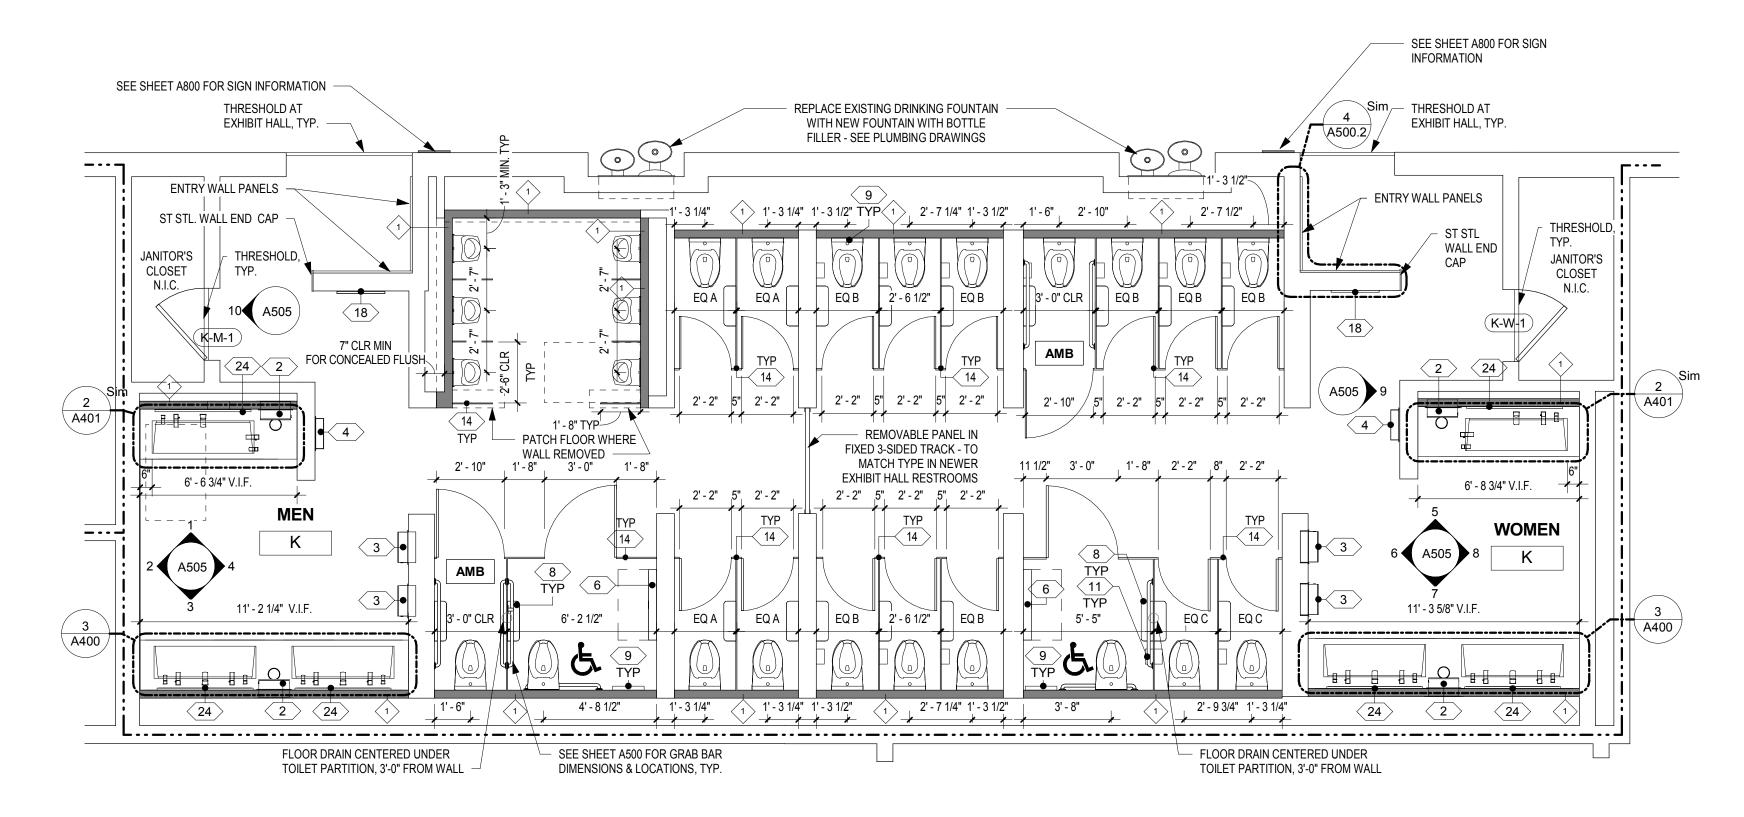

FLOOR PLAN - MEN'S & WOMEN'S ROOM K

A105 SCALE: 1/4" = 1'-0"

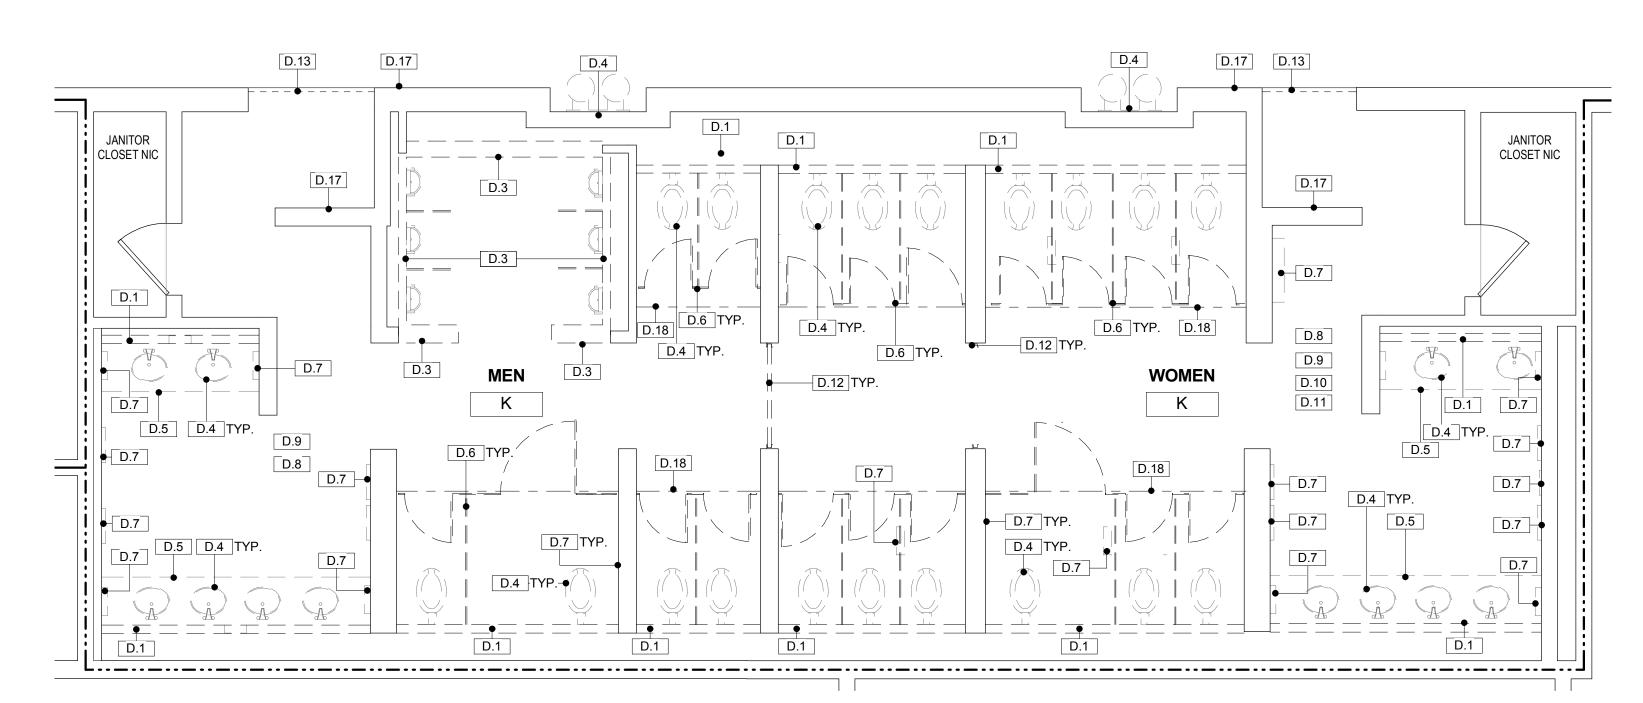

DEMO PLAN - MEN'S & WOMEN'S ROOM K

A105 SCALE: 1/4" = 1'-0"

DRAWING GENERAL NOTES

- 1. JANITOR CLOSET DOORS, HOLLOW METAL FRAMES, AND HARDWARE ARE TO REMAIN AND TO BE REPAINTED AS SCHEDULED. ENTRY DOORS AT SEMINAR- AND BALLROOM-TYPE ROOMS ARE TO BE REPLACED IN KIND IN EXISTING FRAMES. SEE DOOR SCHEDULE ON A600.1 FOR ADDITIONAL INFORMATION.
- 2. JANITOR CLOSETS ARE NOT IN CONTRACT, EXCEPT TO REPAINT INTERIOR AND EXTERIOR OF DOORS AND FRAMES AND TO PROVIDE NEW DOOR THRESHOLDS
- CONTRACTOR IS TO VERIFY THE CONDITION OF EXISTING SUBSTRATES TO RECEIVE NEW FINISHES AND CONFIRM SUITABILITY. IF EXISTING FLOORS DO NOT MEET MEET ALLOWABLE TOLERANCES PER ANSI STANDARDS FOR LARGE-FORMAT TILE, FLASH FLOORS TO LEVEL. SCRIBE WALL TILE AS NECESSARY TO ACCOMMODATE FLOOR LEVEL WITHIN
- ALLOWABLE TOLERANCE. 4. INFILL AND/OR PATCH FLOORS AND WALLS WHERE TOILET PARTITIONS, ACCESSORIES, OR WALLS REMOVED, AND PROVIDE A SOUND AND LEVEL SURFACE TO RECEIVE NEW FINISH.
- IN SEMINAR/BALLROOM TYPE ROOMS, EXISTING CERAMIC WALL TILE IS TO REMAIN ON WALLS TO REMAIN AND NEW SCHEDULED TILE IS TO BE INSTALLED OVER EXISTING TILE. CONTRACTOR TO VERIFY THAT LEVELNESS OF SURFACE IS WITHIN REQUIRED TOLERANCES FOR SPECIFIED NEW TILE FINISH.

- 6. NOT USED.
- 7. GC TO VERIFY THICKNESS OF CERAMIC TILE ASSEMBLY TO BE REMOVED AND ACCOUNT FOR ANY DIFFERENCE IN THICKNESS
- OF NEW TILE ASSEMBLY. 8. NEW PLUMBING FIXTURE LOCATIONS DIFFER FROM EXISTING FIXTURE LOCATIONS. FIXTURE CARRIERS AND ASSOCIATED PLUMBING ARE TO BE RELOCATED TO DIMENSIONS SHOWN ON DRAWINGS.
- 9. SEE SHEET A500 FOR ENLARGED PLANS AND ELEVATIONS OF TYPICAL TOILET COMPARTMENTS AND TYPICAL ACCESSORY MOUNTING HEIGHTS.
- 10. SEE SHEET A500.1 FOR PARTITION TYPES. NEW WALLS ARE TO BE CONSTRUCTED IN THE IN SAME LOCATION AS EXISTING
- DEMOLISHED WALLS, UNLESS NOTED OTHERWISE. 11. SEE A600 SERIES SHEETS FOR REFLECTED CEILING PLANS,
- 12. SEE OVERALL BUILDING PLANS ON SHEETS A001, A002, & A003 FOR LOCATIONS OF ALL DRINKING FOUNTAINS IN PROJECT.

FINISH PLANS, AND FINISH SCHEDULES.

ACCESSORY/EQUIPMENT LEGEND - EXHIBIT HALL-TYPE RESTROOMS

- 2 PAPER TOWEL DISPENSER AUTO, SEMI-RECESSED
- 3 PAPER TOWEL/TRASH COMBO UNIT AUTO, SEMI-RECESSED
- 4 TRASH SEMI-RECESSED WALL MTD.
- OTHERWISE NOTED) $\overline{(8)}$ Toilet paper dispenser - Dual Jumbo Roll (Typ. In

6 DIAPER CHANGING STATION - SURFACE-MTD. (UNLESS

- EACH STALL) \langle 9 \rangle Seat cover dispenser (Typ. in Each Stall)
- \langle 11angle Sanitary Disposal (Typ. In Each Women's Stall)
- (14) TOILET PARTITIONS 1 COMPACT LAMINATE (PHENOLIC), FLOOR-MOUNTED & OVERHEAD BRACED, 58" H, 12" A.F.F. URINAL SCREENS 20" D X 48" H, WALL-MOUNTED
- 18 MIRROR FULL LENGTH 24" X 72"
- (19) MIRROR DOUBLE WIDTH 42" X 54"
- 20 MIRROR SINGLE WIDTH 24" X 54"
- <23 MIRROR SINGLE WIDTH, NARROW 18" X 54"</p>
- <24 MIRROR DOUBLE WIDTH, WIDE 48" X 54"
- < 26 > MIRROR TRIPLE WIDTH, WIDE 76" X 54"

NOTE: SEE SPECIFICATIONS FOR ADDITIONAL INFORMATION.

WHEELCHAIR ACCESSIBLE TOILET COMPARTMENT - SEE A500 FOR TYPICAL ENLARGED PLANS AND ELEVATIONS.

AMBULATORY ACCESSIBLE TOILET COMPARTMENT - SEE A500 FOR TYPICAL ENLARGED PLANS AND ELEVATIONS.

ADA / ICC ANSI A117.1 REQUIRED CLEARANCES

EXISTING 2-HR FIRE RATED WALL (PER AS-BUILT DRAWINGS) TO REMAIN

NO SYMBOL UNLESS OTHERWISE NOTED, TOILET COMPARTMENTS ARE STANDARD.

PARTITION TYPE - SEE SHEET A500.1

DEMOLITION GENERAL NOTES


- 1. SEE PHOTOS ON SOME SHEETS FOR IMAGES OF TYPICAL EXISTING TOILET ROOMS.
- 2. COORDINATE DEMOLITION SCOPE ITEMS WITH NEW
- WORK AND MEP DRAWINGS. 3. COORDINATE WITH OWNER FOR REMOVED ACCESSORIES, PLUMBING FIXTURES, LIGHTING
- FIXTURES, CEILING DEVICES, TOILET PARTITIONS, AND SIGNAGE TO BE SALVAGED.
- 4. JANITOR CLOSET DOORS TO REMAIN. PROTECT
- DURING CONSTRUCTION. 5. FOR STEEL BEAMS INDICATED TO BE REMOVED, GC TO VERIFY THAT BEAMS ARE NOT SUPPORTING ANY BUILDING ELEMENT PRIOR TO DEMOLITION. EXERCISE CARE WHEN REMOVING THE BEAMS SO AS NOT TO DAMAGE ANY ADJACENT CONSTRUCTION. BEAMS APPEAR TO HAVE PREVIOUSLY SUPPORTED CEILING-HUNG TOILET

PARTITIONS, BUT ARE NO LONGER IN USE.

DEMOLITION KEY NOTES

D.1	REMOVE EXISTING 4" CMU CHASE WALL (AT ROOMS T,V, & W, EXISTING WALL IS 4" METAL FRAMING)
D.3	REMOVE PORTION OF EXISTING WALL
D.4	REMOVE EXISTING PLUMBING FIXTURE - SEE PLUMBING DWG
D.5	REMOVE EXISTING COUNTERTOP & SUPPORT FRAMING
D.6	REMOVE EXISTING TOILET/URINAL PARTITIONS
	DEMONIE ENGLES MALL MOUNTED ACCESSORIES

- REMOVE EXISTING WALL-MOUNTED ACCESSORIES REMOVE EXISTING CERAMIC FLOOR TILE TO CONCRETE SLAB REMOVE EXISTING CERAMIC WALL TILE & BASE ON ALL INTERIOR WALLS (EXHIBIT ROOMS ONLY, U.N.O.)
- REMOVE EXISTING GWB CEILING, SUPPORT STRUCTURE, & CEILING-MOUNTED DEVICES THROUGHOUT ROOM - SEE MEP
- REMOVE EXISTING LIGHT FIXTURES SEE ELECTRICAL DWGS. REMOVE EXISTING MOVABLE ROOM-DIVIDING PANEL & FIXED
- REMOVE EXISTING DOOR THRESHOLD (ALUMINUM THRESHOLD AT EXHIBIT-TYPE ROOMS; MARBLE THRESHOLD AT SEMINAR-TYPE
- REMOVE EXISTING WALL-MOUNTED SIGNAGE REMOVE EXISTING STEEL BEAM (6" TO 10" DEEP) ABOVE CEILING

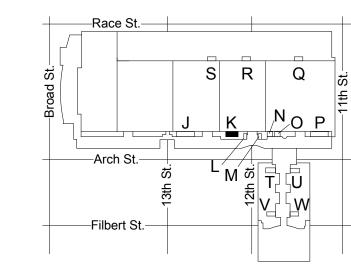

KEY PLAN - LEVEL 200

NTS

Drawn by Checked by

e-mail: ksultanik@aroraengineers.com STRUCTURAL ENGINEERS: CSA GROUP 1341 NORTH DELAWARE AVENUE, SUITE 507 PHILADELPHIA, PA 19125

Arora Engineers, Inc.

Chadds Ford, PA 19317

CONVERSE

331 MONTGOMERY AVE BALA CYNWYD, PA 19144

WINKLER ARCHITECTURE

ARCHITECTS:

ARCHITECTURE

Ph: 610.664.0806

Fax: 215.664.1075

MEP ENGINEERS:

Contact: Kevin Sultanik

Contact: Elin Westrick

e-mail: ewestrick@cwarc.com

P (610) 459-7900 | F (610) 459-7950 | aroraengineers.com


CONVERSE WINKLER

331 Montgomery Avenue,

Bala Cynwyd, PA, 19144

Ph: 215.427.8700 Fax: 215.427.8752

Contact: Wing Au e-mail: wau@csagroup.com

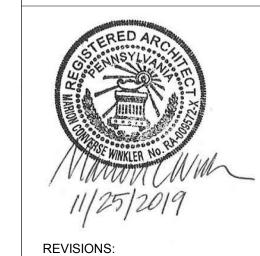

Description

/ANIA | CENTER PENNSYLV, CONVENTION (

DEMOLITION & NEW FLOOR PLANS - ROOM K (EXHIBIT)

CW1615 Project number November 25, 2019 Date LC/KR ΕW



N WOMEN'S- EXISTING



O MEN'S - EXISTING

 $\left(O-M+1\right)$

ENTRY WALL PANELS

JANITOR'S

CLOSET

N.I.C.

TYP.

THRESHOLD,


THRESHOLD AT EXHIBIT HALL, TYP.

SEE A800 FOR SIGNAGE INFORMATION


12' - 9" V.I.F.

1' - 8" TYP--

0

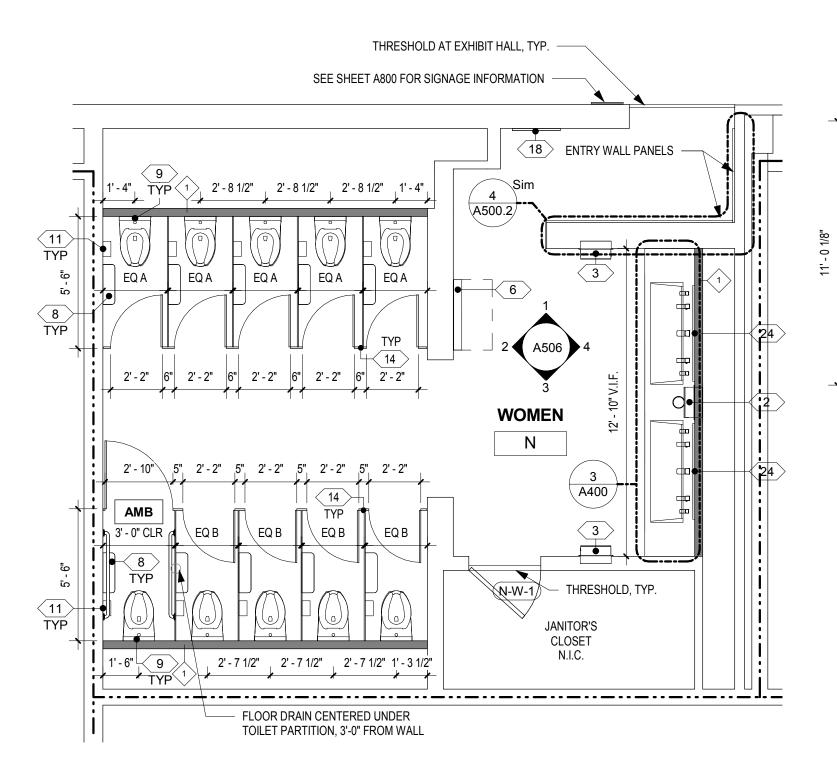

4 FLOOR PLAN - WOMEN'S ROOM N A106 SCALE: 1/4" = 1'-0"

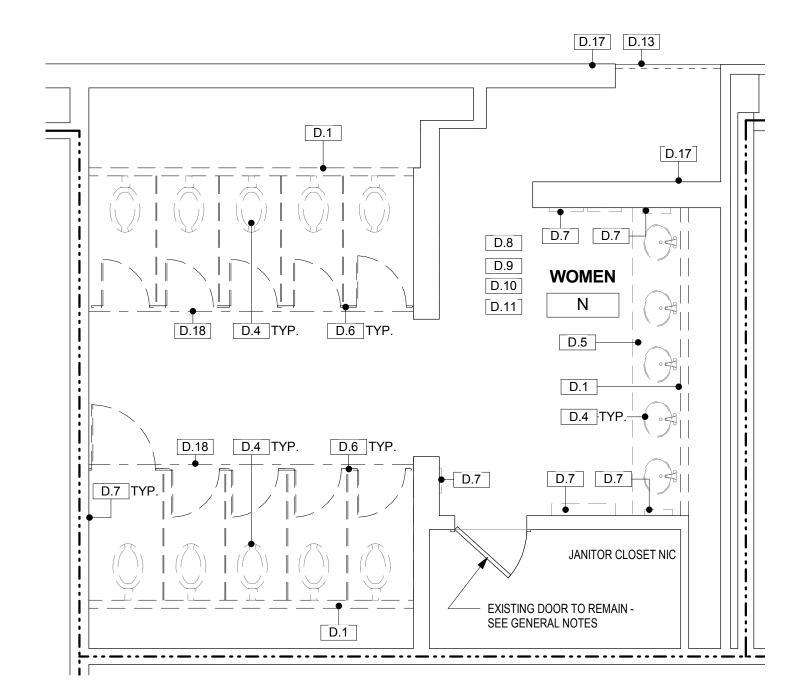


DEMO PLAN - WOMEN'S ROOM N

A106 | SCALE: 1/4" = 1'-0"

3 FLOOR PLAN - MEN'S ROOM O A106 SCALE: 1/4" = 1'-0"

FLOOR DRAIN CENTERED UNDER

TOILET PARTITION, 3' FROM WALL

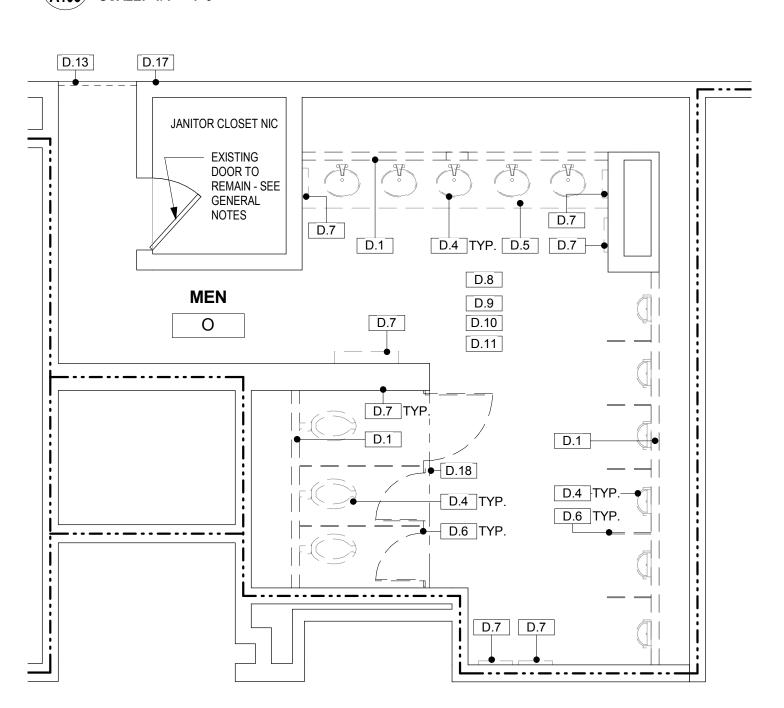

DEMO PLAN - MEN'S ROOM O

A106 SCALE: 1/4" = 1'-0"

DRAWING GENERAL NOTES

- 1. JANITOR CLOSET DOORS, HOLLOW METAL FRAMES, AND HARDWARE ARE TO REMAIN AND TO BE REPAINTED AS SCHEDULED. ENTRY DOORS AT SEMINAR- AND BALLROOM-TYPE ROOMS ARE TO BE REPLACED IN KIND IN EXISTING FRAMES. SEE DOOR SCHEDULE ON A600.1 FOR ADDITIONAL INFORMATION.
- 2. JANITOR CLOSETS ARE NOT IN CONTRACT, EXCEPT TO REPAINT INTERIOR AND EXTERIOR OF DOORS AND FRAMES AND TO PROVIDE NEW DOOR THRESHOLDS
- 3. CONTRACTOR IS TO VERIFY THE CONDITION OF EXISTING SUBSTRATES TO RECEIVE NEW FINISHES AND CONFIRM SUITABILITY. IF EXISTING FLOORS DO NOT MEET MEET ALLOWABLE TOLERANCES PER ANSI STANDARDS FOR LARGE-FORMAT TILE, FLASH FLOORS TO LEVEL. SCRIBE WALL TILE AS NECESSARY TO ACCOMMODATE FLOOR LEVEL WITHIN ALLOWABLE TOLERANCE.
- 4. INFILL AND/OR PATCH FLOORS AND WALLS WHERE TOILET PARTITIONS, ACCESSORIES, OR WALLS REMOVED, AND PROVIDE A SOUND AND LEVEL SURFACE TO RECEIVE NEW FINISH.
- IN SEMINAR/BALLROOM TYPE ROOMS, EXISTING CERAMIC WALL TILE IS TO REMAIN ON WALLS TO REMAIN AND NEW SCHEDULED TILE IS TO BE INSTALLED OVER EXISTING TILE. CONTRACTOR TO VERIFY THAT LEVELNESS OF SURFACE IS WITHIN REQUIRED TOLERANCES FOR SPECIFIED NEW TILE FINISH.

- NOT USED.
- GC TO VERIFY THICKNESS OF CERAMIC TILE ASSEMBLY TO BE REMOVED AND ACCOUNT FOR ANY DIFFERENCE IN THICKNESS OF NEW TILE ASSEMBLY.
- NEW PLUMBING FIXTURE LOCATIONS DIFFER FROM EXISTING FIXTURE LOCATIONS. FIXTURE CARRIERS AND ASSOCIATED PLUMBING ARE TO BE RELOCATED TO DIMENSIONS SHOWN ON
- 9. SEE SHEET A500 FOR ENLARGED PLANS AND ELEVATIONS OF TYPICAL TOILET COMPARTMENTS AND TYPICAL ACCESSORY MOUNTING HEIGHTS.
- 10. SEE SHEET A500.1 FOR PARTITION TYPES. NEW WALLS ARE TO BE CONSTRUCTED IN THE IN SAME LOCATION AS EXISTING
- DEMOLISHED WALLS, UNLESS NOTED OTHERWISE. 11. SEE A600 SERIES SHEETS FOR REFLECTED CEILING PLANS,
- FINISH PLANS, AND FINISH SCHEDULES. 12. SEE OVERALL BUILDING PLANS ON SHEETS A001, A002, & A003 FOR LOCATIONS OF ALL DRINKING FOUNTAINS IN PROJECT.

ACCESSORY/EQUIPMENT LEGEND - EXHIBIT HALL-TYPE RESTROOMS

- 2 PAPER TOWEL DISPENSER AUTO, SEMI-RECESSED
- 3 PAPER TOWEL/TRASH COMBO UNIT AUTO, SEMI-RECESSED
- 4 TRASH SEMI-RECESSED WALL MTD.
- 6 DIAPER CHANGING STATION SURFACE-MTD. (UNLESS OTHERWISE NOTED)
- 8 TOILET PAPER DISPENSER DUAL JUMBO ROLL (TYP. IN EACH STALL)
- 9 SEAT COVER DISPENSER (TYP. IN EACH STALL) <11> SANITARY DISPOSAL (TYP. IN EACH WOMEN'S STALL)
- (14) TOILET PARTITIONS 1 COMPACT LAMINATE (PHENOLIC), FLOOR-MOUNTED & OVERHEAD BRACED, 58" H, 12" A.F.F.; URINAL SCREENS 20" D X 48" H, WALL-MOUNTED
- 18 MIRROR FULL LENGTH 24" X 72"
- < 19 MIRROR DOUBLE WIDTH 42" X 54" (20) MIRROR - SINGLE WIDTH - 24" X 54"
- <23 MIRROR SINGLE WIDTH, NARROW 18" X 54"</p>
- (24) MIRROR DOUBLE WIDTH, WIDE 48" X 54"
- 26 MIRROR TRIPLE WIDTH, WIDE 76" X 54"
- NOTE: SEE SPECIFICATIONS FOR ADDITIONAL INFORMATION.



WHEELCHAIR ACCESSIBLE TOILET COMPARTMENT - SEE A500 FOR TYPICAL ENLARGED



AMBULATORY ACCESSIBLE TOILET COMPARTMENT - SEE A500 FOR TYPICAL ENLARGED PLANS AND ELEVATIONS.

NO SYMBOL UNLESS OTHERWISE NOTED, TOILET COMPARTMENTS ARE STANDARD.

ADA / ICC ANSI A117.1 REQUIRED CLEARANCES

PARTITION TYPE - SEE SHEET A500.1

--- EXISTING 2-HR FIRE RATED WALL (PER AS-BUILT DRAWINGS) TO REMAIN


DEMOLITION GENERAL NOTES

- 1. SEE PHOTOS ON SOME SHEETS FOR IMAGES OF TYPICAL EXISTING TOILET ROOMS.
- 2. COORDINATE DEMOLITION SCOPE ITEMS WITH NEW WORK AND MEP DRAWINGS.
- 3. COORDINATE WITH OWNER FOR REMOVED ACCESSORIES, PLUMBING FIXTURES, LIGHTING FIXTURES, CEILING DEVICES, TOILET PARTITIONS,
- AND SIGNAGE TO BE SALVAGED. 4. JANITOR CLOSET DOORS TO REMAIN. PROTECT
- DURING CONSTRUCTION. 5. FOR STEEL BEAMS INDICATED TO BE REMOVED, GC
- TO VERIFY THAT BEAMS ARE NOT SUPPORTING ANY BUILDING ELEMENT PRIOR TO DEMOLITION. EXERCISE CARE WHEN REMOVING THE BEAMS SO AS NOT TO DAMAGE ANY ADJACENT CONSTRUCTION. BEAMS APPEAR TO HAVE PREVIOUSLY SUPPORTED CEILING-HUNG TOILET PARTITIONS, BUT ARE NO LONGER IN USE.

DEMOLITION KEY NOTES

D.1	REMOVE EXISTING 4" CMU CHASE WALL (AT ROOMS T,V, & W, EXISTING WALL IS 4" METAL FRAMING)
D.4	REMOVE EXISTING PLUMBING FIXTURE - SEE PLUMBING DWGS
D.5	REMOVE EXISTING COUNTERTOP & SUPPORT FRAMING
D.6	REMOVE EXISTING TOILET/URINAL PARTITIONS
D.7	REMOVE EXISTING WALL-MOUNTED ACCESSORIES
D.8	REMOVE EXISTING CERAMIC FLOOR TILE TO CONCRETE SLAB
D.9	REMOVE EXISTING CERAMIC WALL TILE & BASE ON ALL INTERI WALLS (EXHIBIT ROOMS ONLY, U.N.O.)
D.10	REMOVE EXISTING GWB CEILING, SUPPORT STRUCTURE, & CEILING-MOUNTED DEVICES THROUGHOUT ROOM - SEE MEP

- REMOVE EXISTING LIGHT FIXTURES SEE ELECTRICAL DWGS. REMOVE EXISTING DOOR THRESHOLD (ALUMINUM THRESHOLD AT EXHIBIT-TYPE ROOMS; MARBLE THRESHOLD AT SEMINAR-TYPE
- REMOVE EXISTING WALL-MOUNTED SIGNAGE REMOVE EXISTING STEEL BEAM (6" TO 10" DEEP) ABOVE CEILING

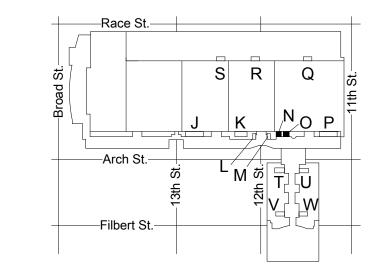

KEY PLAN - LEVEL 200

PLANS - ROOMS N, O (EXHIBIT) CW1615 Project number November 25, 2019 LC/KR

DEMOLITION &

NEW FLOOR

CONVERSE **WINKLER**

BALA CYNWYD, PA 19144

ARCHITECTURE

ARCHITECTS:

ARCHITECTURE

Ph: 610.664.0806

Fax: 215.664.1075

MEP ENGINEERS:

Contact: Kevin Sultanik

CSA GROUP

Ph: 215.427.8700

Fax: 215.427.8752

Contact: Wing Au

REVISIONS:

PENNSYLVANIA CONVENTION CENTER

RESTROOM RENOVATIONS

Description

SUITE 507

Contact: Elin Westrick

e-mail: ewestrick@cwarc.com

P (610) 459-7900 F (610) 459-7950 aroraengineers.com

e-mail: ksultanik@aroraengineers.com

1341 NORTH DELAWARE AVENUE,

STRUCTURAL ENGINEERS:

PHILADELPHIA, PA 19125

e-mail: wau@csagroup.com

Chadds Ford, PA 19317

CONVERSE WINKLER


331 Montgomery Avenue,

Bala Cynwyd, PA, 19144

Checked by A106

As indicated

ΕW

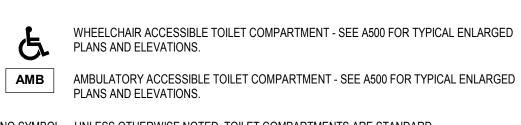

1 2'-11 1/2" 1'-5 1/2" 1'-5 1/2" TYP (1), 2'-11 1/2" 1'-5 1/2"

EQ A

EQ A

Y---

EQ A

FIXED TRACK

AROUND 3 SIDES FOR

REMOVABLE PANEL

2' - 2" | 10" | 2' - 2" | 10" | 2' - 2"

EQ A

D.1

EQ A

EQ A

EQ A

NO SYMBOL UNLESS OTHERWISE NOTED, TOILET COMPARTMENTS ARE STANDARD.

ADA / ICC ANSI A117.1 REQUIRED CLEARANCES

REPLACE EXISTING DRINKING FOUNTAIN

3' - 0" CLR

D.9

 $\langle 11 \rangle$

EQ C

EQ C

** ** ** ** ** ** ** ** *`***** ** ** ** *

EQ A

EQ A

D.12

EQ A

2' - 2" | 10" | 2' - 2" | 10" | 2' - 2"

FIXED TRACK REMOVABLE

2' - 2" | 10" | 2' - 2" | 10" | 2' - 2"

EQ A

PANEL IN 3-SIDED

FIXED TRACK

EQ A

1'-51/2" 9 2'-111/2" 1'-51/2" 1'-51/2"

WITH NEW FOUNTAIN WITH BOTTLE

FILLER - SEE PLUMBING DRAWINGS

EQ C

2' - 2" | 10" | 2' - 2" | 10" | 2' - 2" | 10" | 2' - 2" | 10" | 2' - 2" | 10" | 2' - 2" | 10" | 2' - 2" |

2'-2",10", 2'-2",10", 2'-2",10", 2'-2",6", 2'-10",2'-03/4", 3'-0",10",

EQ B

EQ C

EQ B

WOMEN

Р

EQ B

FLOOR DRAIN CENTERED UNDER TOILET PARTITION, 3'-0" FROM WALL ——/

EQ B

--- EXISTING 2-HR FIRE RATED WALL (PER AS-BUILT DRAWINGS) TO REMAIN PARTITION TYPE - SEE SHEET A500.1

ACCESSORY/EQUIPMENT LEGEND - EXHIBIT HALL-TYPE RESTROOMS

- 2 PAPER TOWEL DISPENSER AUTO, SEMI-RECESSED 3 PAPER TOWEL/TRASH COMBO UNIT - AUTO, SEMI-RECESSED
- 4 TRASH SEMI-RECESSED WALL MTD.
- 6 DIAPER CHANGING STATION SURFACE-MTD. (UNLESS OTHERWISE NOTED)
- 8 TOILET PAPER DISPENSER DUAL JUMBO ROLL (TYP. IN
- EACH STALL)
- 9 SEAT COVER DISPENSER (TYP. IN EACH STALL)

3' - 0" 1' - 11 1/2" 2' - 10" | 8" | 2' - 2" | 8" | 2' - 2"

3' - 0" CLR |||

TYP

URINAL WALL OPPOSITE, SIM

TO PARTITION TYPE 4

D.1

TYP.

EQ B

FURR WALL TO ALIGN WITH FLOOR DRAIN CENTERED UNDER

D.4 TYP.

EQ B

TOILET PARTITION, 3'-0" FROM WALL

D.17 D.13

Ρ

- (11) SANITARY DISPOSAL (TYP. IN EACH WOMEN'S STALL)
- 14 TOILET PARTITIONS 1 COMPACT LAMINATE (PHENOLIC), FLOOR-MOUNTED & OVERHEAD BRACED, 58" H, 12" A.F.F.; URINAL SCREENS 20" D X 48" H, WALL-MOUNTED
- 18 MIRROR FULL LENGTH 24" X 72"
- (19) MIRROR DOUBLE WIDTH 42" X 54"
- 20 MIRROR SINGLE WIDTH 24" X 54"
- 23 MIRROR SINGLE WIDTH, NARROW 18" X 54"
- 24 MIRROR DOUBLE WIDTH, WIDE 48" X 54"
- 26 MIRROR TRIPLE WIDTH, WIDE 76" X 54"
- NOTE: SEE SPECIFICATIONS FOR ADDITIONAL INFORMATION.
- A SOUND AND LEVEL SURFACE TO RECEIVE NEW FINISH. IN SEMINAR/BALLROOM TYPE ROOMS, EXISTING CERAMIC WALL TILE IS TO REMAIN ON WALLS TO REMAIN AND NEW SCHEDULED TILE IS TO BE INSTALLED OVER EXISTING TILE. CONTRACTOR TO

CONVERSE WINKLER

ARCHITECTURE

ARCHITECTS:

ARCHITECTURE

Ph: 610.664.0806

Fax: 215.664.1075

MEP ENGINEERS:

ARORA°

Contact: Kevin Sultanik

CSA GROUP

Ph: 215.427.8700

Fax: 215.427.8752

Contact: Wing Au

REVISIONS:

VANIA N CENTER

PENNSYLV, CONVENTION (

DEMOLITION &

NEW FLOOR

PLANS - ROOM P

(EXHIBIT)

RESTROOM RENOVATIONS

CW1615

LC/KR

As indicated

ΕW

Description

SUITE 507

STRUCTURAL ENGINEERS:

PHILADELPHIA, PA 19125

e-mail: wau@csagroup.com

Contact: Elin Westrick

e-mail: ewestrick@cwarc.com

P (610) 459-7900 | F (610) 459-7950 | aroraengineers.com

e-mail: ksultanik@aroraengineers.com

1341 NORTH DELAWARE AVENUE,

Chadds Ford, PA 19317

CONVERSE WINKLER

331 Montgomery Avenue,

Bala Cynwyd, PA, 19144

331 MONTGOMERY AVE BALA CYNWYD, PA 19144

TOLERANCES FOR SPECIFIED NEW TILE FINISH.

DRAWING GENERAL NOTES

PROVIDE NEW DOOR THRESHOLDS.

ALLOWABLE TOLERANCE.

1. JANITOR CLOSET DOORS, HOLLOW METAL FRAMES, AND

HARDWARE ARE TO REMAIN AND TO BE REPAINTED AS

SCHEDULED. ENTRY DOORS AT SEMINAR- AND BALLROOM-TYPE

ROOMS ARE TO BE REPLACED IN KIND IN EXISTING FRAMES. SEE

DOOR SCHEDULE ON A600.1 FOR ADDITIONAL INFORMATION.

2. JANITOR CLOSETS ARE NOT IN CONTRACT, EXCEPT TO REPAINT

INTERIOR AND EXTERIOR OF DOORS AND FRAMES AND TO

3. CONTRACTOR IS TO VERIFY THE CONDITION OF EXISTING

SUBSTRATES TO RECEIVE NEW FINISHES AND CONFIRM

ALLOWABLE TOLERANCES PER ANSI STANDARDS FOR LARGE-

FORMAT TILE, FLASH FLOORS TO LEVEL. SCRIBE WALL TILE AS

PARTITIONS, ACCESSORIES, OR WALLS REMOVED, AND PROVIDE

SUITABILITY. IF EXISTING FLOORS DO NOT MEET MEET

NECESSARY TO ACCOMMODATE FLOOR LEVEL WITHIN

4. INFILL AND/OR PATCH FLOORS AND WALLS WHERE TOILET

- 8. NEW PLUMBING FIXTURE LOCATIONS DIFFER FROM EXISTING FIXTURE LOCATIONS. FIXTURE CARRIERS AND ASSOCIATED PLUMBING ARE TO BE RELOCATED TO DIMENSIONS SHOWN ON
- 9. SEE SHEET A500 FOR ENLARGED PLANS AND ELEVATIONS OF TYPICAL TOILET COMPARTMENTS AND TYPICAL ACCESSORY
- 10. SEE SHEET A500.1 FOR PARTITION TYPES. NEW WALLS ARE TO BE CONSTRUCTED IN THE IN SAME LOCATION AS EXISTING
- DEMOLISHED WALLS, UNLESS NOTED OTHERWISE. 11. SEE A600 SERIES SHEETS FOR REFLECTED CEILING PLANS
- 12. SEE OVERALL BUILDING PLANS ON SHEETS A001, A002, & A003
- TYPICAL EXISTING TOILET ROOMS.
- WORK AND MEP DRAWINGS. 3. COORDINATE WITH OWNER FOR REMOVED ACCESSORIES, PLUMBING FIXTURES, LIGHTING

30"X48" CLR

FLR SPACE


FAUCET

CENTERED ON

- FIXTURES, CEILING DEVICES, TOILET PARTITIONS, AND SIGNAGE TO BE SALVAGED. JANITOR CLOSET DOORS TO REMAIN. PROTECT
- DURING CONSTRUCTION. 5. FOR STEEL BEAMS INDICATED TO BE REMOVED, GC TO VERIFY THAT BEAMS ARE NOT SUPPORTING ANY BUILDING ELEMENT PRIOR TO DEMOLITION. EXERCISE CARE WHEN REMOVING THE BEAMS SO AS NOT TO DAMAGE ANY ADJACENT CONSTRUCTION. BEAMS APPEAR TO HAVE PREVIOUSLY SUPPORTED CEILING-HUNG TOILET PARTITIONS, BUT ARE NO LONGER IN USE.

DEMOLITION KEY NOTES

D.1	REMOVE EXISTING 4" CMU CHASE WALL (AT ROOMS T,V, & W, EXISTING WALL IS 4" METAL FRAMING)
D.3	REMOVE PORTION OF EXISTING WALL
D.4	REMOVE EXISTING PLUMBING FIXTURE - SEE PLUMBING DWGS
D.5	REMOVE EXISTING COUNTERTOP & SUPPORT FRAMING
D.6	REMOVE EXISTING TOILET/URINAL PARTITIONS
D.7	REMOVE EXISTING WALL-MOUNTED ACCESSORIES
D.8	REMOVE EXISTING CERAMIC FLOOR TILE TO CONCRETE SLAB
D.9	REMOVE EXISTING CERAMIC WALL TILE & BASE ON ALL INTERION WALLS (EXHIBIT ROOMS ONLY, U.N.O.)
D.10	REMOVE EXISTING GWB CEILING, SUPPORT STRUCTURE, & CEILING-MOUNTED DEVICES THROUGHOUT ROOM - SEE MEP DWGS.
D.11	REMOVE EXISTING LIGHT FIXTURES - SEE ELECTRICAL DWGS.
D.12	REMOVE EXISTING MOVABLE ROOM-DIVIDING PANEL & FIXED FRAME
D.13	REMOVE EXISTING DOOR THRESHOLD (ALUMINUM THRESHOLD EXHIBIT-TYPE ROOMS; MARBLE THRESHOLD AT SEMINAR-TYPE ROOMS)
D 1/	PEMOVE EXISTING DI LIMBING & CAP RELOW ELOOP/ABOVE

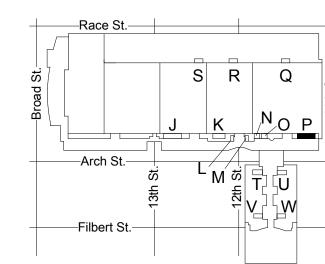

REMOVE EXISTING STEEL BEAM (6" TO 10" DEEP) ABOVE CEILING

KEY PLAN - LEVEL 200



Project number November 25, 2019 Drawn by Checked by



SEE SHEET A800 FOR

SIGNAGE INFORMATION

THRESHOLD AT EXHIBIT

ENTRY WALL PANELS

ST STL. WALL END CAP

JANITOR'S CLOSET N.I.C

30"X48" CLR

FLR SPACE

FAUCET

CENTERED ON

10' - 8 3/4" V.I.F.

WOMEN

15' - 4 3/4" V.I.F.

< 19 >

7 FLOOR PLAN - MEN'S & WOMEN'S ROOM P

 $\langle 2 \rangle \langle 19 \rangle \langle$

D.7

THRESHOLD,

A400

A400


A107 | SCALE: 1/4" = 1'-0"

JANITOR'S CLOSET

EXISTING DOOR - SEE GENERAL NOTES -

● D.7

HALL, TYP.

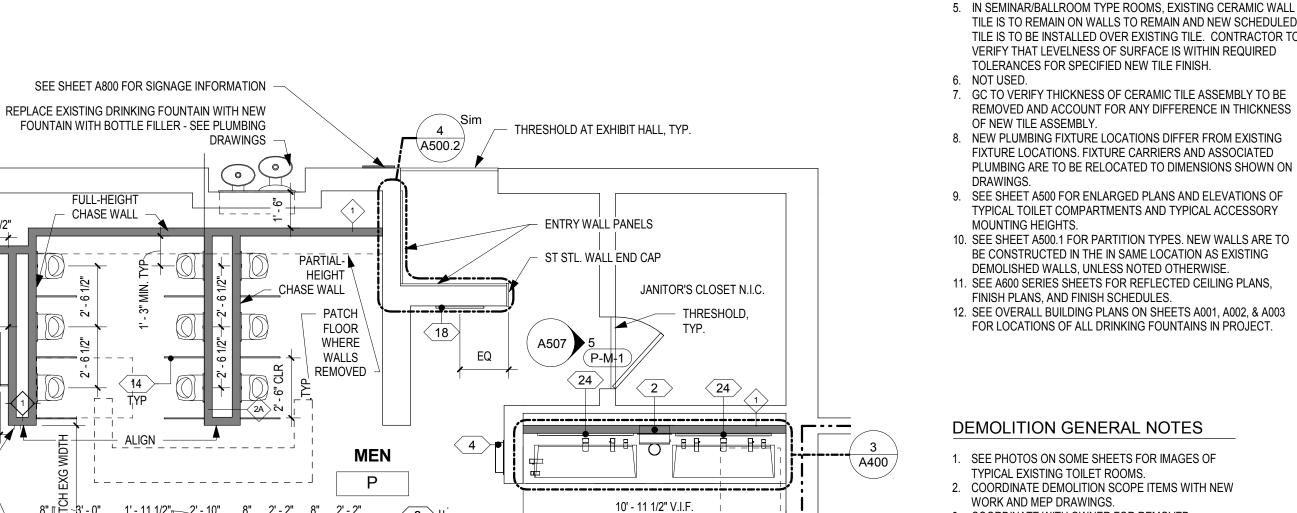

5' TURNING

15' - 6 1/2" V.I.F

15' - 6 1/2" V.I.F.

RADIUS

JANITOR'S CLOSET

N.I.C.

EXISTING DOOR - SEE

D.7

D.7

D.7

D.7


GENERAL NOTES

D.4 TYP.

REMOVE EXISTING PLUMBING & CAP BELOW FLOOR/ABOVE CEILING (WHERE WALL RECONFIGURED) REMOVE EXISTING WALL-MOUNTED SIGNAGE




TYPICAL SMALL EXHIBIT RESTROOM - Q MEN'S - EXISTING

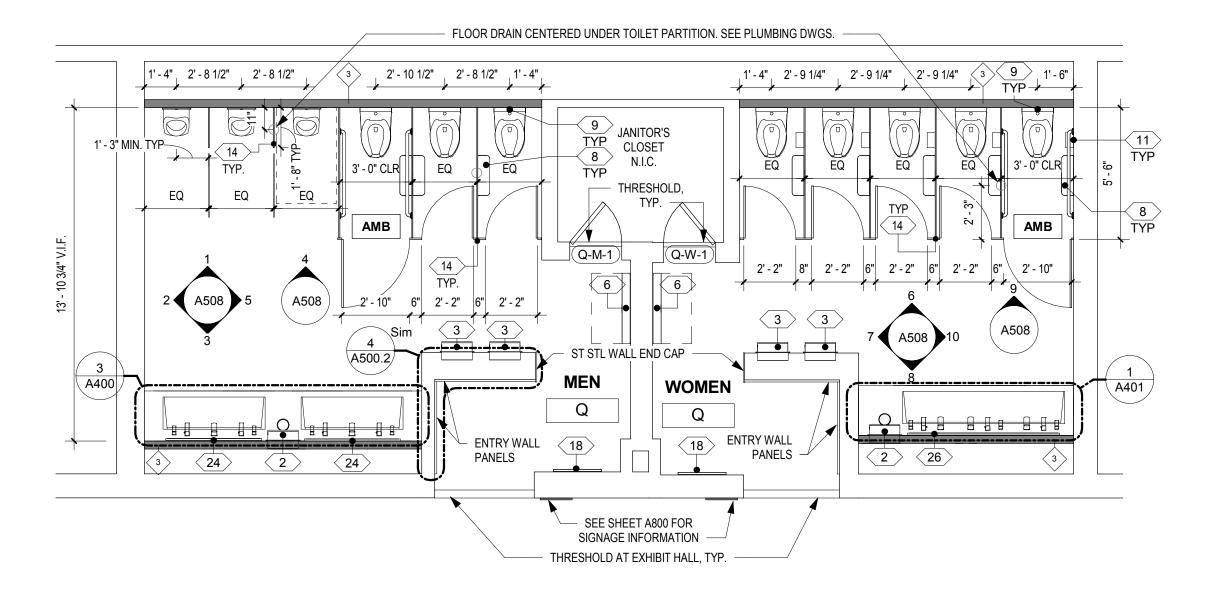

2 FLOOR PLAN - MEN'S & WOMEN'S ROOM Q A108 SCALE: 1/4" = 1'-0"



TYPICAL SMALL EXHIBIT RESTROOM - Q WOMEN'S- EXISTING

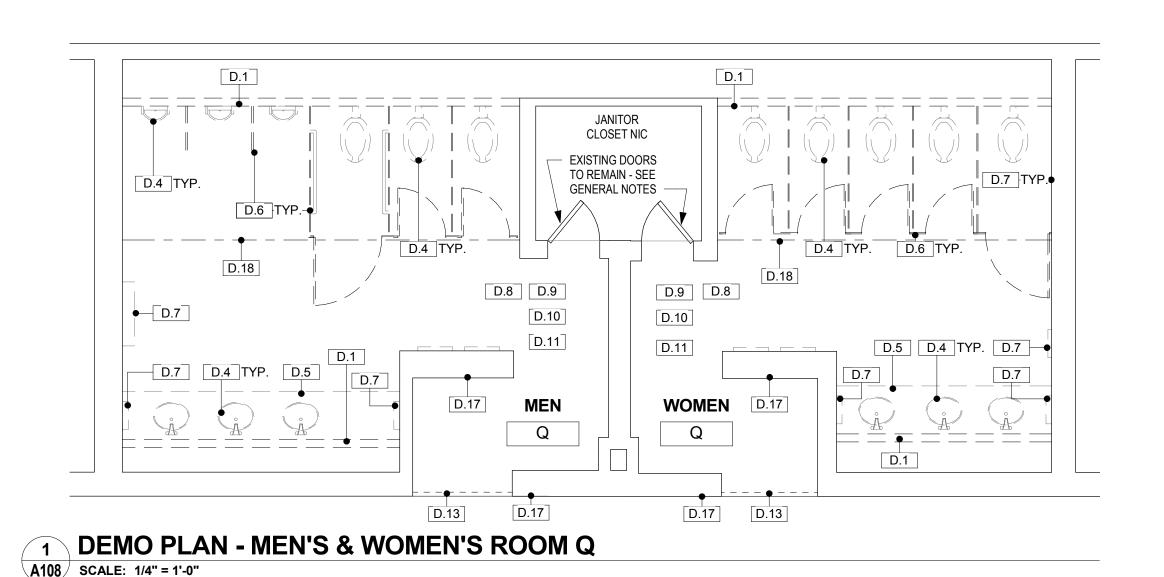

DRAWING GENERAL NOTES

- 1. JANITOR CLOSET DOORS, HOLLOW METAL FRAMES, AND HARDWARE ARE TO REMAIN AND TO BE REPAINTED AS SCHEDULED. ENTRY DOORS AT SEMINAR- AND BALLROOM-TYPE ROOMS ARE TO BE REPLACED IN KIND IN EXISTING FRAMES. SEE DOOR SCHEDULE ON A600.1 FOR ADDITIONAL INFORMATION.

 2. JANITOR CLOSETS ARE NOT IN CONTRACT. EXCEPT TO REPAINT.
- 2. JANITOR CLOSETS ARE NOT IN CONTRACT, EXCEPT TO REPAINT INTERIOR AND EXTERIOR OF DOORS AND FRAMES AND TO PROVIDE NEW DOOR THRESHOLDS.
- 3. CONTRACTOR IS TO VERIFY THE CONDITION OF EXISTING SUBSTRATES TO RECEIVE NEW FINISHES AND CONFIRM SUITABILITY. IF EXISTING FLOORS DO NOT MEET MEET ALLOWABLE TOLERANCES PER ANSI STANDARDS FOR LARGE-FORMAT TILE, FLASH FLOORS TO LEVEL. SCRIBE WALL TILE AS NECESSARY TO ACCOMMODATE FLOOR LEVEL WITHIN ALLOWABLE TOLERANCE
- ALLOWABLE TOLERANCE.

 4. INFILL AND/OR PATCH FLOORS AND WALLS WHERE TOILET PARTITIONS, ACCESSORIES, OR WALLS REMOVED, AND PROVIDE A SOUND AND LEVEL SURFACE TO RECEIVE NEW FINISH.
- A SOUND AND LEVEL SURFACE TO RECEIVE NEW FINISH.

 5. IN SEMINAR/BALLROOM TYPE ROOMS, EXISTING CERAMIC WALL TILE IS TO REMAIN ON WALLS TO REMAIN AND NEW SCHEDULED TILE IS TO BE INSTALLED OVER EXISTING TILE. CONTRACTOR TO VERIFY THAT LEVELNESS OF SURFACE IS WITHIN REQUIRED TOLERANCES FOR SPECIFIED NEW TILE FINISH.

- 6. NOT USED.
- 7. GC TO VERIFY THICKNESS OF CERAMIC TILE ASSEMBLY TO BE REMOVED AND ACCOUNT FOR ANY DIFFERENCE IN THICKNESS
- OF NEW TILE ASSEMBLY.

 8. NEW PLUMBING FIXTURE LOCATIONS DIFFER FROM EXISTING FIXTURE LOCATIONS. FIXTURE CARRIERS AND ASSOCIATED PLUMBING ARE TO BE RELOCATED TO DIMENSIONS SHOWN ON
- DRAWINGS.

 9. SEE SHEET A500 FOR ENLARGED PLANS AND ELEVATIONS OF TYPICAL TOILET COMPARTMENTS AND TYPICAL ACCESSORY
- MOUNTING HEIGHTS.

 10. SEE SHEET A500.1 FOR PARTITION TYPES. NEW WALLS ARE TO BE CONSTRUCTED IN THE IN SAME LOCATION AS EXISTING DEMOLISHED WALLS LINESS NOTED OTHERWISE
- DEMOLISHED WALLS, UNLESS NOTED OTHERWISE.

 11. SEE A600 SERIES SHEETS FOR REFLECTED CEILING PLANS, FINISH PLANS, AND FINISH SCHEDULES.
- 12. SEE OVERALL BUILDING PLANS ON SHEETS A001, A002, & A003 FOR LOCATIONS OF ALL DRINKING FOUNTAINS IN PROJECT.

TAID EVILIDIT HALL TYPE DECEDOOMS

- ACCESSORY/EQUIPMENT LEGEND EXHIBIT HALL-TYPE RESTROOMS
- 2 PAPER TOWEL DISPENSER AUTO, SEMI-RECESSED

 3 PAPER TOWEL/TRASH COMBO UNIT AUTO, SEMI-RECESSED

 14 TOILET PARTIT FLOOR-MOUNT ININAL SCREE
- 4 TRASH SEMI-RECESSED WALL MTD.
- 6 DIAPER CHANGING STATION SURFACE-MTD. (UNLESS OTHERWISE NOTED)
- 8 TOILET PAPER DISPENSER DUAL JUMBO ROLL (TYP. IN EACH STALL)
- 9 SEAT COVER DISPENSER (TYP. IN EACH STALL)
- 11 SANITARY DISPOSAL (TYP. IN EACH WOMEN'S STALL)
- TOILET PARTITIONS 1 COMPACT LAMINATE (PHENOLIC), FLOOR-MOUNTED & OVERHEAD BRACED, 58" H, 12" A.F.F.;
- URINAL SCREENS 20" D X 48" H, WALL-MOUNTED

 (18) MIRROR FULL LENGTH 24" X 72"
- 19 MIRROR DOUBLE WIDTH 42" X 54"
- 20> MIRROR SINGLE WIDTH 24" X 54"
- 23 MIRROR SINGLE WIDTH, NARROW 18" X 54"
- 24 MIRROR DOUBLE WIDTH, WIDE 48" X 54"
- \bigcirc 26> MIRROR TRIPLE WIDTH, WIDE 76" X 54"

NOTE: SEE SPECIFICATIONS FOR ADDITIONAL INFORMATION.



WHEELCHAIR ACCESSIBLE TOILET COMPARTMENT - SEE A500 FOR TYPICAL ENLARGED PLANS AND ELEVATIONS.



AMBULATORY ACCESSIBLE TOILET COMPARTMENT - SEE A500 FOR TYPICAL ENLARGED PLANS AND ELEVATIONS.

EXISTING 2-HR FIRE RATED WALL (PER AS-BUILT DRAWINGS) TO REMAIN

PARTITION TYPE - SEE SHEET A500.1

ADA / ICC ANSI A117.1 REQUIRED CLEARANCES

DEMOLITION GENERAL NOTES

- SEE PHOTOS ON SOME SHEETS FOR IMAGES OF TYPICAL EXISTING TOILET ROOMS.
- COORDINATE DEMOLITION SCOPE ITEMS WITH NEW WORK AND MEP DRAWINGS.
- COORDINATE WITH OWNER FOR REMOVED ACCESSORIES, PLUMBING FIXTURES, LIGHTING FIXTURES, CEILING DEVICES, TOILET PARTITIONS, AND SIGNAGE TO BE SALVAGED.
- 4. JANITOR CLOSET DOORS TO REMAIN. PROTECT DURING CONSTRUCTION.
- 5. FOR STEEL BEAMS INDICATED TO BE REMOVED, GC
 TO VERIFY THAT BEAMS ARE NOT SUPPORTING ANY
 BUILDING ELEMENT PRIOR TO DEMOLITION.
 EXERCISE CARE WHEN REMOVING THE BEAMS SO
 AS NOT TO DAMAGE ANY ADJACENT
 CONSTRUCTION. BEAMS APPEAR TO HAVE
 PREVIOUSLY SUPPORTED CEILING-HUNG TOILET
 PARTITIONS, BUT ARE NO LONGER IN USE.

DEMOLITION KEY NOTES

- D.1 REMOVE EXISTING 4" CMU CHASE WALL (AT ROOMS T,V, & W, EXISTING WALL IS 4" METAL FRAMING)

 D.4 REMOVE EXISTING PLUMBING FIXTURE SEE PLUMBING DWGS

 D.5 REMOVE EXISTING COUNTERTOP & SUPPORT FRAMING

 D.6 REMOVE EXISTING TOILET/URINAL PARTITIONS


 D.7 REMOVE EXISTING WALL-MOUNTED ACCESSORIES

 D.8 REMOVE EXISTING CERAMIC FLOOR TILE TO CONCRETE SLAB

 D.9 REMOVE EXISTING CERAMIC WALL TILE & BASE ON ALL INTERIOR WALLS (EXHIBIT ROOMS ONLY, U.N.O.)

 D.10 REMOVE EXISTING GWB CEILING, SUPPORT STRUCTURE, & CEILING-MOUNTED DEVICES THROUGHOUT ROOM SEE MEP
- D.11 REMOVE EXISTING LIGHT FIXTURES SEE ELECTRICAL DWGS.

 D.13 REMOVE EXISTING DOOR THRESHOLD (ALUMINUM THRESHOLD AT EXHIBIT-TYPE ROOMS; MARBLE THRESHOLD AT SEMINAR-TYPE ROOMS)
- D.17 REMOVE EXISTING WALL-MOUNTED SIGNAGE
 D.18 REMOVE EXISTING STEEL BEAM (6" TO 10" DEEP) ABOVE CEILING

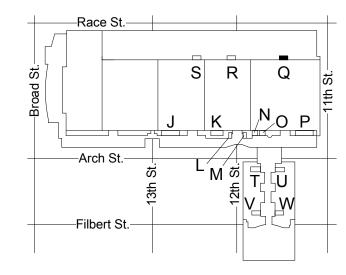

KEY PLAN - LEVEL 200

NTS NTS

DEMOLITION &
NEW FLOOR
PLANS - ROOM Q
(EXHIBIT)

CONVERSE WINKLER

331 MONTGOMERY AVE BALA CYNWYD, PA 19144

ARCHITECTURE

ARCHITECTS:

ARCHITECTURE

Ph: 610.664.0806

Fax: 215.664.1075

MEP ENGINEERS:

ARORA°

Contact: Kevin Sultanik

CSA GROUP

Ph: 215.427.8700

Fax: 215.427.8752

Contact: Wing Au

REVISIONS:

/ANIA CENTER

PENNSYLV,

Description

SUITE 507

Contact: Elin Westrick

e-mail: ewestrick@cwarc.com

P (610) 459-7900 F (610) 459-7950 aroraengineers.com

e-mail: ksultanik@aroraengineers.com

1341 NORTH DELAWARE AVENUE,

STRUCTURAL ENGINEERS:

PHILADELPHIA, PA 19125

e-mail: wau@csagroup.com

Chadds Ford, PA 19317

CONVERSE WINKLER

331 Montgomery Avenue,

Bala Cynwyd, PA, 19144

Date November 25, 2019
Drawn by LC/KR
Checked by EW


Project number

4108

As indicated


CW1615

RESTROOM RENOVATIONS

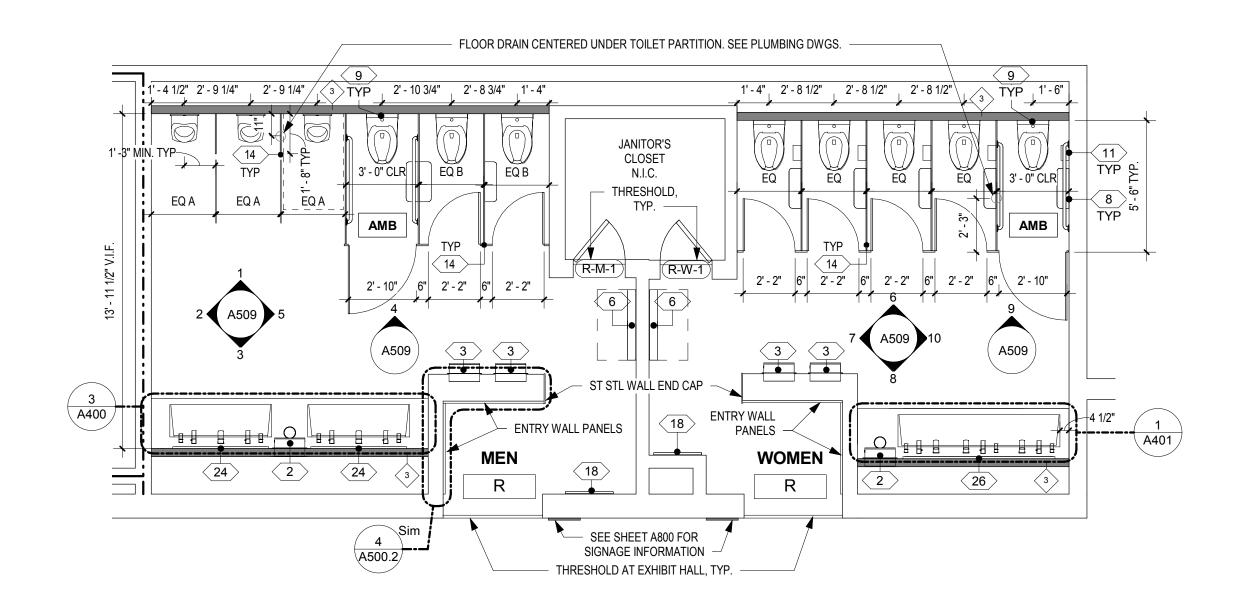

FLOOR PLAN - MEN'S & WOMEN'S ROOM R

A109 | SCALE: 1/4" = 1'-0"

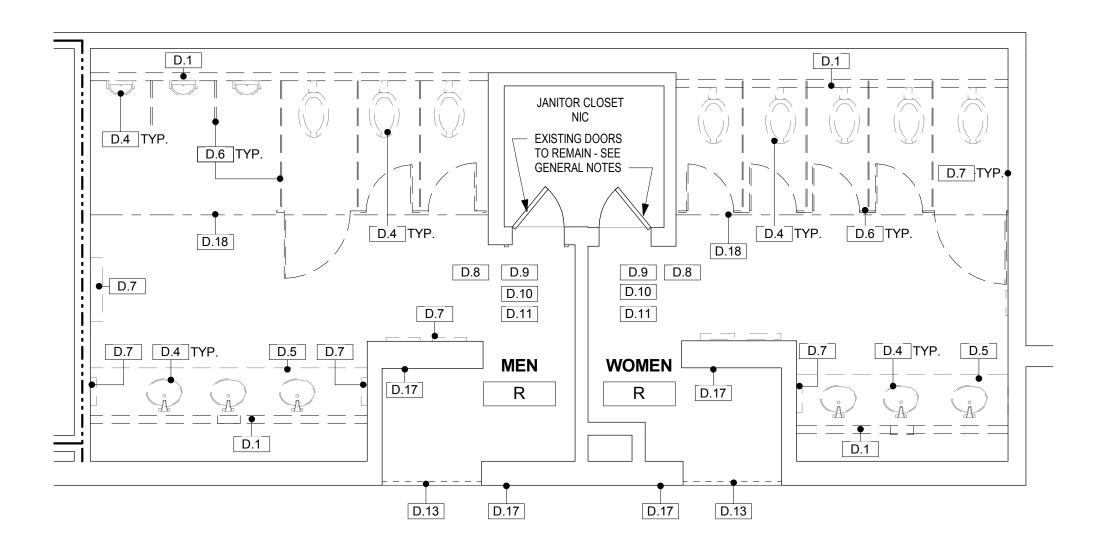

DEMO PLAN - MEN'S & WOMEN'S ROOM R

A109 SCALE: 1/4" = 1'-0"

DRAWING GENERAL NOTES

- 1. JANITOR CLOSET DOORS, HOLLOW METAL FRAMES, AND HARDWARE ARE TO REMAIN AND TO BE REPAINTED AS SCHEDULED. ENTRY DOORS AT SEMINAR- AND BALLROOM-TYPE ROOMS ARE TO BE REPLACED IN KIND IN EXISTING FRAMES. SEE DOOR SCHEDULE ON A600.1 FOR ADDITIONAL INFORMATION. 2. JANITOR CLOSETS ARE NOT IN CONTRACT, EXCEPT TO REPAINT
- INTERIOR AND EXTERIOR OF DOORS AND FRAMES AND TO PROVIDE NEW DOOR THRESHOLDS. 3. CONTRACTOR IS TO VERIFY THE CONDITION OF EXISTING SUBSTRATES TO RECEIVE NEW FINISHES AND CONFIRM
- SUITABILITY. IF EXISTING FLOORS DO NOT MEET MEET ALLOWABLE TOLERANCES PER ANSI STANDARDS FOR LARGE-FORMAT TILE, FLASH FLOORS TO LEVEL. SCRIBE WALL TILE AS NECESSARY TO ACCOMMODATE FLOOR LEVEL WITHIN ALLOWABLE TOLERANCE.
- 4. INFILL AND/OR PATCH FLOORS AND WALLS WHERE TOILET PARTITIONS, ACCESSORIES, OR WALLS REMOVED, AND PROVIDE
- A SOUND AND LEVEL SURFACE TO RECEIVE NEW FINISH. 5. IN SEMINAR/BALLROOM TYPE ROOMS, EXISTING CERAMIC WALL TILE IS TO REMAIN ON WALLS TO REMAIN AND NEW SCHEDULED TILE IS TO BE INSTALLED OVER EXISTING TILE. CONTRACTOR TO VERIFY THAT LEVELNESS OF SURFACE IS WITHIN REQUIRED
- REMOVED AND ACCOUNT FOR ANY DIFFERENCE IN THICKNESS OF NEW TILE ASSEMBLY.
- 8. NEW PLUMBING FIXTURE LOCATIONS DIFFER FROM EXISTING FIXTURE LOCATIONS. FIXTURE CARRIERS AND ASSOCIATED

7. GC TO VERIFY THICKNESS OF CERAMIC TILE ASSEMBLY TO BE

- PLUMBING ARE TO BE RELOCATED TO DIMENSIONS SHOWN ON DRAWINGS. 9. SEE SHEET A500 FOR ENLARGED PLANS AND ELEVATIONS OF TYPICAL TOILET COMPARTMENTS AND TYPICAL ACCESSORY
- MOUNTING HEIGHTS. 10. SEE SHEET A500.1 FOR PARTITION TYPES. NEW WALLS ARE TO BE CONSTRUCTED IN THE IN SAME LOCATION AS EXISTING
- DEMOLISHED WALLS, UNLESS NOTED OTHERWISE. 11. SEE A600 SERIES SHEETS FOR REFLECTED CEILING PLANS,
- FINISH PLANS, AND FINISH SCHEDULES. 12. SEE OVERALL BUILDING PLANS ON SHEETS A001, A002, & A003 FOR LOCATIONS OF ALL DRINKING FOUNTAINS IN PROJECT.

ACCESSORY/EQUIPMENT LEGEND - EXHIBIT HALL-TYPE RESTROOMS

- 2 PAPER TOWEL DISPENSER AUTO, SEMI-RECESSED
- 3 PAPER TOWEL/TRASH COMBO UNIT AUTO, SEMI-RECESSED
- 4 TRASH SEMI-RECESSED WALL MTD. 6 DIAPER CHANGING STATION - SURFACE-MTD. (UNLESS

TOLERANCES FOR SPECIFIED NEW TILE FINISH.

- OTHERWISE NOTED)
- (8) TOILET PAPER DISPENSER DUAL JUMBO ROLL (TYP. IN EACH STALL)
- 9 SEAT COVER DISPENSER (TYP. IN EACH STALL) (11) SANITARY DISPOSAL (TYP. IN EACH WOMEN'S STALL)
- 18 MIRROR FULL LENGTH 24" X 72" 19 MIRROR - DOUBLE WIDTH - 42" X 54"

6. NOT USED.

- (20) MIRROR SINGLE WIDTH 24" X 54" 23 MIRROR - SINGLE WIDTH, NARROW - 18" X 54"
- 24 MIRROR DOUBLE WIDTH, WIDE 48" X 54"
- 26 MIRROR TRIPLE WIDTH, WIDE 76" X 54"

NOTE: SEE SPECIFICATIONS FOR ADDITIONAL INFORMATION.

(14) TOILET PARTITIONS 1 - COMPACT LAMINATE (PHENOLIC),

URINAL SCREENS 20" D X 48" H, WALL-MOUNTED

FLOOR-MOUNTED & OVERHEAD BRACED, 58" H. 12" A.F.F.

WHEELCHAIR ACCESSIBLE TOILET COMPARTMENT - SEE A500 FOR TYPICAL ENLARGED PLANS AND ELEVATIONS.

AMBULATORY ACCESSIBLE TOILET COMPARTMENT - SEE A500 FOR TYPICAL ENLARGED PLANS AND ELEVATIONS.

NO SYMBOL UNLESS OTHERWISE NOTED, TOILET COMPARTMENTS ARE STANDARD.

ADA / ICC ANSI A117.1 REQUIRED CLEARANCES **— - - —** EXISTING 2-HR FIRE RATED WALL (PER AS-BUILT DRAWINGS) TO REMAIN


PARTITION TYPE - SEE SHEET A500.1

DEMOLITION GENERAL NOTES

- 1. SEE PHOTOS ON SOME SHEETS FOR IMAGES OF TYPICAL EXISTING TOILET ROOMS. 2. COORDINATE DEMOLITION SCOPE ITEMS WITH NEW
- WORK AND MEP DRAWINGS.
- 3. COORDINATE WITH OWNER FOR REMOVED ACCESSORIES, PLUMBING FIXTURES, LIGHTING FIXTURES, CEILING DEVICES, TOILET PARTITIONS, AND SIGNAGE TO BE SALVAGED.
- 4. JANITOR CLOSET DOORS TO REMAIN. PROTECT DURING CONSTRUCTION.
- 5. FOR STEEL BEAMS INDICATED TO BE REMOVED. GC TO VERIFY THAT BEAMS ARE NOT SUPPORTING ANY BUILDING ELEMENT PRIOR TO DEMOLITION. EXERCISE CARE WHEN REMOVING THE BEAMS SO AS NOT TO DAMAGE ANY ADJACENT CONSTRUCTION. BEAMS APPEAR TO HAVE PREVIOUSLY SUPPORTED CEILING-HUNG TOILET PARTITIONS, BUT ARE NO LONGER IN USE.

DEMOLITION KEY NOTES

- REMOVE EXISTING 4" CMU CHASE WALL (AT ROOMS T.V. & W. EXISTING WALL IS 4" METAL FRAMING) REMOVE EXISTING PLUMBING FIXTURE - SEE PLUMBING DWGS REMOVE EXISTING COUNTERTOP & SUPPORT FRAMING REMOVE EXISTING TOILET/URINAL PARTITIONS REMOVE EXISTING WALL-MOUNTED ACCESSORIES REMOVE EXISTING CERAMIC FLOOR TILE TO CONCRETE SLAB REMOVE EXISTING CERAMIC WALL TILE & BASE ON ALL INTERIOR WALLS (EXHIBIT ROOMS ONLY, U.N.O.) REMOVE EXISTING GWB CEILING, SUPPORT STRUCTURE, & CEILING-MOUNTED DEVICES THROUGHOUT ROOM - SEE MEP
- REMOVE EXISTING LIGHT FIXTURES SEE ELECTRICAL DWGS. REMOVE EXISTING DOOR THRESHOLD (ALUMINUM THRESHOLD AT EXHIBIT-TYPE ROOMS; MARBLE THRESHOLD AT SEMINAR-TYPE
- REMOVE EXISTING WALL-MOUNTED SIGNAGE REMOVE EXISTING STEEL BEAM (6" TO 10" DEEP) ABOVE CEILING

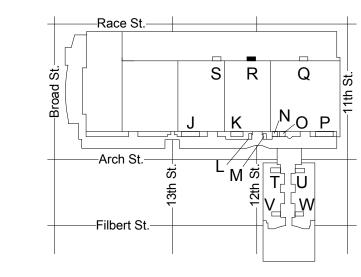

KEY PLAN - LEVEL 200

NTS

Checked by A109

Project number

CW1615

RESTROOM RENOVATIONS PENNSYLV NVENTION $\overline{\mathsf{O}}$

CONVERSE WINKLER

ARCHITECTURE 331 MONTGOMERY AVE BALA CYNWYD, PA 19144

ARCHITECTS:

ARCHITECTURE

Ph: 610.664.0806

Fax: 215.664.1075

MEP ENGINEERS:

ARORA°

Contact: Kevin Sultanik

CSA GROUP

Ph: 215.427.8700

Fax: 215.427.8752

Contact: Wing Au

REVISIONS:

/ANIA CENTER

Description

SUITE 507

STRUCTURAL ENGINEERS:

PHILADELPHIA, PA 19125

e-mail: wau@csagroup.com

Contact: Elin Westrick

e-mail: ewestrick@cwarc.com

P (610) 459-7900 | F (610) 459-7950 | aroraengineers.com

e-mail: ksultanik@aroraengineers.com

1341 NORTH DELAWARE AVENUE,

Arora Engineers, Inc.

Chadds Ford, PA 19317


CONVERSE WINKLER

331 Montgomery Avenue,

Bala Cynwyd, PA, 19144


DEMOLITION & NEW FLOOR PLANS - ROOM R (EXHIBIT)

November 25, 2019 Date LC/KR Drawn by ΕW

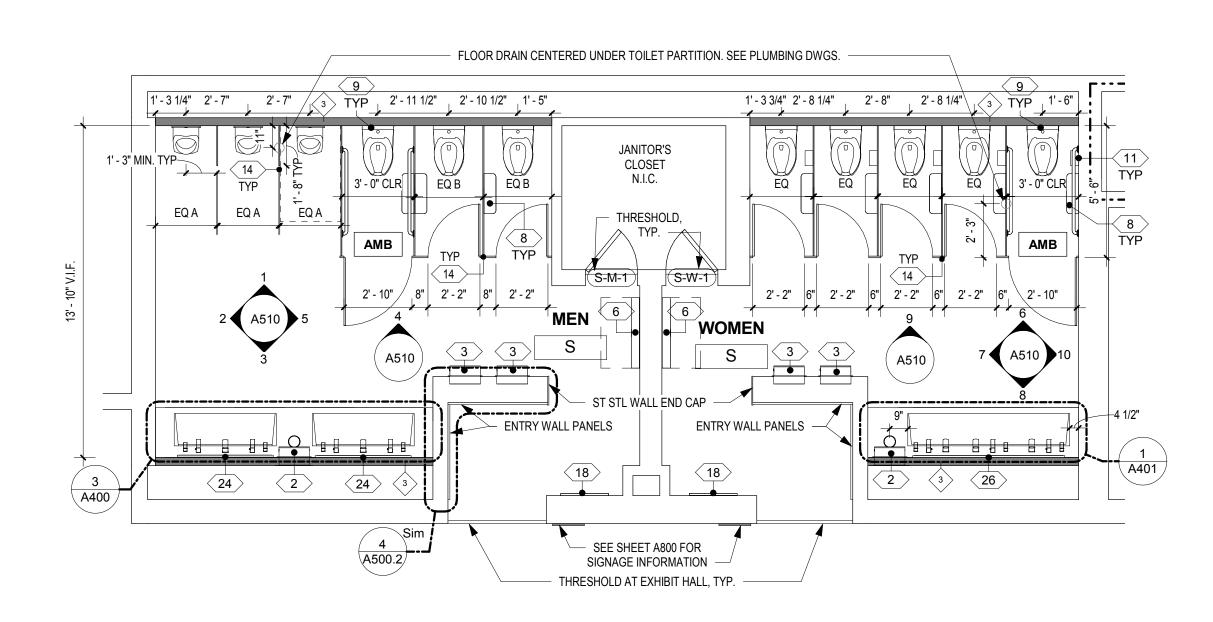

FLOOR PLAN - MEN'S & WOMEN'S ROOM S

A110 SCALE: 1/4" = 1'-0"

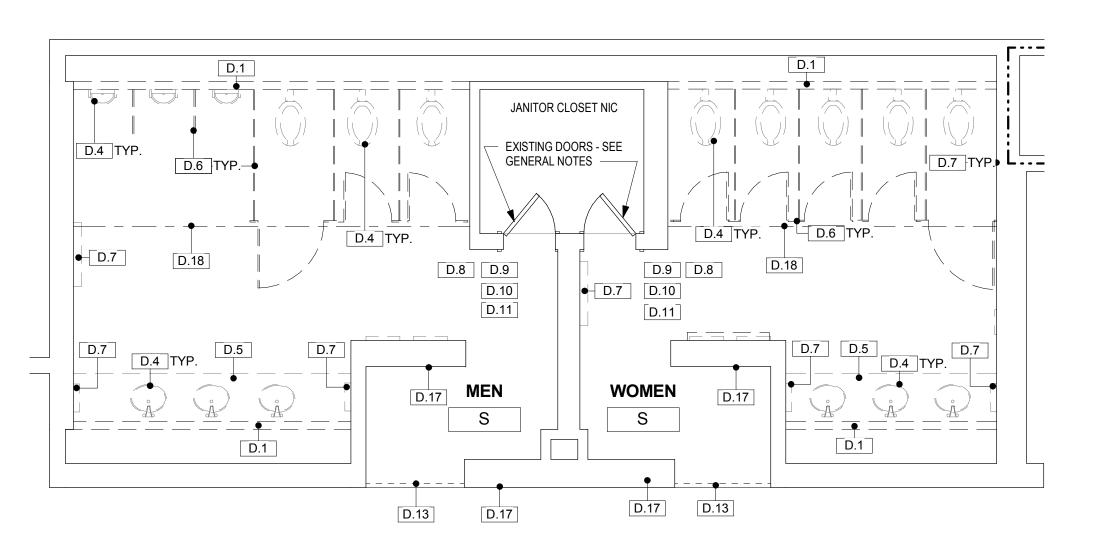

DEMO PLAN - MEN'S & WOMEN'S ROOM S

A110 SCALE: 1/4" = 1'-0"

DRAWING GENERAL NOTES

- 1. JANITOR CLOSET DOORS, HOLLOW METAL FRAMES, AND HARDWARE ARE TO REMAIN AND TO BE REPAINTED AS SCHEDULED. ENTRY DOORS AT SEMINAR- AND BALLROOM-TYPE ROOMS ARE TO BE REPLACED IN KIND IN EXISTING FRAMES. SEE DOOR SCHEDULE ON A600.1 FOR ADDITIONAL INFORMATION.
- JANITOR CLOSETS ARE NOT IN CONTRACT, EXCEPT TO REPAINT INTERIOR AND EXTERIOR OF DOORS AND FRAMES AND TO PROVIDE NEW DOOR THRESHOLDS
- 3. CONTRACTOR IS TO VERIFY THE CONDITION OF EXISTING SUBSTRATES TO RECEIVE NEW FINISHES AND CONFIRM SUITABILITY. IF EXISTING FLOORS DO NOT MEET MEET ALLOWABLE TOLERANCES PER ANSI STANDARDS FOR LARGE-FORMAT TILE, FLASH FLOORS TO LEVEL. SCRIBE WALL TILE AS NECESSARY TO ACCOMMODATE FLOOR LEVEL WITHIN ALLOWABLE TOLERANCE.
- 4. INFILL AND/OR PATCH FLOORS AND WALLS WHERE TOILET PARTITIONS, ACCESSORIES, OR WALLS REMOVED, AND PROVIDE A SOUND AND LEVEL SURFACE TO RECEIVE NEW FINISH.
- IN SEMINAR/BALLROOM TYPE ROOMS, EXISTING CERAMIC WALL TILE IS TO REMAIN ON WALLS TO REMAIN AND NEW SCHEDULED TILE IS TO BE INSTALLED OVER EXISTING TILE. CONTRACTOR TO VERIFY THAT LEVELNESS OF SURFACE IS WITHIN REQUIRED TOLERANCES FOR SPECIFIED NEW TILE FINISH.

- GC TO VERIFY THICKNESS OF CERAMIC TILE ASSEMBLY TO BE REMOVED AND ACCOUNT FOR ANY DIFFERENCE IN THICKNESS OF NEW TILE ASSEMBLY.
- NEW PLUMBING FIXTURE LOCATIONS DIFFER FROM EXISTING FIXTURE LOCATIONS. FIXTURE CARRIERS AND ASSOCIATED PLUMBING ARE TO BE RELOCATED TO DIMENSIONS SHOWN ON
- DRAWINGS. 9. SEE SHEET A500 FOR ENLARGED PLANS AND ELEVATIONS OF TYPICAL TOILET COMPARTMENTS AND TYPICAL ACCESSORY
- MOUNTING HEIGHTS. 10. SEE SHEET A500.1 FOR PARTITION TYPES. NEW WALLS ARE TO
- BE CONSTRUCTED IN THE IN SAME LOCATION AS EXISTING DEMOLISHED WALLS, UNLESS NOTED OTHERWISE. 11. SEE A600 SERIES SHEETS FOR REFLECTED CEILING PLANS,
- FINISH PLANS, AND FINISH SCHEDULES. 12. SEE OVERALL BUILDING PLANS ON SHEETS A001, A002, & A003 FOR LOCATIONS OF ALL DRINKING FOUNTAINS IN PROJECT.

ACCESSORY/EQUIPMENT LEGEND - EXHIBIT HALL-TYPE RESTROOMS

- 2 PAPER TOWEL DISPENSER AUTO, SEMI-RECESSED 3 PAPER TOWEL/TRASH COMBO UNIT - AUTO, SEMI-RECESSED
- 4 TRASH SEMI-RECESSED WALL MTD.
- 6 DIAPER CHANGING STATION SURFACE-MTD. (UNLESS OTHERWISE NOTED)
- $\overline{(8)}$ Toilet paper dispenser Dual Jumbo Roll (Typ. in EACH STALL)
- 9 SEAT COVER DISPENSER (TYP. IN EACH STALL)
- 11 SANITARY DISPOSAL (TYP. IN EACH WOMEN'S STALL)
- (14) TOILET PARTITIONS 1 COMPACT LAMINATE (PHENOLIC), FLOOR-MOUNTED & OVERHEAD BRACED, 58" H, 12" A.F.F.; URINAL SCREENS 20" D X 48" H, WALL-MOUNTED
- (18) MIRROR FULL LENGTH 24" X 72"
- (19) MIRROR DOUBLE WIDTH 42" X 54"
- <20 MIRROR SINGLE WIDTH 24" X 54"
- 23 MIRROR SINGLE WIDTH, NARROW 18" X 54"
- 24 MIRROR DOUBLE WIDTH, WIDE 48" X 54"
- 26 MIRROR TRIPLE WIDTH, WIDE 76" X 54"
- NOTE: SEE SPECIFICATIONS FOR ADDITIONAL INFORMATION.



WHEELCHAIR ACCESSIBLE TOILET COMPARTMENT - SEE A500 FOR TYPICAL ENLARGED

PLANS AND ELEVATIONS.

AMBULATORY ACCESSIBLE TOILET COMPARTMENT - SEE A500 FOR TYPICAL ENLARGED PLANS AND ELEVATIONS.

ADA / ICC ANSI A117.1 REQUIRED CLEARANCES

PARTITION TYPE - SEE SHEET A500.1


DEMOLITION GENERAL NOTES

- 1. SEE PHOTOS ON SOME SHEETS FOR IMAGES OF
- TYPICAL EXISTING TOILET ROOMS. 2. COORDINATE DEMOLITION SCOPE ITEMS WITH NEW
- WORK AND MEP DRAWINGS. 3. COORDINATE WITH OWNER FOR REMOVED ACCESSORIES, PLUMBING FIXTURES, LIGHTING
- FIXTURES, CEILING DEVICES, TOILET PARTITIONS, AND SIGNAGE TO BE SALVAGED. 4. JANITOR CLOSET DOORS TO REMAIN. PROTECT
- DURING CONSTRUCTION.
- 5. FOR STEEL BEAMS INDICATED TO BE REMOVED, GC TO VERIFY THAT BEAMS ARE NOT SUPPORTING ANY BUILDING ELEMENT PRIOR TO DEMOLITION. EXERCISE CARE WHEN REMOVING THE BEAMS SO AS NOT TO DAMAGE ANY ADJACENT CONSTRUCTION. BEAMS APPEAR TO HAVE

PREVIOUSLY SUPPORTED CEILING-HUNG TOILET

PARTITIONS, BUT ARE NO LONGER IN USE.

- **DEMOLITION KEY NOTES**
- REMOVE EXISTING 4" CMU CHASE WALL (AT ROOMS T,V, & W, EXISTING WALL IS 4" METAL FRAMING) REMOVE EXISTING PLUMBING FIXTURE - SEE PLUMBING DWGS REMOVE EXISTING COUNTERTOP & SUPPORT FRAMING REMOVE EXISTING TOILET/URINAL PARTITIONS REMOVE EXISTING WALL-MOUNTED ACCESSORIES REMOVE EXISTING CERAMIC FLOOR TILE TO CONCRETE SLAB
- REMOVE EXISTING CERAMIC WALL TILE & BASE ON ALL INTERIOR WALLS (EXHIBIT ROOMS ONLY, U.N.O.) REMOVE EXISTING GWB CEILING, SUPPORT STRUCTURE, & CEILING-MOUNTED DEVICES THROUGHOUT ROOM - SEE MEP
- REMOVE EXISTING LIGHT FIXTURES SEE ELECTRICAL DWGS. REMOVE EXISTING DOOR THRESHOLD (ALUMINUM THRESHOLD AT EXHIBIT-TYPE ROOMS: MARBLE THRESHOLD AT SEMINAR-TYPE
- REMOVE EXISTING WALL-MOUNTED SIGNAGE REMOVE EXISTING STEEL BEAM (6" TO 10" DEEP) ABOVE CEILING

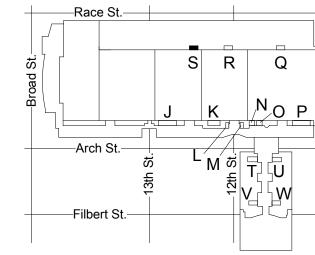

KEY PLAN - LEVEL 200

Project number November 25, 2019 Date NTS

Drawn by

NO SYMBOL UNLESS OTHERWISE NOTED, TOILET COMPARTMENTS ARE STANDARD. **REVISIONS:** Description — - - — EXISTING 2-HR FIRE RATED WALL (PER AS-BUILT DRAWINGS) TO REMAIN

CONVERSE WINKLER

ARCHITECTURE

ARCHITECTS:

ARCHITECTURE

Ph: 610.664.0806

Fax: 215.664.1075

MEP ENGINEERS:

Contact: Kevin Sultanik

CSA GROUP

Ph: 215.427.8700

Fax: 215.427.8752

Contact: Wing Au

SUITE 507

STRUCTURAL ENGINEERS:

PHILADELPHIA, PA 19125

e-mail: wau@csagroup.com

Contact: Elin Westrick

e-mail: ewestrick@cwarc.com

P (610) 459-7900 | F (610) 459-7950 | aroraengineers.com

e-mail: ksultanik@aroraengineers.com

1341 NORTH DELAWARE AVENUE,

Arora Engineers, Inc.

Chadds Ford, PA 19317

CONVERSE WINKLER

331 Montgomery Avenue,

Bala Cynwyd, PA, 19144

331 MONTGOMERY AVE BALA CYNWYD, PA 19144

/ANIA | CENTER RESTROOM RENOVATIONS PENNSYLVA CONVENTION C

DEMOLITION & NEW FLOOR PLANS - ROOM S (EXHIBIT)

EW Checked by

As indicated


CW1615

LC/KR

DRAWING GENERAL NOTES

- 1. JANITOR CLOSET DOORS, HOLLOW METAL FRAMES, AND HARDWARE ARE TO REMAIN AND TO BE REPAINTED AS SCHEDULED. ENTRY DOORS AT SEMINAR- AND BALLROOM-TYPE ROOMS ARE TO BE REPLACED IN KIND IN EXISTING FRAMES. SEE
- 2. JANITOR CLOSETS ARE NOT IN CONTRACT, EXCEPT TO REPAINT INTERIOR AND EXTERIOR OF DOORS AND FRAMES AND TO PROVIDE NEW DOOR THRESHOLDS.
- 4. INFILL AND/OR PATCH FLOORS AND WALLS WHERE TOILET A SOUND AND LEVEL SURFACE TO RECEIVE NEW FINISH.
- 6. NOT USED. 7. GC TO VERIFY THICKNESS OF CERAMIC TILE ASSEMBLY TO BE
- REMOVED AND ACCOUNT FOR ANY DIFFERENCE IN THICKNESS OF NEW TILE ASSEMBLY. 8. NEW PLUMBING FIXTURE LOCATIONS DIFFER FROM EXISTING
- PLUMBING ARE TO BE RELOCATED TO DIMENSIONS SHOWN ON DRAWINGS 9. SEE SHEET A500 FOR ENLARGED PLANS AND ELEVATIONS OF
- TYPICAL TOILET COMPARTMENTS AND TYPICAL ACCESSORY MOUNTING HEIGHTS. 10. SEE SHEET A500.1 FOR PARTITION TYPES. NEW WALLS ARE TO
- BE CONSTRUCTED IN THE IN SAME LOCATION AS EXISTING DEMOLISHED WALLS, UNLESS NOTED OTHERWISE. 11. SEE A600 SERIES SHEETS FOR REFLECTED CEILING PLANS,
- FINISH PLANS, AND FINISH SCHEDULES. 12. SEE OVERALL BUILDING PLANS ON SHEETS A001, A002, & A003 FOR LOCATIONS OF ALL DRINKING FOUNTAINS IN PROJECT.

WHEELCHAIR ACCESSIBLE TOILET COMPARTMENT - SEE A500 FOR TYPICAL ENLARGED PLANS AND ELEVATIONS.

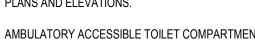

AMBULATORY ACCESSIBLE TOILET COMPARTMENT - SEE A500 FOR TYPICAL ENLARGED PLANS AND ELEVATIONS.

NO SYMBOL UNLESS OTHERWISE NOTED, TOILET COMPARTMENTS ARE STANDARD.

ADA / ICC ANSI A117.1 REQUIRED CLEARANCES L _ _ _ J

--- EXISTING 2-HR FIRE RATED WALL (PER AS-BUILT DRAWINGS) TO REMAIN



PARTITION TYPE - SEE SHEET A500.1

ACCESSORY/EQUIPMENT LEGEND -SEMINAR-TYPE RESTROOMS

- 1 HAND DRYER SEMI-RECESSED
- 2 PAPER TOWEL DISPENSER AUTO, SEMI-RECESSED
- 3 PAPER TOWEL/TRASH COMBO UNIT AUTO, SEMI-RECESSED
- 4 TRASH SEMI-RECESSED WALL MTD.
- OTHERWISE NOTED) 8 TOILET PAPER DISPENSER - DUAL JUMBO ROLL (TYP. IN
- EACH STALL)

6 DIAPER CHANGING STATION - SURFACE-MTD. (UNLESS


- 9 SEAT COVER DISPENSER (TYP. IN EACH STALL)
- (11) SANITARY DISPOSAL (TYP. IN EACH WOMEN'S STALL) 15 TOILET PARTITIONS 2 - COMPACT HIGH-PRESSURE
- LAMINATE (PHENOLIC), 81" HIGH INCL 9" SUPPORT LEGS; URINAL SCREENS 20" D X 60" H, WALL-MTD. - SEE SPEC FOR COLOR SELECTION
- 18 MIRROR FULL LENGTH 24" X 72"
- 19 MIRROR DOUBLE WIDTH 42" X 54"
- (20) MIRROR SINGLE WIDTH 24" X 54"
- 23 MIRROR SINGLE WIDTH, NARROW 18" X 54"
- 24 MIRROR DOUBLE WIDTH, WIDE 48" X 54" (25) MIRROR - DOUBLE WIDTH, WIDE - 48" X 48"
- NOTE: SEE SPECIFICATIONS FOR ADDITIONAL INFORMATION.

DEMOLITION GENERAL NOTES

- 1. SEE PHOTOS ON SOME SHEETS FOR IMAGES OF
- TYPICAL EXISTING TOILET ROOMS. 2. COORDINATE DEMOLITION SCOPE ITEMS WITH NEW WORK AND MEP DRAWINGS.
- 3. COORDINATE WITH OWNER FOR REMOVED ACCESSORIES, PLUMBING FIXTURES, LIGHTING FIXTURES, CEILING DEVICES, TOILET PARTITIONS,
- AND SIGNAGE TO BE SALVAGED. 4. JANITOR CLOSET DOORS TO REMAIN. PROTECT
- DURING CONSTRUCTION. 5. FOR STEEL BEAMS INDICATED TO BE REMOVED, GC TO VERIFY THAT BEAMS ARE NOT SUPPORTING ANY BUILDING ELEMENT PRIOR TO DEMOLITION. AS NOT TO DAMAGE ANY ADJACENT
- EXERCISE CARE WHEN REMOVING THE BEAMS SO CONSTRUCTION. BEAMS APPEAR TO HAV PREVIOUSLY SUPPORTED CEILING-HUNG TOILET PARTITIONS, BUT ARE NO LONGER IN USE.

DEMOLITION KEY NOTES

- REMOVE EXISTING 4" CMU CHASE WALL (AT ROOMS T,V, & W. EXISTING WALL IS 4" METAL FRAMING) REMOVE EXISTING PLUMBING FIXTURE - SEE PLUMBING DWGS REMOVE EXISTING COUNTERTOP & SUPPORT FRAMING REMOVE EXISTING TOILET/URINAL PARTITIONS
- REMOVE EXISTING WALL-MOUNTED ACCESSORIES REMOVE EXISTING CERAMIC FLOOR TILE TO CONCRETE SLAE REMOVE EXISTING GWB CEILING, SUPPORT STRUCTURE, &
- CEILING-MOUNTED DEVICES THROUGHOUT ROOM SEE MEP REMOVE EXISTING LIGHT FIXTURES - SEE ELECTRICAL DWG
- REMOVE EXISTING DOOR THRESHOLD (ALUMINUM THRESHOLD AT EXHIBIT-TYPE ROOMS; MARBLE THRESHOLD AT SEMINAR-TYPE ROOMS)
- REMOVE EXISTING WALL-MOUNTED SIGNAGE REMOVE EXISTING STEEL BEAM (6" TO 10" DEEP) ABOVE
- REMOVE EXISTING ENTRY DOOR AND HARDWARE EXISTING HM FRAME TO REMAIN AND RECEIVE NEW DOOR

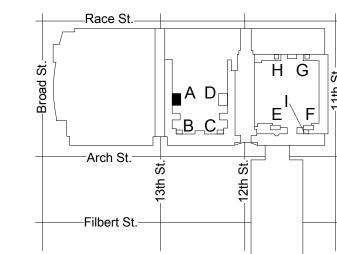

KEY PLAN - LEVEL 100

NEW FLOOR PLANS - ROOM A (SEMINAR) Project number Date November 25, 2019

NTS

Checked by

Drawn by

As indicated

DEMOLITION &

CONVERSE WINKLER ARCHITECTURE

331 MONTGOMERY AVE BALA CYNWYD, PA 19144

ARCHITECTS:

ARCHITECTURE

Ph: 610.664.0806

Fax: 215.664.1075

MEP ENGINEERS:

Contact: Kevin Sultanik

CSA GROUP

Ph: 215.427.8700

Fax: 215.427.8752

Contact: Wing Au

REVISIONS:

/ANIA CENTER

CONVENTION C

RESTROOM RENOVATIONS

CW1615

LC/KR

ΕW

Description

SUITE 507

STRUCTURAL ENGINEERS:

PHILADELPHIA, PA 19125

e-mail: wau@csagroup.com

Contact: Elin Westrick

e-mail: ewestrick@cwarc.com

P (610) 459-7900 | F (610) 459-7950 | aroraengineers.com

e-mail: ksultanik@aroraengineers.com

1341 NORTH DELAWARE AVENUE,

Arora Engineers, Inc.

Chadds Ford, PA 19317

CONVERSE WINKLER

331 Montgomery Avenue,

Bala Cynwyd, PA, 19144

DOOR SCHEDULE ON A600.1 FOR ADDITIONAL INFORMATION. FIXTURE LOCATIONS. FIXTURE CARRIERS AND ASSOCIATED

3. CONTRACTOR IS TO VERIFY THE CONDITION OF EXISTING SUBSTRATES TO RECEIVE NEW FINISHES AND CONFIRM SUITABILITY. IF EXISTING FLOORS DO NOT MEET MEET ALLOWABLE TOLERANCES PER ANSI STANDARDS FOR LARGE-FORMAT TILE, FLASH FLOORS TO LEVEL. SCRIBE WALL TILE AS NECESSARY TO ACCOMMODATE FLOOR LEVEL WITHIN ALLOWABLE TOLERANCE

PARTITIONS, ACCESSORIES, OR WALLS REMOVED, AND PROVIDE 5. IN SEMINAR/BALLROOM TYPE ROOMS, EXISTING CERAMIC WALL

TILE IS TO REMAIN ON WALLS TO REMAIN AND NEW SCHEDULED TILE IS TO BE INSTALLED OVER EXISTING TILE. CONTRACTOR TO VERIFY THAT LEVELNESS OF SURFACE IS WITHIN REQUIRED TOLERANCES FOR SPECIFIED NEW TILE FINISH.

SEE SHEET A801 FOR SIGNAGE INFORMATION **NEW CHASE** WALLS IN SAME SEE SHEET A 500 LOCATION AS FOR GRAB BAR 2' - 8" 2' - 8" 2' - 8" 2' - 8" 2' - 8" 2' - 10 1/4" **EXISTING** DIMENSIONS & LOCATIONS, TYP TYP - EXISTING TYP VESTIBULE TYP EQ EQ EQ 3' - 0" CLR N.I.C. SEE SHEET A801 FOR SIGNAGE INFORMATION 5' - 3 1/2" (A-W-1) |6"| |2' - 2" |6"| 2' - 2" |6", \ 2' - 10" ||6", \ \^3' - 0" \ ++ ++ ++ ++ ++₁₀ REPLACE MARBLE THRESHOLD IN KIND TURNING ACCENT FLOOR ACCENT FLOOR TURNING Α TILE - SEE A611 (A511 **RADIUS** 12 TILE - SEE A611 7 RADIUS FOR FINISH PLAN 1' - 6 1/2"-FOR FINISH PLAN (A-W-2) JANITOR'S CLOSET ENHANCED REACH RANGE FAUCET $\overline{}$ AND SOAP DISPENSER AT THIS $\overline{}$

LOCATION - SEE SHEET A500.5

4 FLOOR PLAN - MEN'S ROOM A

- SEE SHEET A801 FOR SIGNAGE INFORMATION

11' - 10" V.I.F.

EQ

AMB

2' - 10"

||| |3' - 0" CLR ||

(20)

ACCENT FLOOR TILE - SEE A611

FOR FINISH PLAN

5' - 9 1/2"

EQ

—1' - 4 3/4" 2' - 10"

(A-M-3)

3> 1 - 0 | 1 - 0 |

EQ

15 TYP

A511 5

EQ

15 TYP

SEE SHEET A500 FOR GRAB BAR

DIMENSIONS & LOCATIONS, TYP.

1' - 4 3/4" 2' - 10"

Α

__ _ EQ__

___1' - 3" MIN. TYP

EQ

NEW CHASE

WALLS IN SAME

STORAGE

ROOM

LOCATION AS

EXISTING

(A-M-4)

A111 | SCALE: 1/4" = 1'-0"

JANITOR'S /

(A-M-2)

A-M-1

EXISTING

N.I.C.

VESTIBULE

RADIUS

3' - 1 1/2"


CLOSET

N.I.C.

REPLACE MARBLE

THRESHOLD IN KIND

SEE SHEET A801 FOR SIGNAGE INFORMATION -

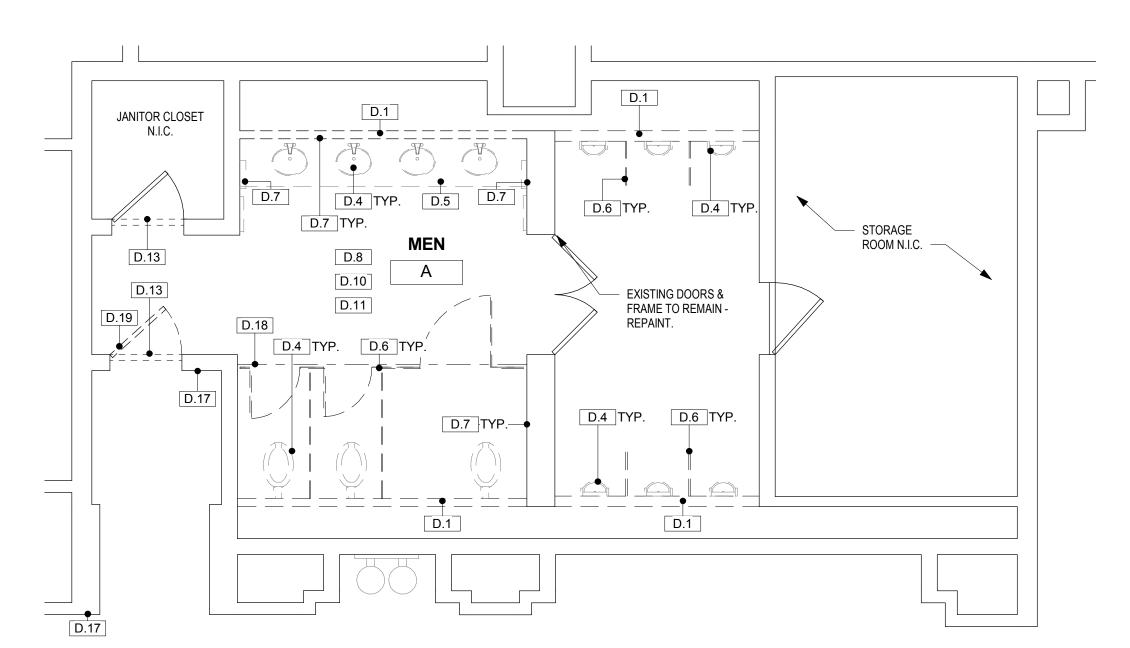


DEMO PLAN - MEN'S ROOM A

A111 SCALE: 1/4" = 1'-0"

3 FLOOR PLAN - WOMEN'S ROOM A

A111 | SCALE: 1/4" = 1'-0"

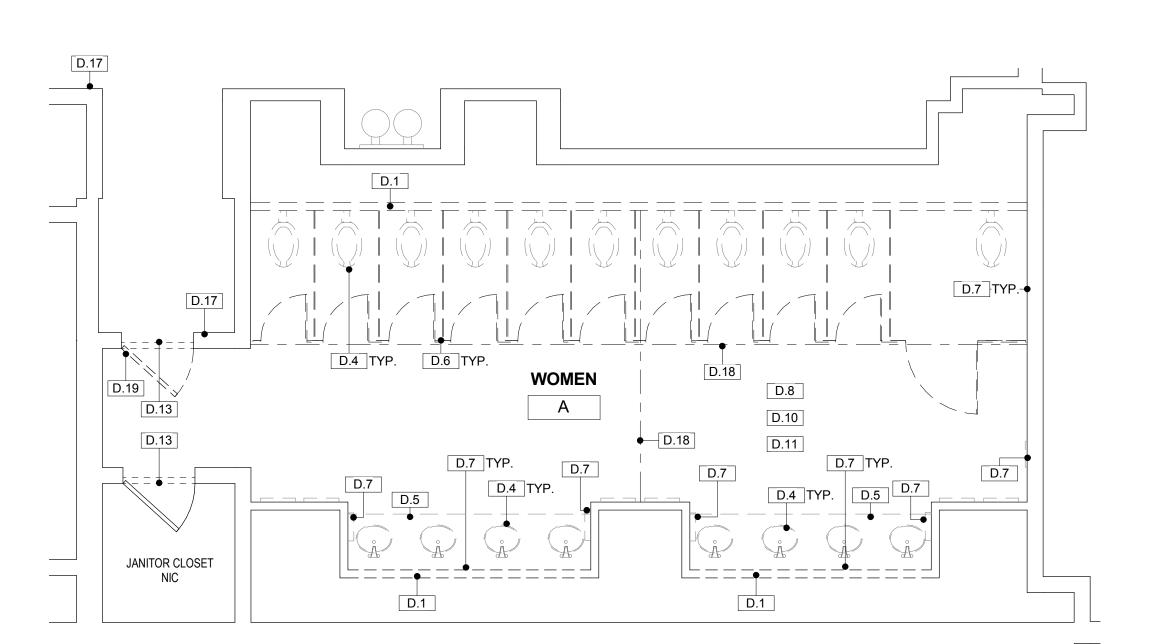

DEMO PLAN - WOMEN'S ROOM A

A111 SCALE: 1/4" = 1'-0"




TYPICAL SMALL SEMINAR RESTROOM -**B MEN'S - EXISTING**




TYPICAL SMALL SEMINAR RESTROOM -**B WOMEN'S - EXISTING**




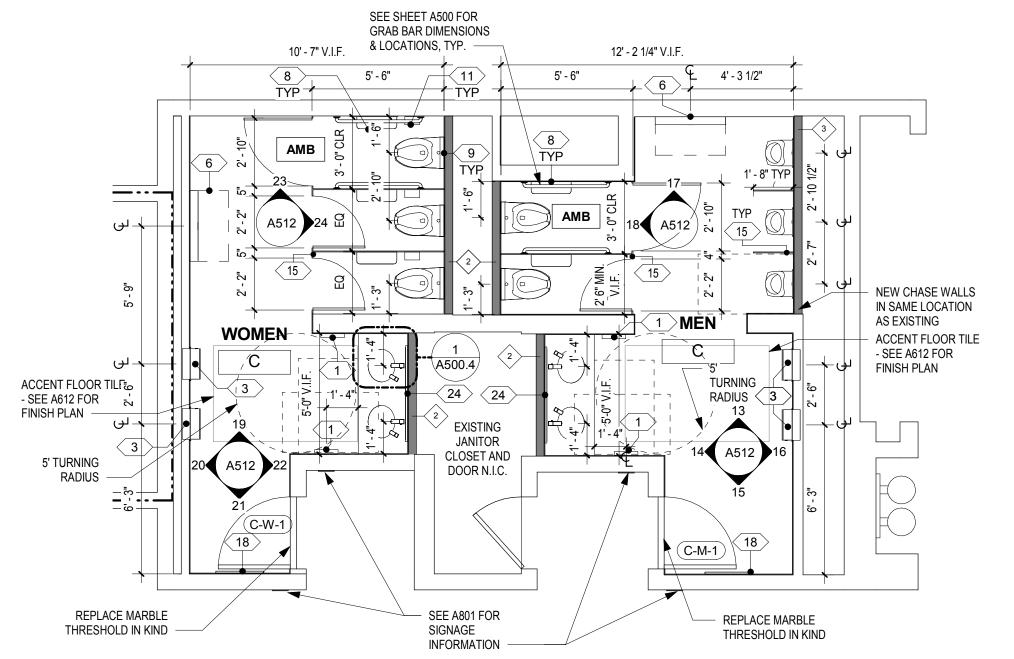

4 FLOOR PLAN - MEN'S & WOMEN'S ROOM C A112 SCALE: 1/4" = 1'-0"

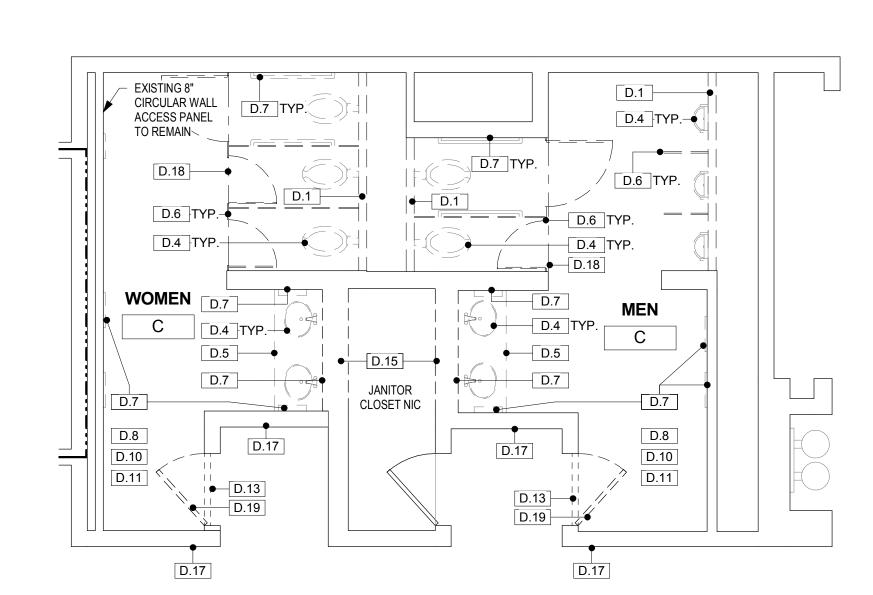


DEMO PLAN - MEN'S & WOMEN'S ROOM C A112 | SCALE: 1/4" = 1'-0"

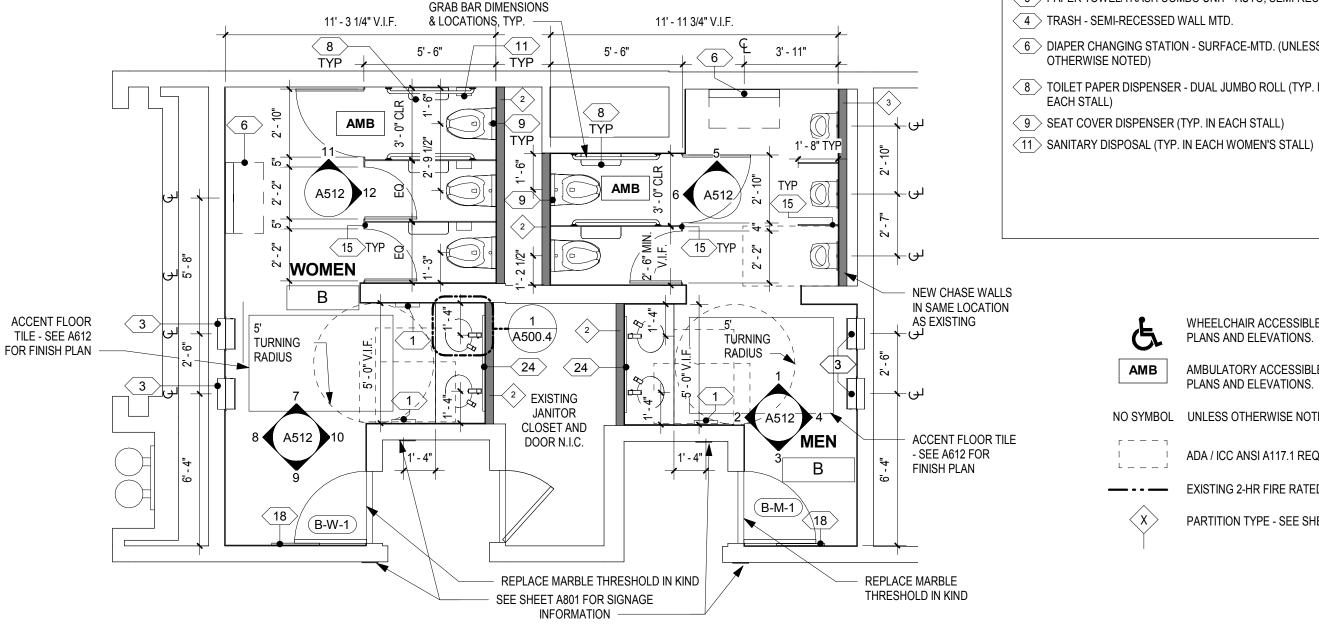

SEE SHEET A500 FOR

3 FLOOR PLAN - MEN'S & WOMEN'S ROOM B A112 | SCALE: 1/4" = 1'-0"

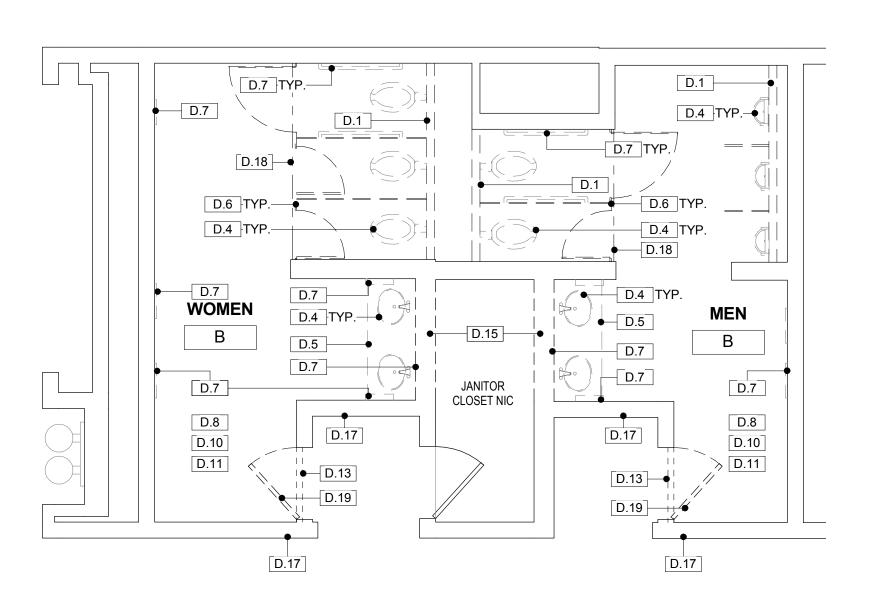

DEMO PLAN - MEN'S & WOMEN'S ROOM B A112 SCALE: 1/4" = 1'-0"

DRAWING GENERAL NOTES

- . JANITOR CLOSET DOORS, HOLLOW METAL FRAMES, AND HARDWARE ARE TO REMAIN AND TO BE REPAINTED AS SCHEDULED. ENTRY DOORS AT SEMINAR- AND BALLROOM-TYPE ROOMS ARE TO BE REPLACED IN KIND IN EXISTING FRAMES. SEE DOOR SCHEDULE ON A600.1 FOR ADDITIONAL INFORMATION.
- JANITOR CLOSETS ARE NOT IN CONTRACT, EXCEPT TO REPAINT INTERIOR AND EXTERIOR OF DOORS AND FRAMES AND TO
- PROVIDE NEW DOOR THRESHOLDS. 3. CONTRACTOR IS TO VERIFY THE CONDITION OF EXISTING SUBSTRATES TO RECEIVE NEW FINISHES AND CONFIRM SUITABILITY. IF EXISTING FLOORS DO NOT MEET MEET ALLOWABLE TOLERANCES PER ANSI STANDARDS FOR LARGE-FORMAT TILE, FLASH FLOORS TO LEVEL. SCRIBE WALL TILE AS NECESSARY TO ACCOMMODATE FLOOR LEVEL WITHIN ALLOWABLE TOLERANCE.
- 4. INFILL AND/OR PATCH FLOORS AND WALLS WHERE TOILET PARTITIONS, ACCESSORIES, OR WALLS REMOVED, AND PROVIDE A SOUND AND LEVEL SURFACE TO RECEIVE NEW FINISH. 5. IN SEMINAR/BALLROOM TYPE ROOMS, EXISTING CERAMIC WALL TILE IS TO REMAIN ON WALLS TO REMAIN AND NEW SCHEDULED TILE IS TO BE INSTALLED OVER EXISTING TILE. CONTRACTOR TO

VERIFY THAT LEVELNESS OF SURFACE IS WITHIN REQUIRED

7. GC TO VERIFY THICKNESS OF CERAMIC TILE ASSEMBLY TO BE REMOVED AND ACCOUNT FOR ANY DIFFERENCE IN THICKNESS OF NEW TILE ASSEMBLY.

CONVERSE **WINKLER**

BALA CYNWYD, PA 19144

ARCHITECTS:

ARCHITECTURE

Ph: 610.664.0806

Fax: 215.664.1075

MEP ENGINEERS:

Contact: Kevin Sultanik

CSA GROUP

Ph: 215.427.8700

Fax: 215.427.8752

Contact: Wing Au

REVISIONS:

/ANIA CENTER

PENNSYLV, CONVENTION (

RESTROOM RENOVATIONS

Description

SUITE 507

STRUCTURAL ENGINEERS:

PHILADELPHIA, PA 19125

e-mail: wau@csagroup.com

Contact: Elin Westrick

e-mail: ewestrick@cwarc.com

P (610) 459-7900 F (610) 459-7950 aroraengineers.com

e-mail: ksultanik@aroraengineers.com

1341 NORTH DELAWARE AVENUE,

Chadds Ford, PA 19317

CONVERSE WINKLER

331 Montgomery Avenue,

Bala Cynwyd, PA, 19144

ARCHITECTURE

- 8. NEW PLUMBING FIXTURE LOCATIONS DIFFER FROM EXISTING FIXTURE LOCATIONS. FIXTURE CARRIERS AND ASSOCIATED
- PLUMBING ARE TO BE RELOCATED TO DIMENSIONS SHOWN ON 9. SEE SHEET A500 FOR ENLARGED PLANS AND ELEVATIONS OF TYPICAL TOILET COMPARTMENTS AND TYPICAL ACCESSORY
- MOUNTING HEIGHTS. 10. SEE SHEET A500.1 FOR PARTITION TYPES. NEW WALLS ARE TO BE CONSTRUCTED IN THE IN SAME LOCATION AS EXISTING
- DEMOLISHED WALLS, UNLESS NOTED OTHERWISE. 11. SEE A600 SERIES SHEETS FOR REFLECTED CEILING PLANS,
- FINISH PLANS, AND FINISH SCHEDULES. 12. SEE OVERALL BUILDING PLANS ON SHEETS A001, A002, & A003 FOR LOCATIONS OF ALL DRINKING FOUNTAINS IN PROJECT.

ACCESSORY/EQUIPMENT LEGEND - SEMINAR-TYPE RESTROOMS

- 4 TRASH SEMI-RECESSED WALL MTD.
- 6 DIAPER CHANGING STATION SURFACE-MTD. (UNLESS OTHERWISE NOTED)
- 8 TOILET PAPER DISPENSER DUAL JUMBO ROLL (TYP. IN EACH STALL)
- SEAT COVER DISPENSER (TYP. IN EACH STALL)
- (15) TOILET PARTITIONS 2 COMPACT HIGH-PRESSURE LAMINATE (PHENOLIC), 81" HIGH INCL 9" SUPPORT LEGS; URINAL SCREENS 20" D X 60" H, WALL-MTD.
- 18 MIRROR FULL LENGTH 24" X 72"
- 19 MIRROR DOUBLE WIDTH 42" X 54" (20) MIRROR - SINGLE WIDTH - 24" X 54"
- 23 MIRROR SINGLE WIDTH, NARROW 18" X 54"
- <24 > MIRROR DOUBLE WIDTH, WIDE 48" X 54"
- 25 MIRROR DOUBLE WIDTH, WIDE 48" X 48"

NOTE: SEE SPECIFICATIONS FOR ADDITIONAL INFORMATION.



WHEELCHAIR ACCESSIBLE TOILET COMPARTMENT - SEE A500 FOR TYPICAL ENLARGED PLANS AND ELEVATIONS.

AMBULATORY ACCESSIBLE TOILET COMPARTMENT - SEE A500 FOR TYPICAL ENLARGED PLANS AND ELEVATIONS.

NO SYMBOL UNLESS OTHERWISE NOTED, TOILET COMPARTMENTS ARE STANDARD.


ADA / ICC ANSI A117.1 REQUIRED CLEARANCES

DEMOLITION GENERAL NOTES

- 1. SEE PHOTOS ON SOME SHEETS FOR IMAGES OF TYPICAL EXISTING TOILET ROOMS. 2. COORDINATE DEMOLITION SCOPE ITEMS WITH NEW
- WORK AND MEP DRAWINGS. 3. COORDINATE WITH OWNER FOR REMOVED
- ACCESSORIES, PLUMBING FIXTURES, LIGHTING FIXTURES, CEILING DEVICES, TOILET PARTITIONS. AND SIGNAGE TO BE SALVAGED.
- 4. JANITOR CLOSET DOORS TO REMAIN. PROTECT DURING CONSTRUCTION.
- 5. FOR STEEL BEAMS INDICATED TO BE REMOVED, GC TO VERIFY THAT BEAMS ARE NOT SUPPORTING ANY BUILDING ELEMENT PRIOR TO DEMOLITION. EXERCISE CARE WHEN REMOVING THE BEAMS SO AS NOT TO DAMAGE ANY ADJACENT CONSTRUCTION. BEAMS APPEAR TO HAVE PREVIOUSLY SUPPORTED CEILING-HUNG TOILET

PARTITIONS, BUT ARE NO LONGER IN USE.

- REMOVE EXISTING 4" CMU CHASE WALL (AT ROOMS T,V, & W, EXISTING WALL IS 4" METAL FRAMING) REMOVE EXISTING PLUMBING FIXTURE - SEE PLUMBING DWGS REMOVE EXISTING COUNTERTOP & SUPPORT FRAMING REMOVE EXISTING TOILET/URINAL PARTITIONS REMOVE EXISTING WALL-MOUNTED ACCESSORIES REMOVE EXISTING CERAMIC FLOOR TILE TO CONCRETE SLAB REMOVE EXISTING GWB CEILING, SUPPORT STRUCTURE, &
- CEILING-MOUNTED DEVICES THROUGHOUT ROOM SEE MEP REMOVE EXISTING LIGHT FIXTURES - SEE ELECTRICAL DWGS.
- AT EXHIBIT-TYPE ROOMS; MARBLE THRESHOLD AT SEMINAR-TYPE ROOMS)
- REMOVE EXISTING 8" CMU CHASE WALL REMOVE EXISTING WALL-MOUNTED SIGNAGE
- REMOVE EXISTING STEEL BEAM (6" TO 10" DEEP) ABOVE CEILING REMOVE EXISTING ENTRY DOOR AND HARDWARE - EXISTING HM FRAME TO REMAIN AND RECEIVE NEW DOOR

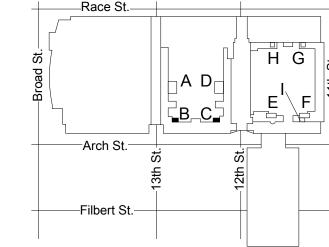

KEY PLAN - LEVEL 100

NTS

Checked by

Project number

Date

Drawn by

As indicated

DEMOLITION &

NEW FLOOR

PLANS - ROOMS

B, C (SEMINAR)

CW1615

LC/KR

ΕW

November 25, 2019

1 HAND DRYER - SEMI-RECESSED 2 PAPER TOWEL DISPENSER - AUTO, SEMI-RECESSED 3 PAPER TOWEL/TRASH COMBO UNIT - AUTO, SEMI-RECESSED

TOLERANCES FOR SPECIFIED NEW TILE FINISH.

— - - — EXISTING 2-HR FIRE RATED WALL (PER AS-BUILT DRAWINGS) TO REMAIN PARTITION TYPE - SEE SHEET A500.1 **DEMOLITION KEY NOTES**

REMOVE EXISTING DOOR THRESHOLD (ALUMINUM THRESHOLD

DRAWING GENERAL NOTES

- 1. JANITOR CLOSET DOORS, HOLLOW METAL FRAMES, AND HARDWARE ARE TO REMAIN AND TO BE REPAINTED AS SCHEDULED. ENTRY DOORS AT SEMINAR- AND BALLROOM-TYPE ROOMS ARE TO BE REPLACED IN KIND IN EXISTING FRAMES. SEE DOOR SCHEDULE ON A600.1 FOR ADDITIONAL INFORMATION.
- 2. JANITOR CLOSETS ARE NOT IN CONTRACT, EXCEPT TO REPAINT INTERIOR AND EXTERIOR OF DOORS AND FRAMES AND TO PROVIDE NEW DOOR THRESHOLDS. 3. CONTRACTOR IS TO VERIFY THE CONDITION OF EXISTING
- SUBSTRATES TO RECEIVE NEW FINISHES AND CONFIRM SUITABILITY. IF EXISTING FLOORS DO NOT MEET MEET ALLOWABLE TOLERANCES PER ANSI STANDARDS FOR LARGE-FORMAT TILE. FLASH FLOORS TO LEVEL. SCRIBE WALL TILE AS NECESSARY TO ACCOMMODATE FLOOR LEVEL WITHIN ALLOWABLE TOLERANCE.
- 4. INFILL AND/OR PATCH FLOORS AND WALLS WHERE TOILET PARTITIONS, ACCESSORIES, OR WALLS REMOVED, AND PROVIDE A SOUND AND LEVEL SURFACE TO RECEIVE NEW FINISH. 5. IN SEMINAR/BALLROOM TYPE ROOMS, EXISTING CERAMIC WALL
- TILE IS TO REMAIN ON WALLS TO REMAIN AND NEW SCHEDULED TILE IS TO BE INSTALLED OVER EXISTING TILE. CONTRACTOR TO VERIFY THAT LEVELNESS OF SURFACE IS WITHIN REQUIRED TOLERANCES FOR SPECIFIED NEW TILE FINISH.

- 6. NOT USED.
- 7. GC TO VERIFY THICKNESS OF CERAMIC TILE ASSEMBLY TO BE REMOVED AND ACCOUNT FOR ANY DIFFERENCE IN THICKNESS OF NEW TILE ASSEMBLY.
- 8. NEW PLUMBING FIXTURE LOCATIONS DIFFER FROM EXISTING FIXTURE LOCATIONS. FIXTURE CARRIERS AND ASSOCIATED PLUMBING ARE TO BE RELOCATED TO DIMENSIONS SHOWN ON DRAWINGS.
- 9. SEE SHEET A500 FOR ENLARGED PLANS AND ELEVATIONS OF TYPICAL TOILET COMPARTMENTS AND TYPICAL ACCESSORY
- MOUNTING HEIGHTS. 10. SEE SHEET A500.1 FOR PARTITION TYPES. NEW WALLS ARE TO BE CONSTRUCTED IN THE IN SAME LOCATION AS EXISTING
- DEMOLISHED WALLS, UNLESS NOTED OTHERWISE.
- 11. SEE A600 SERIES SHEETS FOR REFLECTED CEILING PLANS,
- FINISH PLANS, AND FINISH SCHEDULES. 12. SEE OVERALL BUILDING PLANS ON SHEETS A001, A002, & A003 FOR LOCATIONS OF ALL DRINKING FOUNTAINS IN PROJECT.

NEW CHASE WALLS IN SAME LOCATION AS EXISTING

PLANS AND ELEVATIONS.

PLANS AND ELEVATIONS.

ADA / ICC ANSI A117.1 REQUIRED CLEARANCES

PARTITION TYPE - SEE SHEET A500.1

ACCESSORY/EQUIPMENT LEGEND -SEMINAR-TYPE RESTROOMS

- 1 HAND DRYER SEMI-RECESSED
- 2 PAPER TOWEL DISPENSER AUTO, SEMI-RECESSED
- 3 PAPER TOWEL/TRASH COMBO UNIT AUTO, SEMI-RECESSED
- 4 TRASH SEMI-RECESSED WALL MTD.

WHEELCHAIR ACCESSIBLE TOILET COMPARTMENT - SEE A500 FOR TYPICAL ENLARGED

AMBULATORY ACCESSIBLE TOILET COMPARTMENT - SEE A500 FOR TYPICAL ENLARGED

NO SYMBOL UNLESS OTHERWISE NOTED, TOILET COMPARTMENTS ARE STANDARD.

EXISTING 2-HR FIRE RATED WALL (PER AS-BUILT DRAWINGS) TO REMAIN

- 6 DIAPER CHANGING STATION SURFACE-MTD. (UNLESS OTHERWISE NOTED)
- 8 TOILET PAPER DISPENSER DUAL JUMBO ROLL (TYP. IN EACH STALL)
- 9 SEAT COVER DISPENSER (TYP. IN EACH STALL)
- 11 SANITARY DISPOSAL (TYP. IN EACH WOMEN'S STALL)
- 15 TOILET PARTITIONS 2 COMPACT HIGH-PRESSURE LAMINATE (PHENOLIC), 81" HIGH INCL 9" SUPPORT LEGS; URINAL SCREENS 20" D X 60" H, WALL-MTD. - SEE SPEC FOR COLOR SELECTION
- 18 MIRROR FULL LENGTH 24" X 72"
- 19 MIRROR DOUBLE WIDTH 42" X 54"
- 20 MIRROR SINGLE WIDTH 24" X 54"
- (23) MIRROR SINGLE WIDTH, NARROW 18" X 54"
- 24 MIRROR DOUBLE WIDTH, WIDE 48" X 54"
- 25 MIRROR DOUBLE WIDTH, WIDE 48" X 48"

NOTE: SEE SPECIFICATIONS FOR ADDITIONAL INFORMATION.

DEMOLITION GENERAL NOTES

- 1. SEE PHOTOS ON SOME SHEETS FOR IMAGES OF TYPICAL EXISTING TOILET ROOMS.
- 2. COORDINATE DEMOLITION SCOPE ITEMS WITH NEW

AND SIGNAGE TO BE SALVAGED.

- WORK AND MEP DRAWINGS. 3. COORDINATE WITH OWNER FOR REMOVED ACCESSORIES, PLUMBING FIXTURES, LIGHTING FIXTURES, CEILING DEVICES, TOILET PARTITIONS,
- 4. JANITOR CLOSET DOORS TO REMAIN. PROTECT
- DURING CONSTRUCTION. 5. FOR STEEL BEAMS INDICATED TO BE REMOVED, GC TO VERIFY THAT BEAMS ARE NOT SUPPORTING ANY BUILDING ELEMENT PRIOR TO DEMOLITION. EXERCISE CARE WHEN REMOVING THE BEAMS SO AS NOT TO DAMAGE ANY ADJACENT CONSTRUCTION. BEAMS APPEAR TO HAVE PREVIOUSLY SUPPORTED CEILING-HUNG TOILET PARTITIONS, BUT ARE NO LONGER IN USE.

DEMOLITION KEY NOTES

REMOVE EXISTING 4" CMU CHASE WALL (AT ROOMS T,V, & W, EXISTING WALL IS 4" METAL FRAMING)
REMOVE EXISTING PLUMBING FIXTURE - SEE PLUMBING DWGS
REMOVE EXISTING COUNTERTOP & SUPPORT FRAMING
REMOVE EXISTING TOILET/URINAL PARTITIONS
REMOVE EXISTING WALL-MOUNTED ACCESSORIES
REMOVE EXISTING CERAMIC FLOOR TILE TO CONCRETE SLAB
REMOVE EXISTING GWB CEILING, SUPPORT STRUCTURE, & CEILING-MOUNTED DEVICES THROUGHOUT ROOM - SEE MEP DWGS.
REMOVE EXISTING LIGHT FIXTURES - SEE ELECTRICAL DWGS.
REMOVE EXISTING DOOR THRESHOLD (ALUMINUM THRESHOLD A EXHIBIT-TYPE ROOMS; MARBLE THRESHOLD AT SEMINAR-TYPE ROOMS)

REMOVE EXISTING WALL-MOUNTED SIGNAGE

FRAME TO REMAIN AND RECEIVE NEW DOOR

-Arch St.

REMOVE EXISTING STEEL BEAM (6" TO 10" DEEP) ABOVE CEILING

REMOVE EXISTING ENTRY DOOR AND HARDWARE - EXISTING HM

-Filbert St.-

NTS KEY PLAN - LEVEL 100

PENNSYLVANIA CONVENTION CENTER

DEMOLITION & NEW FLOOR PLANS - ROOM D (SEMINAR)

RESTROOM RENOVATIONS

CONVERSE **WINKLER**

BALA CYNWYD, PA 19144

ARCHITECTURE

ARCHITECTS:

ARCHITECTURE

Ph: 610.664.0806

Fax: 215.664.1075

MEP ENGINEERS:

ARORA°

Contact: Kevin Sultanik

CSA GROUP

Ph: 215.427.8700

Fax: 215.427.8752

Contact: Wing Au

REVISIONS:

Description

SUITE 507

STRUCTURAL ENGINEERS:

PHILADELPHIA, PA 19125

e-mail: wau@csagroup.com

Contact: Elin Westrick

e-mail: ewestrick@cwarc.com

P (610) 459-7900 F (610) 459-7950 aroraengineers.com

e-mail: ksultanik@aroraengineers.com

1341 NORTH DELAWARE AVENUE,

Chadds Ford, PA 19317


CONVERSE WINKLER

331 Montgomery Avenue,

Bala Cynwyd, PA, 19144


CW1615 Project number Date November 25, 2019 LC/KR Drawn by EW Checked by

As indicated

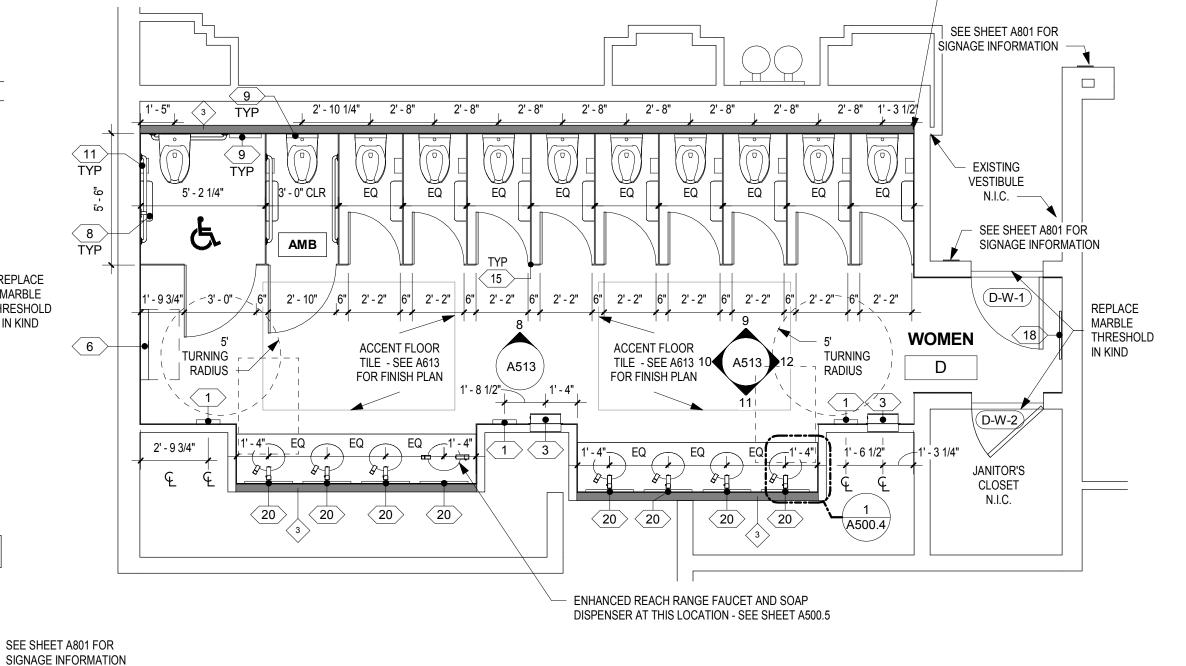


3 FLOOR PLAN - WOMEN'S ROOM D

A113 SCALE: 1/4" = 1'-0"

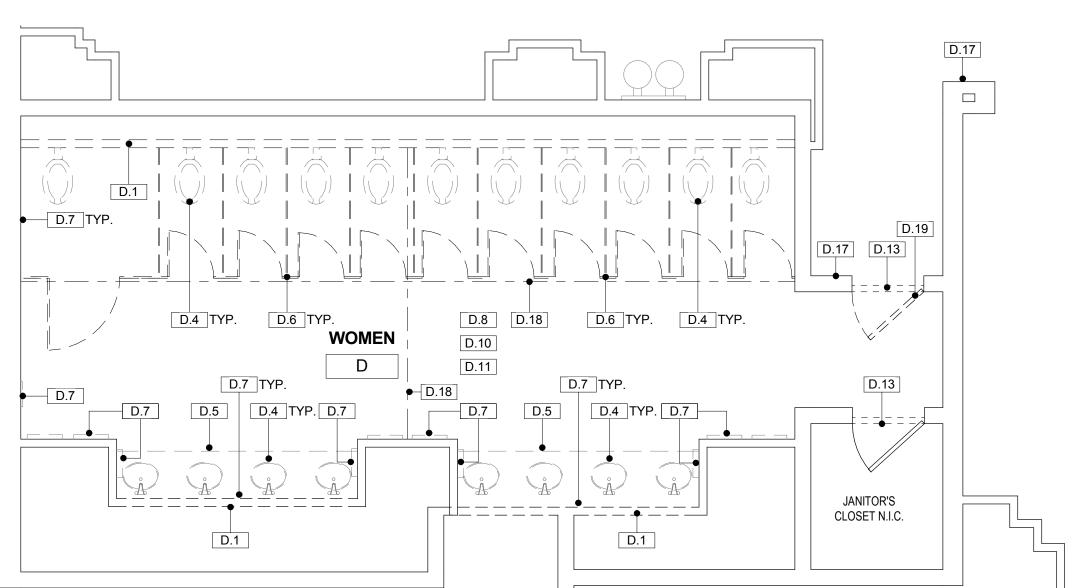

DEMO PLAN - WOMEN'S ROOM D

A113 SCALE: 1/4" = 1'-0"

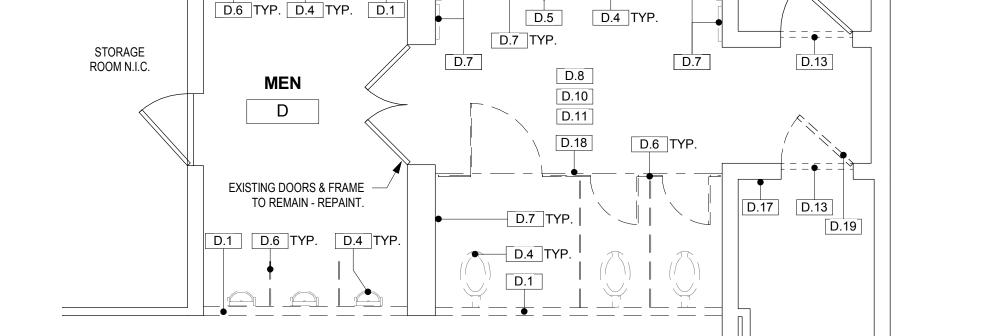

D.1

√A500.4

(20)

ACCENT FLOOR

TILE - SEE A613

FOR FINISH PLAN

A513

3' - 0" 1' - 0" 2' - 10" / 6" 2' - 2"

3' - 0" CLR

9 3'-0" 1'-41/2'

1' - 4 3/4"

(D-M-3)

2' - 1 5/8"

/ | 1' - 5" | 3

JANITOR'S

CLOSET

N.I.C.

5' TURNING

1 / (D-M-2)

(D-M-1

EXISTING `

N.I.C.

VESTIBULE

JANITOR'S CLOSET

D.17

EXISTING FLOOR

CLEANOUT

REPLACE

MARBLE

IN KIND

THRESHOLD

RADIUS

DEMO PLAN - MEN'S ROOM D

1' - 4 3/4" 2' - 10"

15 TYP

2' - 10" 1' - 4 3/4"

SEE SHEET A500 FOR GRAB BAR

DIMENSIONS & LOCATIONS, TYP.

4 FLOOR PLAN - MEN'S ROOM D

A513

- - - - -

1' - 3" MIN. TYP—

(D-M-4

A113 SCALE: 1/4" = 1'-0"


NEW CHASE WALLS -

IN SAME LOCATION


STORAGE ROOM

AS EXISTING

A113 SCALE: 1/4" = 1'-0"

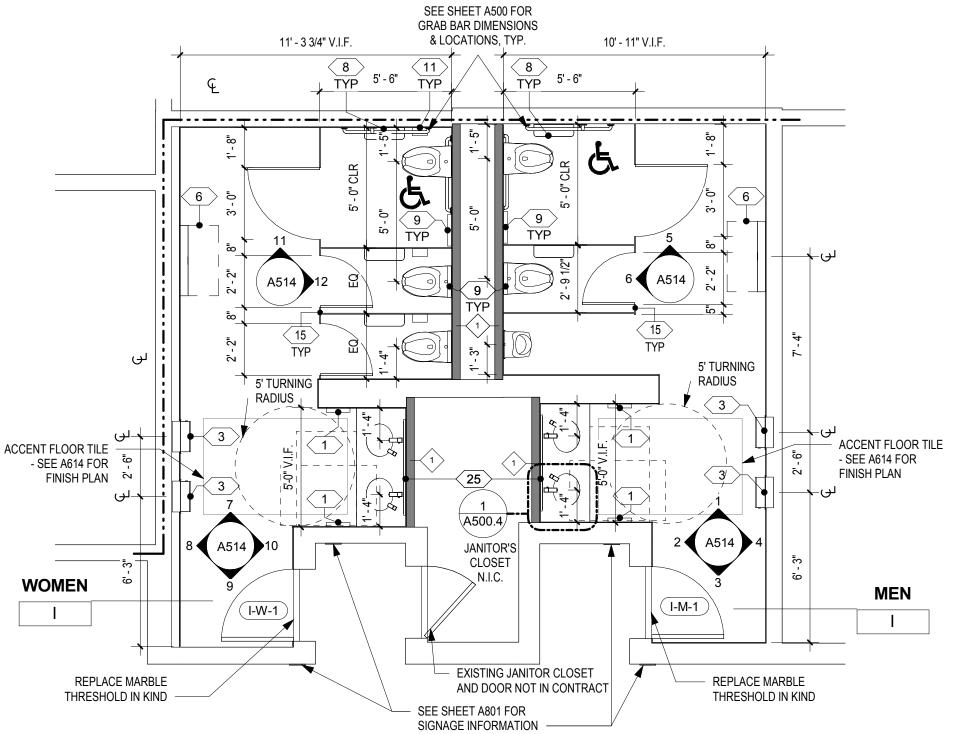

7 FLOOR PLAN - MEN'S & WOMEN'S ROOM I A114 SCALE: 1/4" = 1'-0"

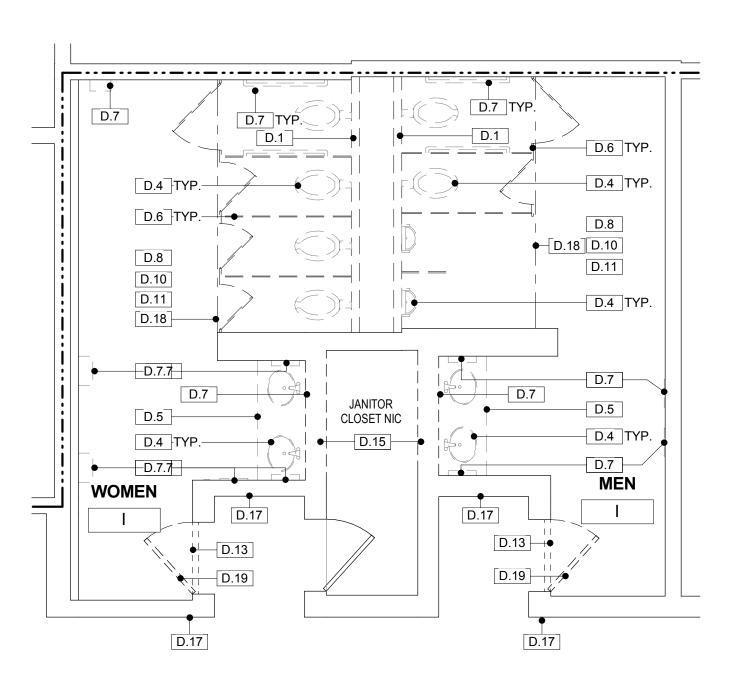

DEMO PLAN - MEN'S & WOMEN'S ROOM I A114 SCALE: 1/4" = 1'-0"

DRAWING GENERAL NOTES

- 1. JANITOR CLOSET DOORS, HOLLOW METAL FRAMES, AND HARDWARE ARE TO REMAIN AND TO BE REPAINTED AS SCHEDULED. ENTRY DOORS AT SEMINAR- AND BALLROOM-TYPE ROOMS ARE TO BE REPLACED IN KIND IN EXISTING FRAMES. SEE DOOR SCHEDULE ON A600.1 FOR ADDITIONAL INFORMATION.
- 2. JANITOR CLOSETS ARE NOT IN CONTRACT, EXCEPT TO REPAINT INTERIOR AND EXTERIOR OF DOORS AND FRAMES AND TO PROVIDE NEW DOOR THRESHOLDS.
- 3. CONTRACTOR IS TO VERIFY THE CONDITION OF EXISTING SUBSTRATES TO RECEIVE NEW FINISHES AND CONFIRM SUITABILITY. IF EXISTING FLOORS DO NOT MEET MEET ALLOWABLE TOLERANCES PER ANSI STANDARDS FOR LARGE-FORMAT TILE, FLASH FLOORS TO LEVEL. SCRIBE WALL TILE AS NECESSARY TO ACCOMMODATE FLOOR LEVEL WITHIN ALLOWABLE TOLERANCE.
- 4. INFILL AND/OR PATCH FLOORS AND WALLS WHERE TOILET PARTITIONS, ACCESSORIES, OR WALLS REMOVED, AND PROVIDE A SOUND AND LEVEL SURFACE TO RECEIVE NEW FINISH.
- 5. IN SEMINAR/BALLROOM TYPE ROOMS, EXISTING CERAMIC WALL TILE IS TO REMAIN ON WALLS TO REMAIN AND NEW SCHEDULED TILE IS TO BE INSTALLED OVER EXISTING TILE. CONTRACTOR TO VERIFY THAT LEVELNESS OF SURFACE IS WITHIN REQUIRED TOLERANCES FOR SPECIFIED NEW TILE FINISH.

- NOT USED.
- 7. GC TO VERIFY THICKNESS OF CERAMIC TILE ASSEMBLY TO BE REMOVED AND ACCOUNT FOR ANY DIFFERENCE IN THICKNESS OF NEW TILE ASSEMBLY.
- 8. NEW PLUMBING FIXTURE LOCATIONS DIFFER FROM EXISTING FIXTURE LOCATIONS. FIXTURE CARRIERS AND ASSOCIATED PLUMBING ARE TO BE RELOCATED TO DIMENSIONS SHOWN ON
- DRAWINGS. 9. SEE SHEET A500 FOR ENLARGED PLANS AND ELEVATIONS OF TYPICAL TOILET COMPARTMENTS AND TYPICAL ACCESSORY
- MOUNTING HEIGHTS. 10. SEE SHEET A500.1 FOR PARTITION TYPES. NEW WALLS ARE TO BE CONSTRUCTED IN THE IN SAME LOCATION AS EXISTING
- DEMOLISHED WALLS, UNLESS NOTED OTHERWISE. 11. SEE A600 SERIES SHEETS FOR REFLECTED CEILING PLANS, FINISH PLANS, AND FINISH SCHEDULES.
- 12. SEE OVERALL BUILDING PLANS ON SHEETS A001, A002, & A003 FOR LOCATIONS OF ALL DRINKING FOUNTAINS IN PROJECT.

ACCESSORY/EQUIPMENT LEGEND - SEMINAR-TYPE RESTROOMS

- 1 HAND DRYER SEMI-RECESSED
- 2 PAPER TOWEL DISPENSER AUTO, SEMI-RECESSED

OTHERWISE NOTED)

- 4 > TRASH SEMI-RECESSED WALL MTD. 6 DIAPER CHANGING STATION - SURFACE-MTD. (UNLESS
- 8 TOILET PAPER DISPENSER DUAL JUMBO ROLL (TYP. IN EACH STALL)
- 9 SEAT COVER DISPENSER (TYP. IN EACH STALL)
- (11) SANITARY DISPOSAL (TYP. IN EACH WOMEN'S STALL)
- (15) TOILET PARTITIONS 2 COMPACT HIGH-PRESSURE LAMINATE (PHENOLIC), 81" HIGH INCL 9" SUPPORT LEGS; URINAL SCREENS 20" D X 60" H, WALL-MTD.
- 3 PAPER TOWEL/TRASH COMBO UNIT AUTO, SEMI-RECESSED (18) MIRROR FULL LENGTH 24" X 72"
 - 19 MIRROR DOUBLE WIDTH 42" X 54"
 - 20 MIRROR SINGLE WIDTH 24" X 54"
 - 23 MIRROR SINGLE WIDTH, NARROW 18" X 54"
 - MIRROR DOUBLE WIDTH, WIDE 48" X 54" 25 MIRROR - DOUBLE WIDTH, WIDE - 48" X 48"

NOTE: SEE SPECIFICATIONS FOR ADDITIONAL INFORMATION.



WHEELCHAIR ACCESSIBLE TOILET COMPARTMENT - SEE A500 FOR TYPICAL ENLARGED PLANS AND ELEVATIONS.

AMBULATORY ACCESSIBLE TOILET COMPARTMENT - SEE A500 FOR TYPICAL ENLARGED PLANS AND ELEVATIONS.

NO SYMBOL UNLESS OTHERWISE NOTED, TOILET COMPARTMENTS ARE STANDARD.


ADA / ICC ANSI A117.1 REQUIRED CLEARANCES EXISTING 2-HR FIRE RATED WALL (PER AS-BUILT DRAWINGS) TO REMAIN

PARTITION TYPE - SEE SHEET A500.1

DEMOLITION GENERAL NOTES

- 1. SEE PHOTOS ON SOME SHEETS FOR IMAGES OF
- WORK AND MEP DRAWINGS. ACCESSORIES, PLUMBING FIXTURES, LIGHTING
- 4. JANITOR CLOSET DOORS TO REMAIN. PROTECT
- 5. FOR STEEL BEAMS INDICATED TO BE REMOVED, GC TO VERIFY THAT BEAMS ARE NOT SUPPORTING ANY BUILDING ELEMENT PRIOR TO DEMOLITION. EXERCISE CARE WHEN REMOVING THE BEAMS SO AS NOT TO DAMAGE ANY ADJACENT CONSTRUCTION. BEAMS APPEAR TO HAVE PREVIOUSLY SUPPORTED CEILING-HUNG TOILET

DEMOLITION KEY NOTES		
REMOVE EXISTING 4" CMU CHASE WALL (AT ROOMS T,V, & W, EXISTING WALL IS 4" METAL FRAMING)		
REMOVE EXISTING PLUMBING FIXTURE - SEE PLUMBING DWGS		
REMOVE EXISTING COUNTERTOP & SUPPORT FRAMING		
REMOVE EXISTING TOILET/URINAL PARTITIONS		
REMOVE EXISTING WALL-MOUNTED ACCESSORIES		
REMOVE EXISTING CERAMIC FLOOR TILE TO CONCRETE SLAB		
REMOVE EXISTING GWB CEILING, SUPPORT STRUCTURE, & CEILING-MOUNTED DEVICES THROUGHOUT ROOM - SEE MEP DWGS.		
REMOVE EXISTING LIGHT FIXTURES - SEE ELECTRICAL DWGS.		
REMOVE EXISTING DOOR THRESHOLD (ALUMINUM THRESHOLD A' EXHIBIT-TYPE ROOMS; MARBLE THRESHOLD AT SEMINAR-TYPE		

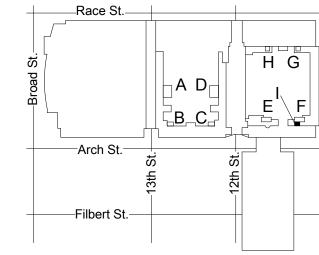

NTS Checked by

Drawn by

PLANS - ROOM I (SEMINAR) CW1615 Project number November 25, 2019 Date

DEMOLITION &

NEW FLOOR

CONVERSE WINKLER ARCHITECTURE

331 MONTGOMERY AVE BALA CYNWYD, PA 19144

ARCHITECTS:

ARCHITECTURE

Ph: 610.664.0806

Fax: 215.664.1075

MEP ENGINEERS:

Contact: Kevin Sultanik

CSA GROUP

Ph: 215.427.8700

Fax: 215.427.8752

Contact: Wing Au

REVISIONS:

PENNSYLVANIA NVENTION CENTER

CO

RESTROOM RENOVATIONS

Description

SUITE 507

STRUCTURAL ENGINEERS:

PHILADELPHIA, PA 19125

e-mail: wau@csagroup.com

Contact: Elin Westrick

e-mail: ewestrick@cwarc.com

P (610) 459-7900 F (610) 459-7950 aroraengineers.com

e-mail: ksultanik@aroraengineers.com

1341 NORTH DELAWARE AVENUE,

Arora Engineers, Inc.

Chadds Ford, PA 19317

CONVERSE WINKLER

331 Montgomery Avenue,

Bala Cynwyd, PA, 19144

As indicated

LC/KR

EW



TYPICAL EXISTING TOILET ROOMS. 2. COORDINATE DEMOLITION SCOPE ITEMS WITH NEW

3. COORDINATE WITH OWNER FOR REMOVED FIXTURES, CEILING DEVICES, TOILET PARTITIONS, AND SIGNAGE TO BE SALVAGED.

DURING CONSTRUCTION.

PARTITIONS. BUT ARE NO LONGER IN USE.

ROOMS)

D.1	REMOVE EXISTING 4" CMU CHASE WALL (AT ROOMS T,V, & W, EXISTING WALL IS 4" METAL FRAMING)
D.4	REMOVE EXISTING PLUMBING FIXTURE - SEE PLUMBING DWG
D.5	REMOVE EXISTING COUNTERTOP & SUPPORT FRAMING
D.6	REMOVE EXISTING TOILET/URINAL PARTITIONS
D.7	REMOVE EXISTING WALL-MOUNTED ACCESSORIES
D.8	REMOVE EXISTING CERAMIC FLOOR TILE TO CONCRETE SLAB
D.10	REMOVE EXISTING GWB CEILING, SUPPORT STRUCTURE, & CEILING-MOUNTED DEVICES THROUGHOUT ROOM - SEE MEP DWGS.
D.11	REMOVE EXISTING LIGHT FIXTURES - SEE ELECTRICAL DWGS

REMOVE EXISTING 8" CMU CHASE WALL

REMOVE EXISTING WALL-MOUNTED SIGNAGE


FRAME TO REMAIN AND RECEIVE NEW DOOR


REMOVE EXISTING STEEL BEAM (6" TO 10" DEEP) ABOVE CEILING

REMOVE EXISTING ENTRY DOOR AND HARDWARE - EXISTING HM


KEY PLAN - LEVEL 100

A115 SCALE: 1/4" = 1'-0"

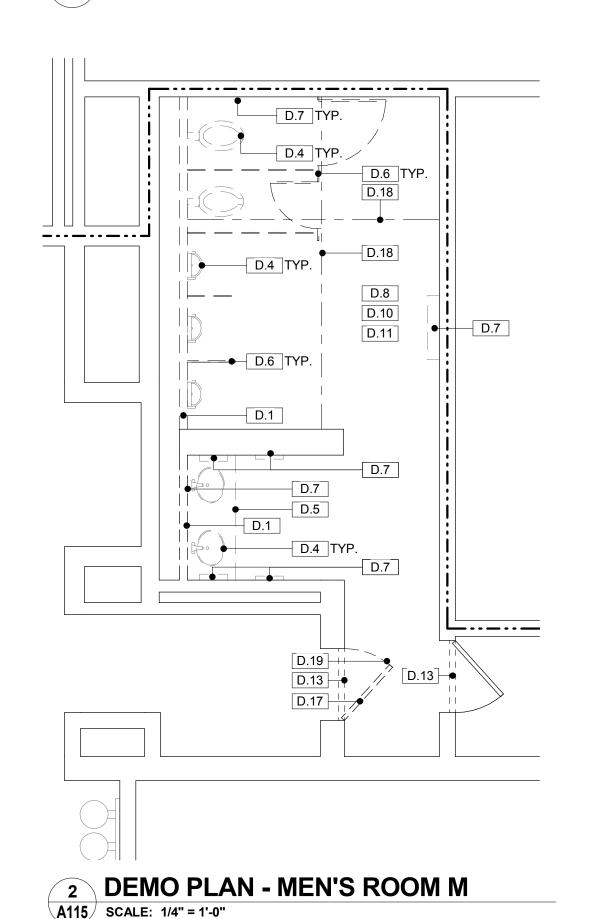

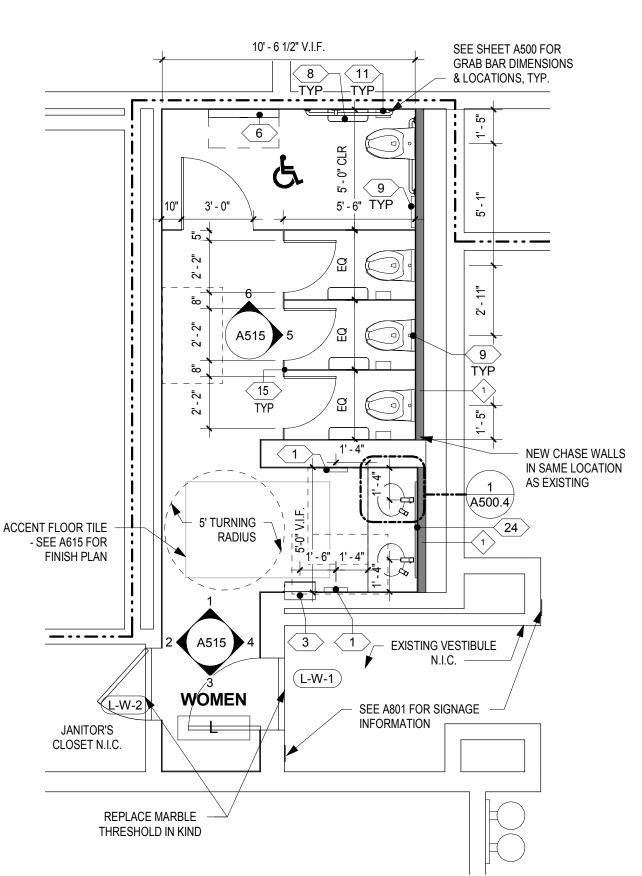

3 FLOOR PLAN - WOMEN'S ROOM L A115 SCALE: 1/4'' = 1'-0''

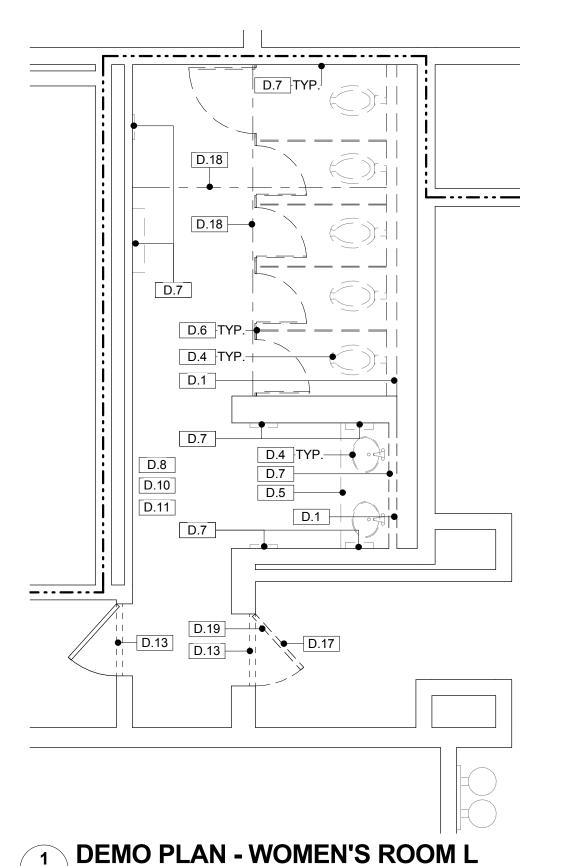

A115 SCALE: 1/4" = 1'-0"

DRAWING GENERAL NOTES

1. JANITOR CLOSET DOORS, HOLLOW METAL FRAMES, AND HARDWARE ARE TO REMAIN AND TO BE REPAINTED AS SCHEDULED. ENTRY DOORS AT SEMINAR- AND BALLROOM-TYPE ROOMS ARE TO BE REPLACED IN KIND IN EXISTING FRAMES. SEE DOOR SCHEDULE ON A600.1 FOR ADDITIONAL INFORMATION. 2. JANITOR CLOSETS ARE NOT IN CONTRACT, EXCEPT TO REPAINT

INTERIOR AND EXTERIOR OF DOORS AND FRAMES AND TO PROVIDE NEW DOOR THRESHOLDS. 3. CONTRACTOR IS TO VERIFY THE CONDITION OF EXISTING

SUBSTRATES TO RECEIVE NEW FINISHES AND CONFIRM SUITABILITY. IF EXISTING FLOORS DO NOT MEET MEET ALLOWABLE TOLERANCES PER ANSI STANDARDS FOR LARGE-FORMAT TILE, FLASH FLOORS TO LEVEL. SCRIBE WALL TILE AS NECESSARY TO ACCOMMODATE FLOOR LEVEL WITHIN ALLOWABLE TOLERANCE.

4. INFILL AND/OR PATCH FLOORS AND WALLS WHERE TOILET PARTITIONS, ACCESSORIES, OR WALLS REMOVED, AND PROVIDE

A SOUND AND LEVEL SURFACE TO RECEIVE NEW FINISH. 5. IN SEMINAR/BALLROOM TYPE ROOMS, EXISTING CERAMIC WALL TILE IS TO REMAIN ON WALLS TO REMAIN AND NEW SCHEDULED TILE IS TO BE INSTALLED OVER EXISTING TILE. CONTRACTOR TO VERIFY THAT LEVELNESS OF SURFACE IS WITHIN REQUIRED TOLERANCES FOR SPECIFIED NEW TILE FINISH.

- NOT USED. 7. GC TO VERIFY THICKNESS OF CERAMIC TILE ASSEMBLY TO BE REMOVED AND ACCOUNT FOR ANY DIFFERENCE IN THICKNESS OF NEW TILE ASSEMBLY.
 - 8. NEW PLUMBING FIXTURE LOCATIONS DIFFER FROM EXISTING FIXTURE LOCATIONS. FIXTURE CARRIERS AND ASSOCIATED PLUMBING ARE TO BE RELOCATED TO DIMENSIONS SHOWN ON
 - DRAWINGS 9. SEE SHEET A500 FOR ENLARGED PLANS AND ELEVATIONS OF
 - 12. SEE OVERALL BUILDING PLANS ON SHEETS A001, A002, & A003 FOR LOCATIONS OF ALL DRINKING FOUNTAINS IN PROJECT.

ACCESSORY/EQUIPMENT LEGEND - SEMINAR-TYPE RESTROOMS

- 1 HAND DRYER SEMI-RECESSED
- 2 PAPER TOWEL DISPENSER AUTO, SEMI-RECESSED
- 3 PAPER TOWEL/TRASH COMBO UNIT AUTO, SEMI-RECESSED 18 MIRROR FULL LENGTH 24" X 72"
- \langle 4 \rangle TRASH SEMI-RECESSED WALL MTD.
- 6 DIAPER CHANGING STATION SURFACE-MTD. (UNLESS OTHERWISE NOTED)
- 8 TOILET PAPER DISPENSER DUAL JUMBO ROLL (TYP. IN EACH STALL)
- 9 SEAT COVER DISPENSER (TYP. IN EACH STALL) <11> SANITARY DISPOSAL (TYP. IN EACH WOMEN'S STALL)
- 15 TOILET PARTITIONS 2 COMPACT HIGH-PRESSURE LAMINATE (PHENOLIC), 81" HIGH INCL 9" SUPPORT LEGS; URINAL SCREENS 20" D X 60" H, WALL-MTD.
- 19 MIRROR DOUBLE WIDTH 42" X 54"
- 20 MIRROR SINGLE WIDTH 24" X 54"
- 23 MIRROR SINGLE WIDTH, NARROW 18" X 54"
- 24 MIRROR DOUBLE WIDTH, WIDE 48" X 54"
- 25 MIRROR DOUBLE WIDTH, WIDE 48" X 48"

NOTE: SEE SPECIFICATIONS FOR ADDITIONAL INFORMATION.



WHEELCHAIR ACCESSIBLE TOILET COMPARTMENT - SEE A500 FOR TYPICAL ENLARGED PLANS AND ELEVATIONS.

AMBULATORY ACCESSIBLE TOILET COMPARTMENT - SEE A500 FOR TYPICAL ENLARGED PLANS AND ELEVATIONS.

NO SYMBOL UNLESS OTHERWISE NOTED, TOILET COMPARTMENTS ARE STANDARD. ADA / ICC ANSI A117.1 REQUIRED CLEARANCES

EXISTING 2-HR FIRE RATED WALL (PER AS-BUILT DRAWINGS) TO REMAIN

PARTITION TYPE - SEE SHEET A500.1

DEMOLITION GENERAL NOTES


- 1. SEE PHOTOS ON SOME SHEETS FOR IMAGES OF TYPICAL EXISTING TOILET ROOMS.
- 2. COORDINATE DEMOLITION SCOPE ITEMS WITH NEW WORK AND MEP DRAWINGS.
- 3. COORDINATE WITH OWNER FOR REMOVED ACCESSORIES, PLUMBING FIXTURES, LIGHTING FIXTURES, CEILING DEVICES, TOILET PARTITIONS, AND SIGNAGE TO BE SALVAGED.
- 4. JANITOR CLOSET DOORS TO REMAIN. PROTECT DURING CONSTRUCTION.
- 5. FOR STEEL BEAMS INDICATED TO BE REMOVED, GC TO VERIFY THAT BEAMS ARE NOT SUPPORTING ANY BUILDING ELEMENT PRIOR TO DEMOLITION. EXERCISE CARE WHEN REMOVING THE BEAMS SO AS NOT TO DAMAGE ANY ADJACENT CONSTRUCTION. BEAMS APPEAR TO HAVE PREVIOUSLY SUPPORTED CEILING-HUNG TOILET PARTITIONS, BUT ARE NO LONGER IN USE.

D.1	REMOVE EXISTING 4" CMU CHASE WALL (AT ROOMS T,V, & W, EXISTING WALL IS 4" METAL FRAMING)
D.4	REMOVE EXISTING PLUMBING FIXTURE - SEE PLUMBING DWGS
D.5	REMOVE EXISTING COUNTERTOP & SUPPORT FRAMING
D.6	REMOVE EXISTING TOILET/URINAL PARTITIONS
D.7	REMOVE EXISTING WALL-MOUNTED ACCESSORIES
D.8	REMOVE EXISTING CERAMIC FLOOR TILE TO CONCRETE SLAB
D.10	REMOVE EXISTING GWB CEILING, SUPPORT STRUCTURE, & CEILING-MOUNTED DEVICES THROUGHOUT ROOM - SEE MEP DWGS.
D.11	REMOVE EXISTING LIGHT FIXTURES - SEE ELECTRICAL DWGS.
D.13	REMOVE EXISTING DOOR THRESHOLD (ALUMINUM THRESHOLD AT EXHIBIT-TYPE ROOMS; MARBLE THRESHOLD AT SEMINAR-TYPE ROOMS)
D.17	REMOVE EXISTING WALL-MOUNTED SIGNAGE
D.18	REMOVE EXISTING STEEL BEAM (6" TO 10" DEEP) ABOVE CEILING


REMOVE EXISTING ENTRY DOOR AND HARDWARE - EXISTING HM

FRAME TO REMAIN AND RECEIVE NEW DOOR

DEMOLITION KEY NOTES

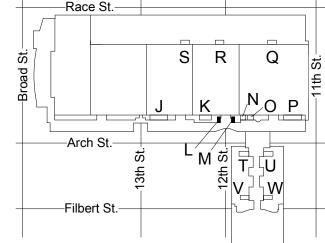

KEY PLAN - LEVEL 200

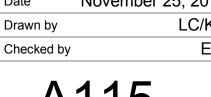

TYPICAL TOILET COMPARTMENTS AND TYPICAL ACCESSORY Contact: Elin Westrick MOUNTING HEIGHTS. e-mail: ewestrick@cwarc.com 10. SEE SHEET A500.1 FOR PARTITION TYPES. NEW WALLS ARE TO BE CONSTRUCTED IN THE IN SAME LOCATION AS EXISTING DEMOLISHED WALLS, UNLESS NOTED OTHERWISE. **MEP ENGINEERS:** 11. SEE A600 SERIES SHEETS FOR REFLECTED CEILING PLANS, FINISH PLANS, AND FINISH SCHEDULES. **ARORA**

Chadds Ford, PA 19317 P (610) 459-7900 | F (610) 459-7950 | aroraengineers.com

Contact: Kevin Sultanik e-mail: ksultanik@aroraengineers.com

CONVERSE **WINKLER** ARCHITECTURE 331 MONTGOMERY AVE BALA CYNWYD, PA 19144

ARCHITECTS:

ARCHITECTURE

Ph: 610.664.0806

Fax: 215.664.1075

CONVERSE WINKLER

331 Montgomery Avenue,

Bala Cynwyd, PA, 19144

STRUCTURAL ENGINEERS:

CSA GROUP 1341 NORTH DELAWARE AVENUE, SUITE 507 PHILADELPHIA, PA 19125

Ph: 215.427.8700 Fax: 215.427.8752

Contact: Wing Au

e-mail: wau@csagroup.com




REVISIONS: Description

/ANIA CENTER PENNSYLV NVENTION

DEMOLITION & NEW FLOOR PLANS - ROOMS L, M (SEMINAR)


CO

CW1615 Project number November 25, 2019 LC/KR EW

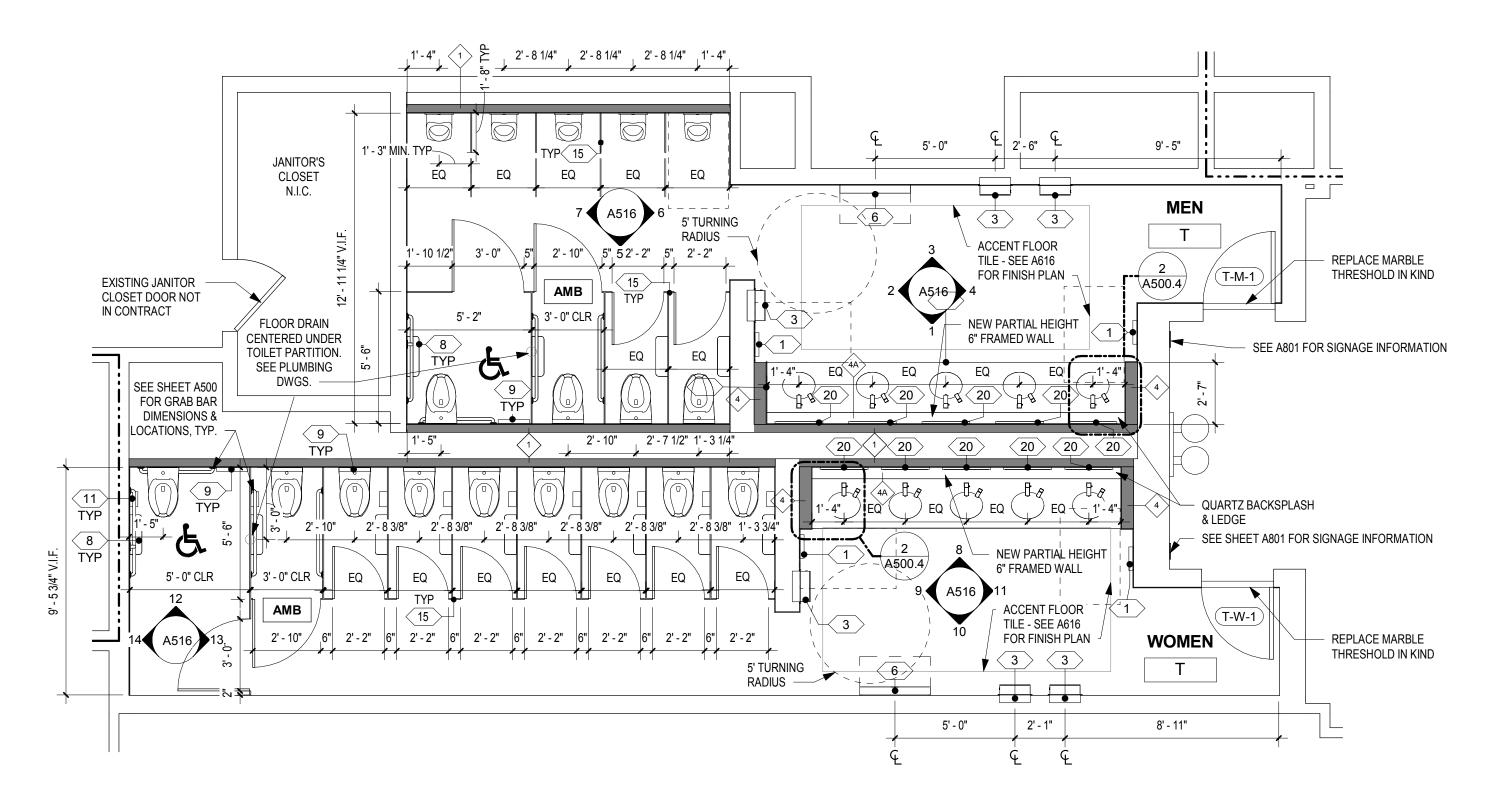

7 FLOOR PLAN - MEN'S & WOMEN'S ROOM T

A116 | SCALE: 1/4" = 1'-0"

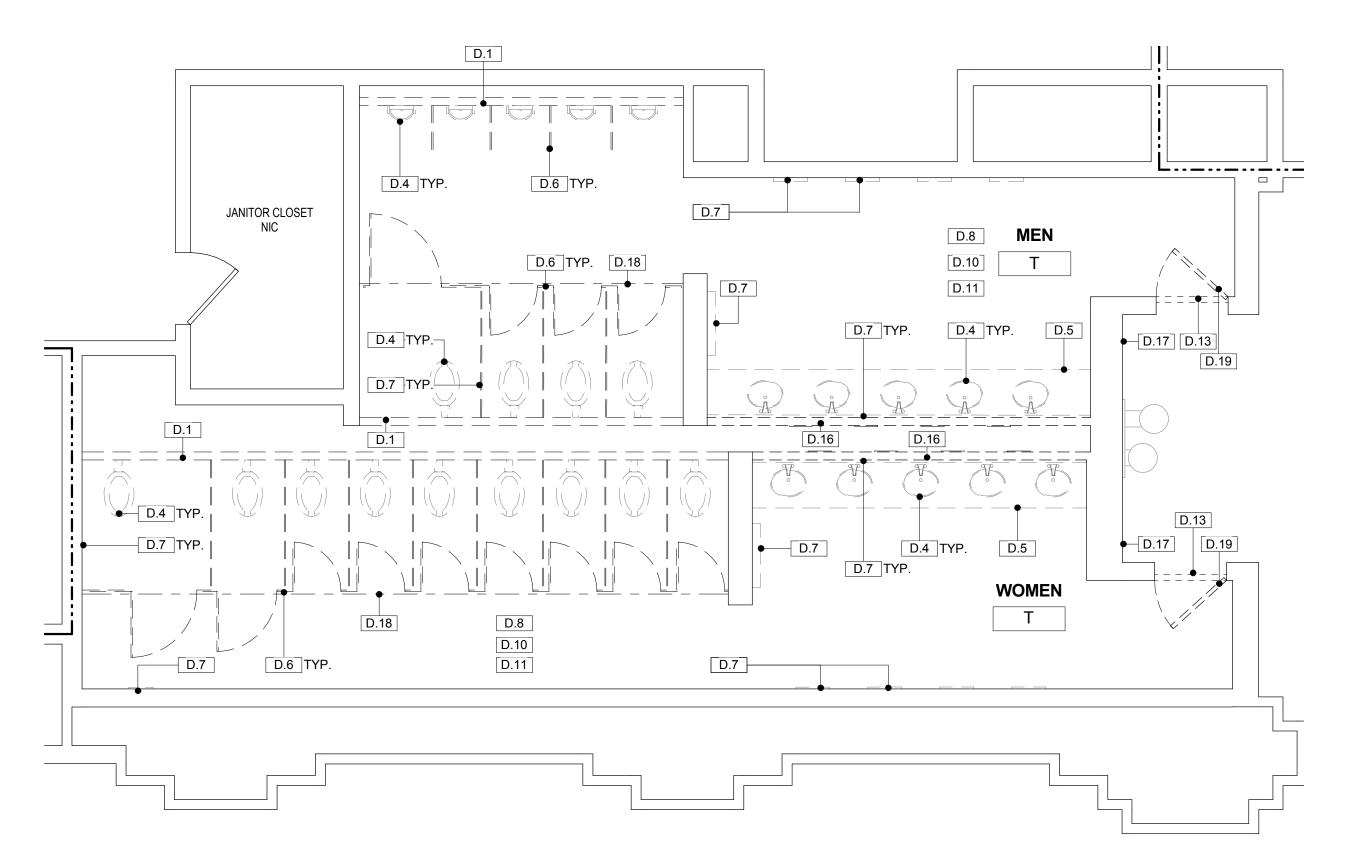

DRAWING GENERAL NOTES

- 1. JANITOR CLOSET DOORS, HOLLOW METAL FRAMES, AND HARDWARE ARE TO REMAIN AND TO BE REPAINTED AS SCHEDULED. ENTRY DOORS AT SEMINAR- AND BALLROOM-TYPE ROOMS ARE TO BE REPLACED IN KIND IN EXISTING FRAMES. SEE
- DOOR SCHEDULE ON A600.1 FOR ADDITIONAL INFORMATION. 2. JANITOR CLOSETS ARE NOT IN CONTRACT, EXCEPT TO REPAINT INTERIOR AND EXTERIOR OF DOORS AND FRAMES AND TO PROVIDE NEW DOOR THRESHOLDS.
- 3. CONTRACTOR IS TO VERIFY THE CONDITION OF EXISTING SUBSTRATES TO RECEIVE NEW FINISHES AND CONFIRM SUITABILITY. IF EXISTING FLOORS DO NOT MEET MEET ALLOWABLE TOLERANCES PER ANSI STANDARDS FOR LARGE-FORMAT TILE, FLASH FLOORS TO LEVEL. SCRIBE WALL TILE AS NECESSARY TO ACCOMMODATE FLOOR LEVEL WITHIN ALLOWABLE TOLERANCE.
- 4. INFILL AND/OR PATCH FLOORS AND WALLS WHERE TOILET PARTITIONS, ACCESSORIES, OR WALLS REMOVED, AND PROVIDE A SOUND AND LEVEL SURFACE TO RECEIVE NEW FINISH. 5. IN SEMINAR/BALLROOM TYPE ROOMS, EXISTING CERAMIC WALL
- TILE IS TO REMAIN ON WALLS TO REMAIN AND NEW SCHEDULED TILE IS TO BE INSTALLED OVER EXISTING TILE. CONTRACTOR TO VERIFY THAT LEVELNESS OF SURFACE IS WITHIN REQUIRED TOLERANCES FOR SPECIFIED NEW TILE FINISH.

- 6. NOT USED. 7. GC TO VERIFY THICKNESS OF CERAMIC TILE ASSEMBLY TO BE REMOVED AND ACCOUNT FOR ANY DIFFERENCE IN THICKNESS

CONVERSE **WINKLER**

ARCHITECTURE 331 MONTGOMERY AVE BALA CYNWYD, PA 19144

ARCHITECTS:

ARCHITECTURE

Ph: 610.664.0806

Fax: 215.664.1075

MEP ENGINEERS:

ARORA°

Contact: Kevin Sultanik

CSA GROUP

Ph: 215.427.8700 Fax: 215.427.8752

Contact: Wing Au

REVISIONS:

PENNSYLVANIA CONVENTION CENTER

RESTROOM RENOVATIONS

Description

SUITE 507

STRUCTURAL ENGINEERS:

PHILADELPHIA, PA 19125

e-mail: wau@csagroup.com

Contact: Elin Westrick

e-mail: ewestrick@cwarc.com

P (610) 459-7900 | F (610) 459-7950 | aroraengineers.com

e-mail: ksultanik@aroraengineers.com

1341 NORTH DELAWARE AVENUE,

Arora Engineers, Inc.

Chadds Ford, PA 19317

CONVERSE WINKLER

331 Montgomery Avenue,

Bala Cynwyd, PA, 19144

- OF NEW TILE ASSEMBLY. 8. NEW PLUMBING FIXTURE LOCATIONS DIFFER FROM EXISTING FIXTURE LOCATIONS. FIXTURE CARRIERS AND ASSOCIATED PLUMBING ARE TO BE RELOCATED TO DIMENSIONS SHOWN ON
- DRAWINGS. 9. SEE SHEET A500 FOR ENLARGED PLANS AND ELEVATIONS OF TYPICAL TOILET COMPARTMENTS AND TYPICAL ACCESSORY
- MOUNTING HEIGHTS. 10. SEE SHEET A500.1 FOR PARTITION TYPES. NEW WALLS ARE TO BE CONSTRUCTED IN THE IN SAME LOCATION AS EXISTING
- DEMOLISHED WALLS, UNLESS NOTED OTHERWISE. 11. SEE A600 SERIES SHEETS FOR REFLECTED CEILING PLANS,
- FINISH PLANS, AND FINISH SCHEDULES. 12. SEE OVERALL BUILDING PLANS ON SHEETS A001, A002, & A003 FOR LOCATIONS OF ALL DRINKING FOUNTAINS IN PROJECT.

ACCESSORY/EQUIPMENT LEGEND - SEMINAR-TYPE RESTROOMS

1 HAND DRYER - SEMI-RECESSED

2 PAPER TOWEL DISPENSER - AUTO, SEMI-RECESSED

3 PAPER TOWEL/TRASH COMBO UNIT - AUTO, SEMI-RECESSED 4 TRASH - SEMI-RECESSED WALL MTD.

6 DIAPER CHANGING STATION - SURFACE-MTD. (UNLESS OTHERWISE NOTED)

EACH STALL) 9 SEAT COVER DISPENSER (TYP. IN EACH STALL)

\$\langle 11 \rangle SANITARY DISPOSAL (TYP. IN EACH WOMEN'S STALL)

8 TOILET PAPER DISPENSER - DUAL JUMBO ROLL (TYP. IN

(15) TOILET PARTITIONS 2 - COMPACT HIGH-PRESSURE LAMINATE (PHENOLIC), 81" HIGH INCL 9" SUPPORT LEGS; URINAL SCREENS 20" D X 60" H, WALL-MTD.

- 18 MIRROR FULL LENGTH 24" X 72" (19) MIRROR - DOUBLE WIDTH - 42" X 54"
- (20) MIRROR SINGLE WIDTH 24" X 54"
- 23 MIRROR SINGLE WIDTH, NARROW 18" X 54"
- $\langle 24 \rangle$ MIRROR DOUBLE WIDTH, WIDE 48" X 54"
- 25 MIRROR DOUBLE WIDTH, WIDE 48" X 48"

NOTE: SEE SPECIFICATIONS FOR ADDITIONAL INFORMATION.



WHEELCHAIR ACCESSIBLE TOILET COMPARTMENT - SEE A500 FOR TYPICAL ENLARGED PLANS AND ELEVATIONS.

AMBULATORY ACCESSIBLE TOILET COMPARTMENT - SEE A500 FOR TYPICAL ENLARGED PLANS AND ELEVATIONS.

NO SYMBOL UNLESS OTHERWISE NOTED, TOILET COMPARTMENTS ARE STANDARD. ADA / ICC ANSI A117.1 REQUIRED CLEARANCES

— - - — EXISTING 2-HR FIRE RATED WALL (PER AS-BUILT DRAWINGS) TO REMAIN


PARTITION TYPE - SEE SHEET A500.1

DEMOLITION GENERAL NOTES

- 1. SEE PHOTOS ON SOME SHEETS FOR IMAGES OF TYPICAL EXISTING TOILET ROOMS.
- 2. COORDINATE DEMOLITION SCOPE ITEMS WITH NEW WORK AND MEP DRAWINGS.
- 3. COORDINATE WITH OWNER FOR REMOVED ACCESSORIES, PLUMBING FIXTURES, LIGHTING FIXTURES, CEILING DEVICES, TOILET PARTITIONS,
- AND SIGNAGE TO BE SALVAGED. 4. JANITOR CLOSET DOORS TO REMAIN. PROTECT
- DURING CONSTRUCTION. 5. FOR STEEL BEAMS INDICATED TO BE REMOVED, GC TO VERIFY THAT BEAMS ARE NOT SUPPORTING ANY BUILDING ELEMENT PRIOR TO DEMOLITION. EXERCISE CARE WHEN REMOVING THE BEAMS SO AS NOT TO DAMAGE ANY ADJACENT CONSTRUCTION. BEAMS APPEAR TO HAVE PREVIOUSLY SUPPORTED CEILING-HUNG TOILET PARTITIONS, BUT ARE NO LONGER IN USE.

DEMOLITION KEY NOTES

REMOVE EXISTING 4" CMU CHASE WALL (AT ROOMS T,V, & W, EXISTING WALL IS 4" METAL FRAMING)
REMOVE EXISTING PLUMBING FIXTURE - SEE PLUMBING DWGS
REMOVE EXISTING COUNTERTOP & SUPPORT FRAMING
REMOVE EXISTING TOILET/URINAL PARTITIONS
REMOVE EXISTING WALL-MOUNTED ACCESSORIES
REMOVE EXISTING CERAMIC FLOOR TILE TO CONCRETE SLAB
REMOVE EXISTING GWB CEILING, SUPPORT STRUCTURE, & CEILING-MOUNTED DEVICES THROUGHOUT ROOM - SEE MEP DWGS.
REMOVE EXISTING LIGHT FIXTURES - SEE ELECTRICAL DWGS.
REMOVE EXISTING DOOR THRESHOLD (ALUMINUM THRESHOLD AT EXHIBIT-TYPE ROOMS; MARBLE THRESHOLD AT SEMINAR-TYPE ROOMS)
REMOVE EXISTING CHASE WALL - 4 COURSES 8" CMU & METAL FRAMING ABOVE
REMOVE EXISTING WALL-MOUNTED SIGNAGE
REMOVE EXISTING STEEL BEAM (6" TO 10" DEEP) ABOVE CEILING

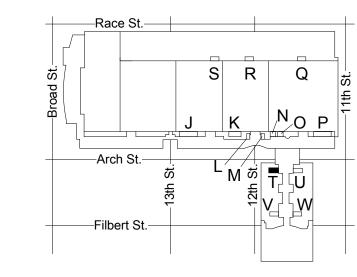

REMOVE EXISTING ENTRY DOOR AND HARDWARE - EXISTING HM

FRAME TO REMAIN AND RECEIVE NEW DOOR

KEY PLAN - LEVEL 200

NTS

Date

Drawn by

NEW FLOOR PLANS - ROOM T (SEMINAR) CW1615 Project number

November 25, 2019

LC/KR


ΕW

DEMOLITION &


Checked by

As indicated

DEMO PLAN - MEN'S & WOMEN'S ROOM T A116 | SCALE: 1/4" = 1'-0"

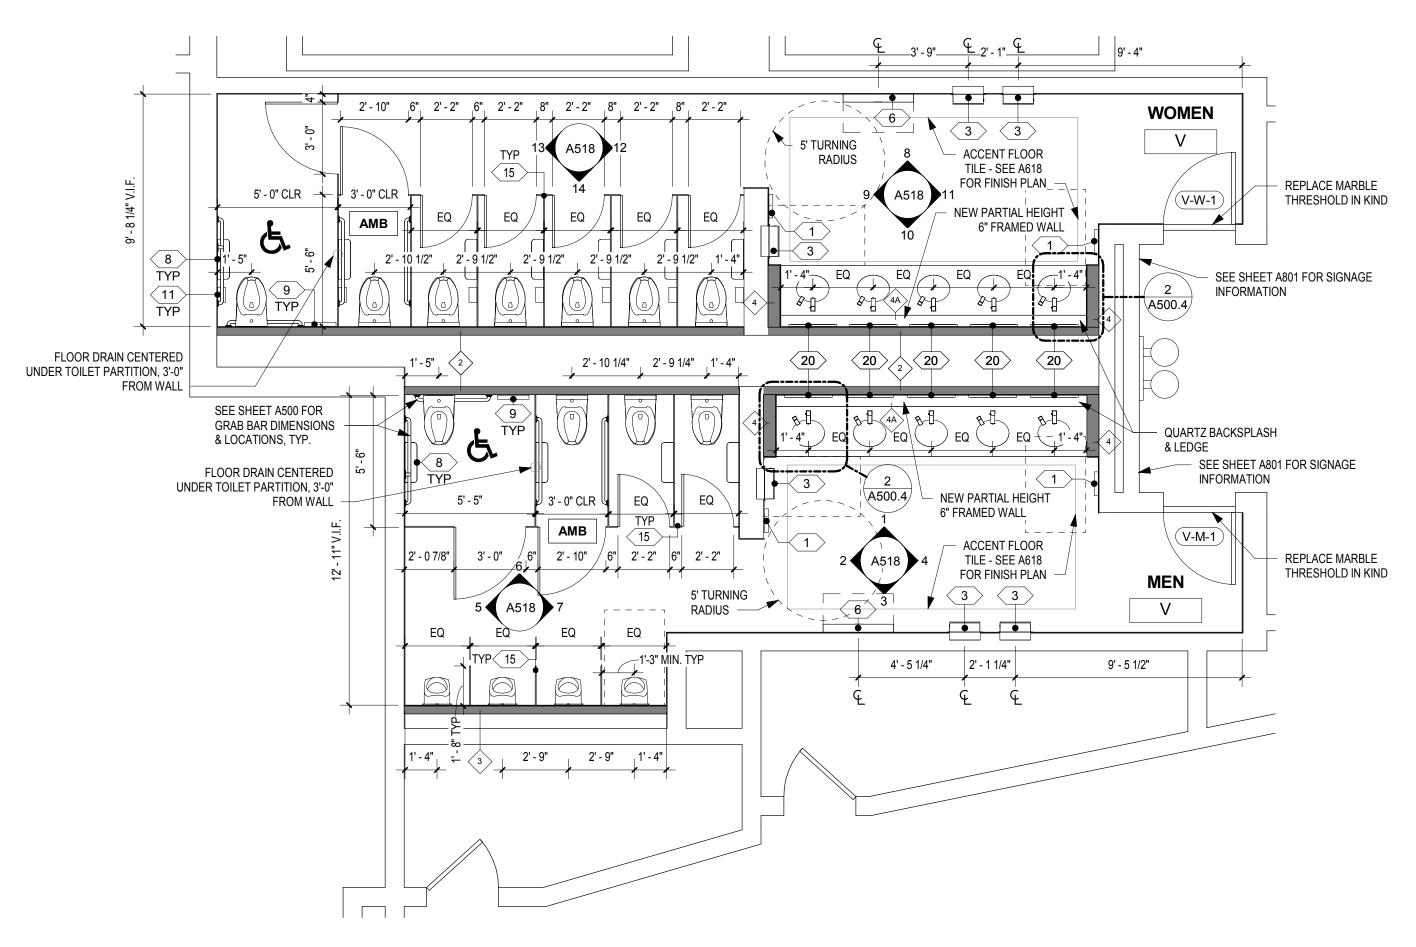

7 FLOOR PLAN - MEN'S & WOMEN'S ROOM V

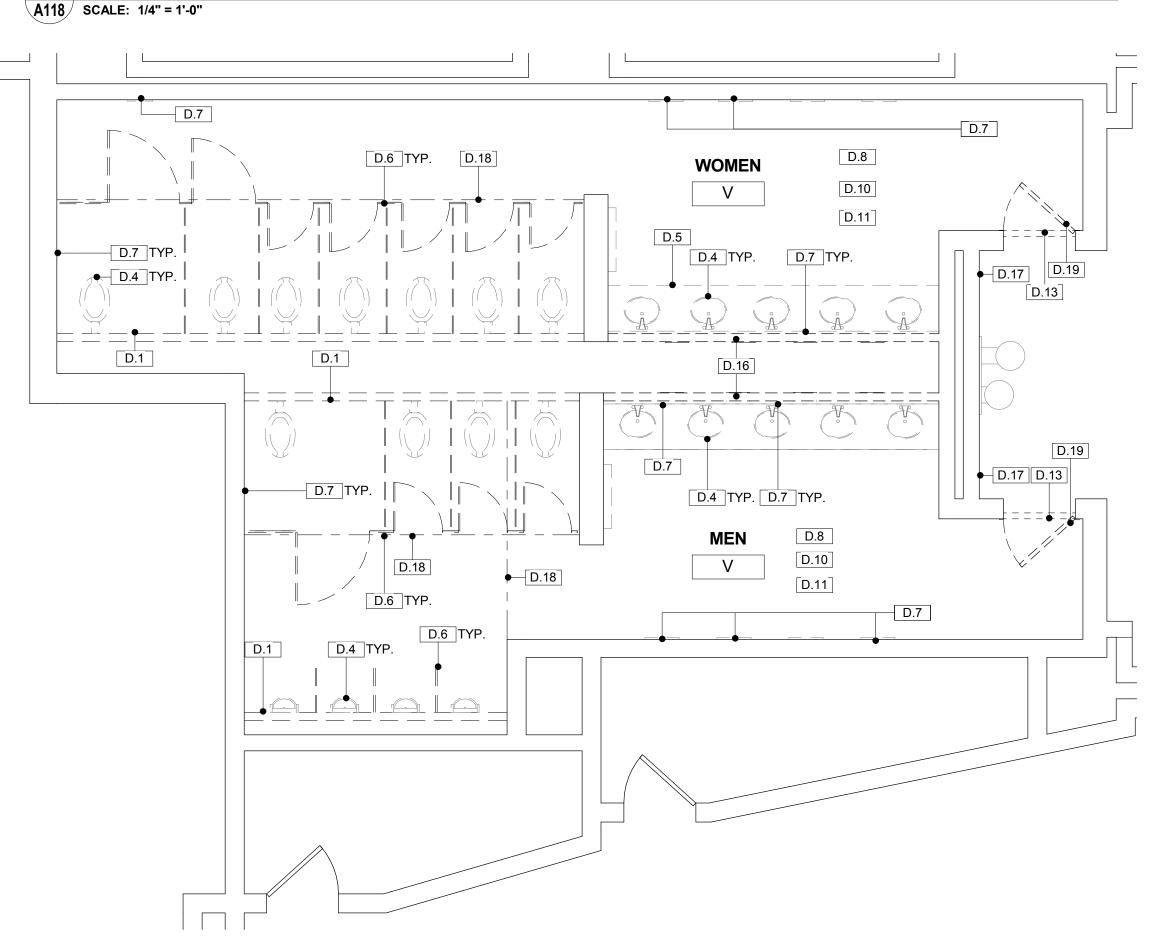

DRAWING GENERAL NOTES

- JANITOR CLOSET DOORS, HOLLOW METAL FRAMES, AND HARDWARE ARE TO REMAIN AND TO BE REPAINTED AS SCHEDULED. ENTRY DOORS AT SEMINAR- AND BALLROOM-TYPE
- ROOMS ARE TO BE REPLACED IN KIND IN EXISTING FRAMES. SEE DOOR SCHEDULE ON A600.1 FOR ADDITIONAL INFORMATION. 2. JANITOR CLOSETS ARE NOT IN CONTRACT, EXCEPT TO REPAINT INTERIOR AND EXTERIOR OF DOORS AND FRAMES AND TO PROVIDE NEW DOOR THRESHOLDS.
- 3. CONTRACTOR IS TO VERIFY THE CONDITION OF EXISTING SUBSTRATES TO RECEIVE NEW FINISHES AND CONFIRM SUITABILITY. IF EXISTING FLOORS DO NOT MEET MEET ALLOWABLE TOLERANCES PER ANSI STANDARDS FOR LARGE-FORMAT TILE, FLASH FLOORS TO LEVEL. SCRIBE WALL TILE AS NECESSARY TO ACCOMMODATE FLOOR LEVEL WITHIN ALLOWABLE TOLERANCE.
- 4. INFILL AND/OR PATCH FLOORS AND WALLS WHERE TOILET PARTITIONS, ACCESSORIES, OR WALLS REMOVED, AND PROVIDE A SOUND AND LEVEL SURFACE TO RECEIVE NEW FINISH. 5. IN SEMINAR/BALLROOM TYPE ROOMS, EXISTING CERAMIC WALL
- TILE IS TO REMAIN ON WALLS TO REMAIN AND NEW SCHEDULED TILE IS TO BE INSTALLED OVER EXISTING TILE. CONTRACTOR TO VERIFY THAT LEVELNESS OF SURFACE IS WITHIN REQUIRED TOLERANCES FOR SPECIFIED NEW TILE FINISH.

- 6. NOT USED.
- 7. GC TO VERIFY THICKNESS OF CERAMIC TILE ASSEMBLY TO BE REMOVED AND ACCOUNT FOR ANY DIFFERENCE IN THICKNESS
- OF NEW TILE ASSEMBLY. 8. NEW PLUMBING FIXTURE LOCATIONS DIFFER FROM EXISTING FIXTURE LOCATIONS. FIXTURE CARRIERS AND ASSOCIATED
- PLUMBING ARE TO BE RELOCATED TO DIMENSIONS SHOWN ON DRAWINGS. 9. SEE SHEET A500 FOR ENLARGED PLANS AND ELEVATIONS OF
- TYPICAL TOILET COMPARTMENTS AND TYPICAL ACCESSORY MOUNTING HEIGHTS. 10. SEE SHEET A500.1 FOR PARTITION TYPES. NEW WALLS ARE TO
- BE CONSTRUCTED IN THE IN SAME LOCATION AS EXISTING DEMOLISHED WALLS, UNLESS NOTED OTHERWISE. 11. SEE A600 SERIES SHEETS FOR REFLECTED CEILING PLANS,
- 12. SEE OVERALL BUILDING PLANS ON SHEETS A001, A002, & A003 FOR LOCATIONS OF ALL DRINKING FOUNTAINS IN PROJECT.

FINISH PLANS, AND FINISH SCHEDULES.

ACCESSORY/EQUIPMENT LEGEND - SEMINAR-TYPE RESTROOMS

1 HAND DRYER - SEMI-RECESSED

2 PAPER TOWEL DISPENSER - AUTO, SEMI-RECESSED

- 3 PAPER TOWEL/TRASH COMBO UNIT AUTO, SEMI-RECESSED (18) MIRROR FULL LENGTH 24" X 72"
- 4 TRASH SEMI-RECESSED WALL MTD.
- 6 DIAPER CHANGING STATION SURFACE-MTD. (UNLESS OTHERWISE NOTED)
- 8 TOILET PAPER DISPENSER DUAL JUMBO ROLL (TYP. IN EACH STALL)
- 9 SEAT COVER DISPENSER (TYP. IN EACH STALL) 11 SANITARY DISPOSAL (TYP. IN EACH WOMEN'S STALL)
- (15) TOILET PARTITIONS 2 COMPACT HIGH-PRESSURE LAMINATE (PHENOLIC), 81" HIGH INCL 9" SUPPORT LEGS; URINAL SCREENS 20" D X 60" H, WALL-MTD.
- (19) MIRROR DOUBLE WIDTH 42" X 54"
- 20 MIRROR SINGLE WIDTH 24" X 54"
- 23 MIRROR SINGLE WIDTH, NARROW 18" X 54" 24 MIRROR - DOUBLE WIDTH, WIDE - 48" X 54"
- (25) MIRROR DOUBLE WIDTH, WIDE 48" X 48"

NOTE: SEE SPECIFICATIONS FOR ADDITIONAL INFORMATION.



WHEELCHAIR ACCESSIBLE TOILET COMPARTMENT - SEE A500 FOR TYPICAL ENLARGED PLANS AND ELEVATIONS.

AMBULATORY ACCESSIBLE TOILET COMPARTMENT - SEE A500 FOR TYPICAL ENLARGED PLANS AND ELEVATIONS.

NO SYMBOL UNLESS OTHERWISE NOTED, TOILET COMPARTMENTS ARE STANDARD.

ADA / ICC ANSI A117.1 REQUIRED CLEARANCES

--- EXISTING 2-HR FIRE RATED WALL (PER AS-BUILT DRAWINGS) TO REMAIN

PARTITION TYPE - SEE SHEET A500.1

DEMOLITION GENERAL NOTES

- 1. SEE PHOTOS ON SOME SHEETS FOR IMAGES OF
- TYPICAL EXISTING TOILET ROOMS. 2. COORDINATE DEMOLITION SCOPE ITEMS WITH NEW
- WORK AND MEP DRAWINGS 3. COORDINATE WITH OWNER FOR REMOVED ACCESSORIES, PLUMBING FIXTURES, LIGHTING FIXTURES, CEILING DEVICES, TOILET PARTITIONS, AND SIGNAGE TO BE SALVAGED.
- 4. JANITOR CLOSET DOORS TO REMAIN. PROTECT
- DURING CONSTRUCTION. 5. FOR STEEL BEAMS INDICATED TO BE REMOVED, GC TO VERIFY THAT BEAMS ARE NOT SUPPORTING ANY
- BUILDING ELEMENT PRIOR TO DEMOLITION. EXERCISE CARE WHEN REMOVING THE BEAMS SO AS NOT TO DAMAGE ANY ADJACENT CONSTRUCTION. BEAMS APPEAR TO HAVE PREVIOUSLY SUPPORTED CEILING-HUNG TOILET PARTITIONS, BUT ARE NO LONGER IN USE.

DEMOLITION KEY NOTES

D.1	REMOVE EXISTING 4" CMU CHASE WALL (AT ROOMS T,V, & W, EXISTING WALL IS 4" METAL FRAMING)
D.4	REMOVE EXISTING PLUMBING FIXTURE - SEE PLUMBING DWGS
D.5	REMOVE EXISTING COUNTERTOP & SUPPORT FRAMING
D.6	REMOVE EXISTING TOILET/URINAL PARTITIONS
D.7	REMOVE EXISTING WALL-MOUNTED ACCESSORIES
D.8	REMOVE EXISTING CERAMIC FLOOR TILE TO CONCRETE SLAB
D.10	REMOVE EXISTING GWB CEILING, SUPPORT STRUCTURE, & CEILING-MOUNTED DEVICES THROUGHOUT ROOM - SEE MEP DWGS.
D.11	REMOVE EXISTING LIGHT FIXTURES - SEE ELECTRICAL DWGS.
D.13	REMOVE EXISTING DOOR THRESHOLD (ALUMINUM THRESHOLD A EXHIBIT-TYPE ROOMS; MARBLE THRESHOLD AT SEMINAR-TYPE

REMOVE EXISTING CHASE WALL - 4 COURSES 8" CMU & METAL FRAMING ABOVE

FRAME TO REMAIN AND RECEIVE NEW DOOR

-Filbert St.-

- REMOVE EXISTING WALL-MOUNTED SIGNAGE REMOVE EXISTING STEEL BEAM (6" TO 10" DEEP) ABOVE CEILING REMOVE EXISTING ENTRY DOOR AND HARDWARE - EXISTING HM
 - –Race St.—— S R Q -Arch St.

KEY PLAN - LEVEL 200



DEMOLITION & NEW FLOOR PLANS - ROOM V (SEMINAR)

RESTROOM RENOVATIONS
101 ARCH STREET, PHILADELPHIA, PA 191

CONVERSE WINKLER ARCHITECTURE

331 MONTGOMERY AVE BALA CYNWYD, PA 19144

ARCHITECTS:

ARCHITECTURE

Ph: 610.664.0806

Fax: 215.664.1075

MEP ENGINEERS:

Contact: Kevin Sultanik

CSA GROUP

Ph: 215.427.8700

Fax: 215.427.8752

Contact: Wing Au

REVISIONS:

PENNSYLVANIA CONVENTION CENTER

Description

SUITE 507

STRUCTURAL ENGINEERS:

PHILADELPHIA, PA 19125

e-mail: wau@csagroup.com

Contact: Elin Westrick

e-mail: ewestrick@cwarc.com

P (610) 459-7900 F (610) 459-7950 aroraengineers.com

e-mail: ksultanik@aroraengineers.com

1341 NORTH DELAWARE AVENUE,

Arora Engineers, Inc.

Chadds Ford, PA 19317

CONVERSE WINKLER

331 Montgomery Avenue,


Bala Cynwyd, PA, 19144

CW1615 Project number November 25, 2019 Date Drawn by LC/KR EW Checked by

As indicated


DEMO PLAN - MEN'S & WOMEN'S ROOM V

A118 SCALE: 1/4" = 1'-0"

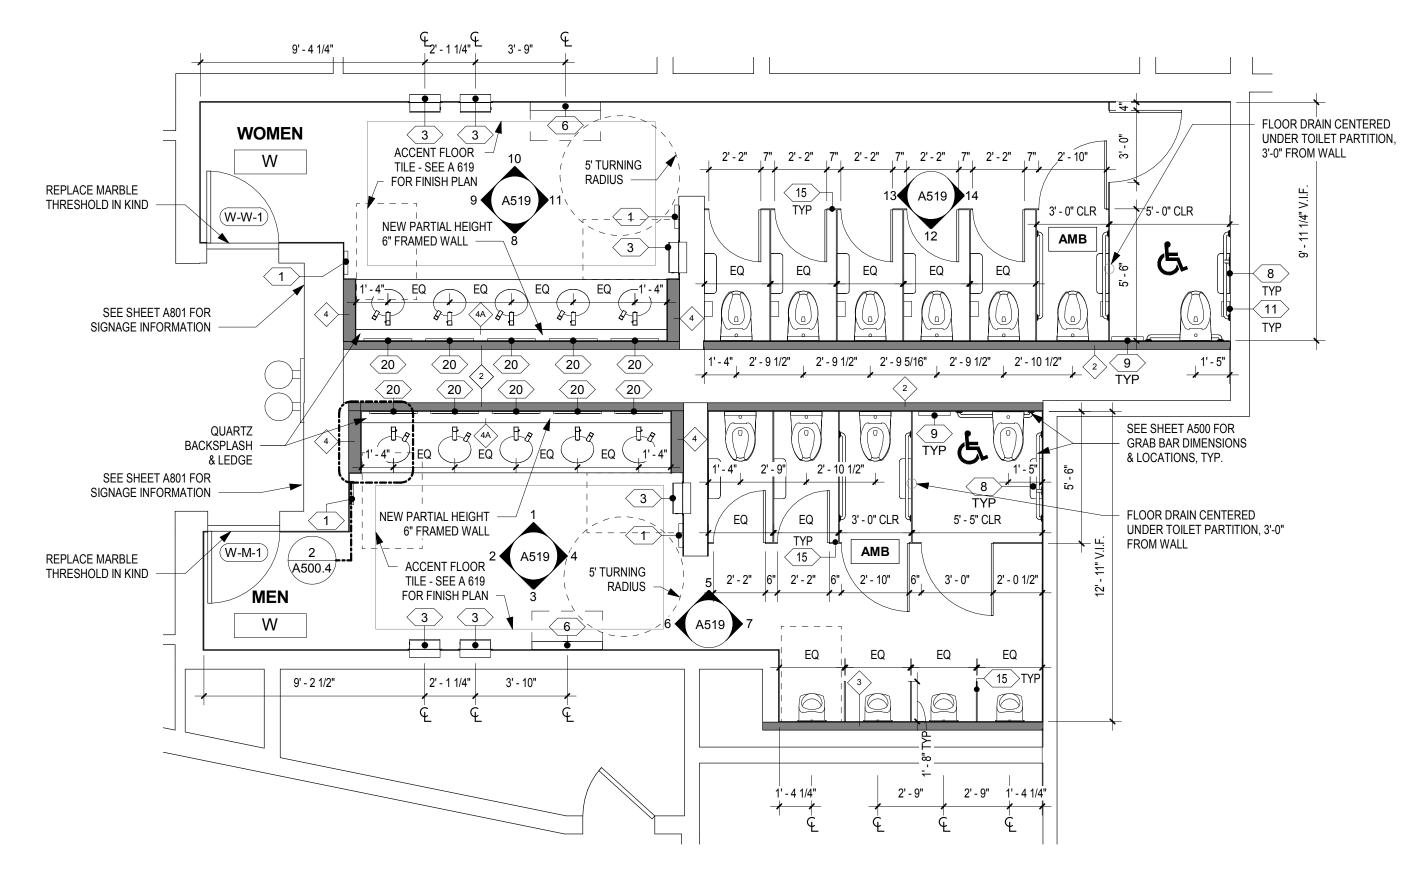

7 FLOOR PLAN - MEN'S & WOMEN'S ROOM W

A119 SCALE: 1/4" = 1'-0"

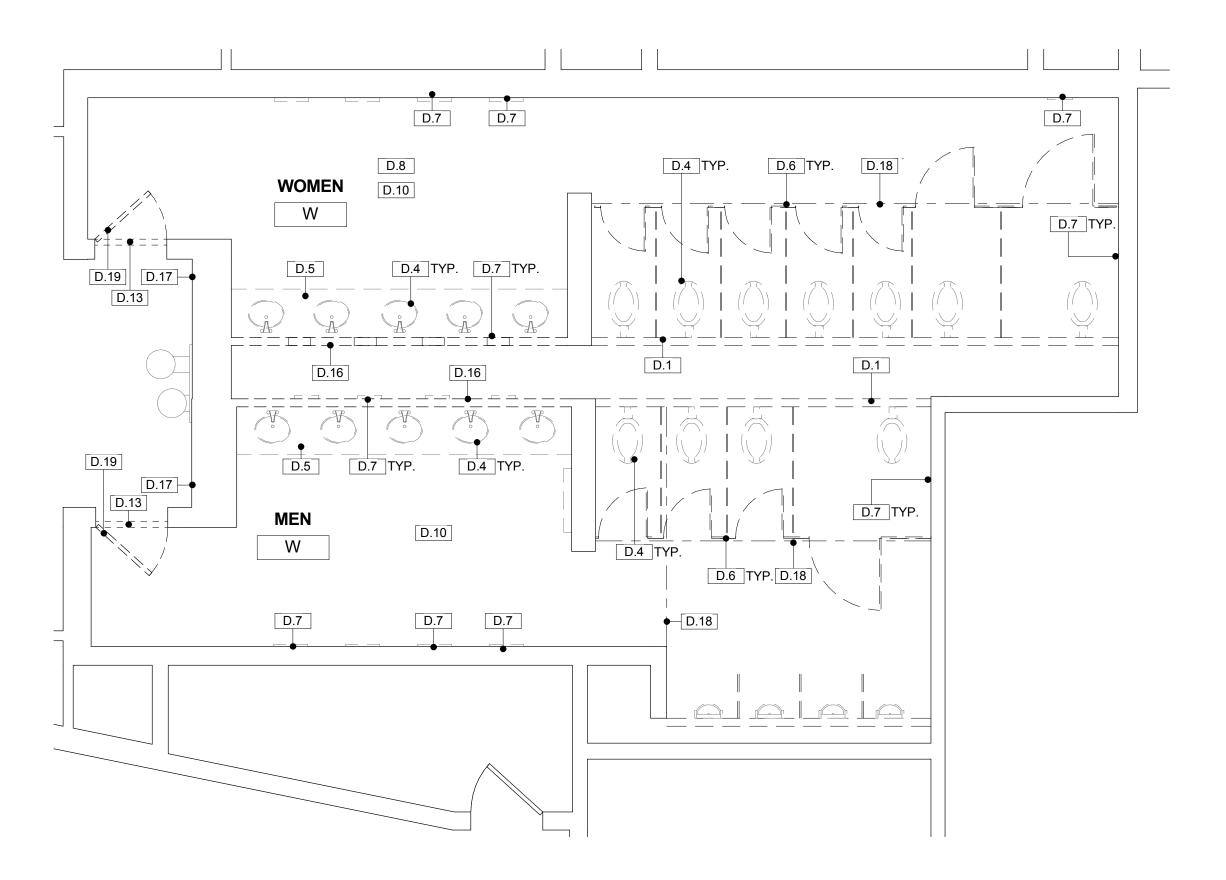

TYPICAL LARGE SEMINAR RESTROOM W WOMEN'S - EXISTING

DEMO PLAN - MEN'S & WOMEN'S ROOM W

A119 SCALE: 1/4" = 1'-0"

DRAWING GENERAL NOTES

- 1. JANITOR CLOSET DOORS, HOLLOW METAL FRAMES, AND HARDWARE ARE TO REMAIN AND TO BE REPAINTED AS SCHEDULED. ENTRY DOORS AT SEMINAR- AND BALLROOM-TYPE ROOMS ARE TO BE REPLACED IN KIND IN EXISTING FRAMES. SEE
 - DOOR SCHEDULE ON A600.1 FOR ADDITIONAL INFORMATION. JANITOR CLOSETS ARE NOT IN CONTRACT, EXCEPT TO REPAINT INTERIOR AND EXTERIOR OF DOORS AND FRAMES AND TO PROVIDE NEW DOOR THRESHOLDS.
- 3. CONTRACTOR IS TO VERIFY THE CONDITION OF EXISTING SUBSTRATES TO RECEIVE NEW FINISHES AND CONFIRM SUITABILITY. IF EXISTING FLOORS DO NOT MEET MEET ALLOWABLE TOLERANCES PER ANSI STANDARDS FOR LARGE-FORMAT TILE, FLASH FLOORS TO LEVEL, SCRIBE WALL TILE AS NECESSARY TO ACCOMMODATE FLOOR LEVEL WITHIN
- ALLOWABLE TOLERANCE. 4. INFILL AND/OR PATCH FLOORS AND WALLS WHERE TOILET PARTITIONS, ACCESSORIES, OR WALLS REMOVED, AND PROVIDE A SOUND AND LEVEL SURFACE TO RECEIVE NEW FINISH.
- 5. IN SEMINAR/BALLROOM TYPE ROOMS, EXISTING CERAMIC WALI TILE IS TO REMAIN ON WALLS TO REMAIN AND NEW SCHEDULED TILE IS TO BE INSTALLED OVER EXISTING TILE. CONTRACTOR TO VERIFY THAT LEVELNESS OF SURFACE IS WITHIN REQUIRED TOLERANCES FOR SPECIFIED NEW TILE FINISH.

- 6. NOT USED.
- 7. GC TO VERIFY THICKNESS OF CERAMIC TILE ASSEMBLY TO BE REMOVED AND ACCOUNT FOR ANY DIFFERENCE IN THICKNESS OF NEW TILE ASSEMBLY.
- 8. NEW PLUMBING FIXTURE LOCATIONS DIFFER FROM EXISTING FIXTURE LOCATIONS. FIXTURE CARRIERS AND ASSOCIATED PLUMBING ARE TO BE RELOCATED TO DIMENSIONS SHOWN ON
- DRAWINGS. 9. SEE SHEET A500 FOR ENLARGED PLANS AND ELEVATIONS OF TYPICAL TOILET COMPARTMENTS AND TYPICAL ACCESSORY
- MOUNTING HEIGHTS. 10. SEE SHEET A500.1 FOR PARTITION TYPES. NEW WALLS ARE TO BE CONSTRUCTED IN THE IN SAME LOCATION AS EXISTING
- DEMOLISHED WALLS, UNLESS NOTED OTHERWISE. 11. SEE A600 SERIES SHEETS FOR REFLECTED CEILING PLANS,
- FINISH PLANS, AND FINISH SCHEDULES. 12. SEE OVERALL BUILDING PLANS ON SHEETS A001, A002, & A003 FOR LOCATIONS OF ALL DRINKING FOUNTAINS IN PROJECT.

ACCESSORY/EQUIPMENT LEGEND - SEMINAR-TYPE RESTROOMS

- 1 HAND DRYER SEMI-RECESSED
- 2 PAPER TOWEL DISPENSER AUTO, SEMI-RECESSED
- 4 TRASH SEMI-RECESSED WALL MTD.
- 6 DIAPER CHANGING STATION SURFACE-MTD. (UNLESS OTHERWISE NOTED)
- (8) TOILET PAPER DISPENSER DUAL JUMBO ROLL (TYP. IN EACH STALL)
- 9 SEAT COVER DISPENSER (TYP. IN EACH STALL)

(11) SANITARY DISPOSAL (TYP. IN EACH WOMEN'S STALL)

- (15) TOILET PARTITIONS 2 COMPACT HIGH-PRESSURE LAMINATE (PHENOLIC), 81" HIGH INCL 9" SUPPORT LEGS; URINAL SCREENS 20" D X 60" H, WALL-MTD.
- 3 PAPER TOWEL/TRASH COMBO UNIT AUTO, SEMI-RECESSED 18 MIRROR FULL LENGTH 24" X 72"
 - (19) MIRROR DOUBLE WIDTH 42" X 54" 20 MIRROR - SINGLE WIDTH - 24" X 54"

 - 23 MIRROR SINGLE WIDTH, NARROW 18" X 54"
 - $\langle 24 \rangle$ MIRROR DOUBLE WIDTH, WIDE 48" X 54"
 - 25 MIRROR DOUBLE WIDTH, WIDE 48" X 48"

NOTE: SEE SPECIFICATIONS FOR ADDITIONAL INFORMATION.



WHEELCHAIR ACCESSIBLE TOILET COMPARTMENT - SEE A500 FOR TYPICAL ENLARGED PLANS AND ELEVATIONS.

AMBULATORY ACCESSIBLE TOILET COMPARTMENT - SEE A500 FOR TYPICAL ENLARGED PLANS AND ELEVATIONS.

NO SYMBOL UNLESS OTHERWISE NOTED, TOILET COMPARTMENTS ARE STANDARD.

ADA / ICC ANSI A117.1 REQUIRED CLEARANCES

EXISTING 2-HR FIRE RATED WALL (PER AS-BUILT DRAWINGS) TO REMAIN


PARTITION TYPE - SEE SHEET A500.1

DEMOLITION GENERAL NOTES

- 1. SEE PHOTOS ON SOME SHEETS FOR IMAGES OF TYPICAL EXISTING TOILET ROOMS. 2. COORDINATE DEMOLITION SCOPE ITEMS WITH NEW
- WORK AND MEP DRAWINGS. 3. COORDINATE WITH OWNER FOR REMOVED ACCESSORIES, PLUMBING FIXTURES, LIGHTING FIXTURES, CEILING DEVICES, TOILET PARTITIONS, AND SIGNAGE TO BE SALVAGED.
- 4. JANITOR CLOSET DOORS TO REMAIN. PROTECT DURING CONSTRUCTION.
- 5. FOR STEEL BEAMS INDICATED TO BE REMOVED, GC TO VERIFY THAT BEAMS ARE NOT SUPPORTING ANY BUILDING ELEMENT PRIOR TO DEMOLITION. EXERCISE CARE WHEN REMOVING THE BEAMS SO AS NOT TO DAMAGE ANY ADJACENT CONSTRUCTION. BEAMS APPEAR TO HAVE PREVIOUSLY SUPPORTED CEILING-HUNG TOILET PARTITIONS, BUT ARE NO LONGER IN USE.
- REMOVE EXISTING 4" CMU CHASE WALL (AT ROOMS T,V, & W, **EXISTING WALL IS 4" METAL FRAMING)** REMOVE EXISTING PLUMBING FIXTURE - SEE PLUMBING DWGS REMOVE EXISTING COUNTERTOP & SUPPORT FRAMING REMOVE EXISTING TOILET/URINAL PARTITIONS REMOVE EXISTING WALL-MOUNTED ACCESSORIES REMOVE EXISTING CERAMIC FLOOR TILE TO CONCRETE SLAB REMOVE EXISTING GWB CEILING, SUPPORT STRUCTURE, & CEILING-MOUNTED DEVICES THROUGHOUT ROOM - SEE MEP

DEMOLITION KEY NOTES

- REMOVE EXISTING DOOR THRESHOLD (ALUMINUM THRESHOLD AT EXHIBIT-TYPE ROOMS; MARBLE THRESHOLD AT SEMINAR-TYPE
- REMOVE EXISTING CHASE WALL 4 COURSES 8" CMU & METAL FRAMING ABOVE REMOVE EXISTING WALL-MOUNTED SIGNAGE
- REMOVE EXISTING STEEL BEAM (6" TO 10" DEEP) ABOVE CEILING REMOVE EXISTING ENTRY DOOR AND HARDWARE - EXISTING HM FRAME TO REMAIN AND RECEIVE NEW DOOR

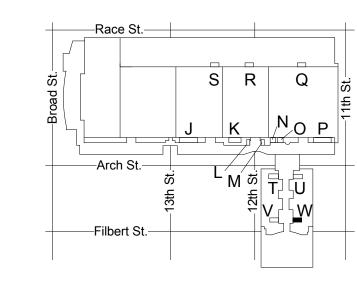

KEY PLAN - LEVEL 200

NTS

Date Drawn by Checked by

PENNSYLVANIA CONVENTION CENTER RESTROOM RENOVATIONS

CONVERSE

331 MONTGOMERY AVE BALA CYNWYD, PA 19144

WINKLER ARCHITECTURE

ARCHITECTS:

ARCHITECTURE

Ph: 610.664.0806

Fax: 215.664.1075

MEP ENGINEERS:

Contact: Kevin Sultanik

CSA GROUP

Ph: 215.427.8700

Fax: 215.427.8752

Contact: Wing Au

REVISIONS:

Description

SUITE 507

STRUCTURAL ENGINEERS:

PHILADELPHIA, PA 19125

e-mail: wau@csagroup.com

Contact: Elin Westrick

e-mail: ewestrick@cwarc.com

P (610) 459-7900 F (610) 459-7950 aroraengineers.com

e-mail: ksultanik@aroraengineers.com

1341 NORTH DELAWARE AVENUE,

Arora Engineers, Inc.

Chadds Ford, PA 19317

CONVERSE WINKLER

331 Montgomery Avenue,

Bala Cynwyd, PA, 19144

DEMOLITION & NEW FLOOR PLANS - ROOM W (SEMINAR)


CW1615 Project number November 25, 2019 LC/KR ΕW




X MEN'S - EXISTING



X WOMEN'S- EXISTING

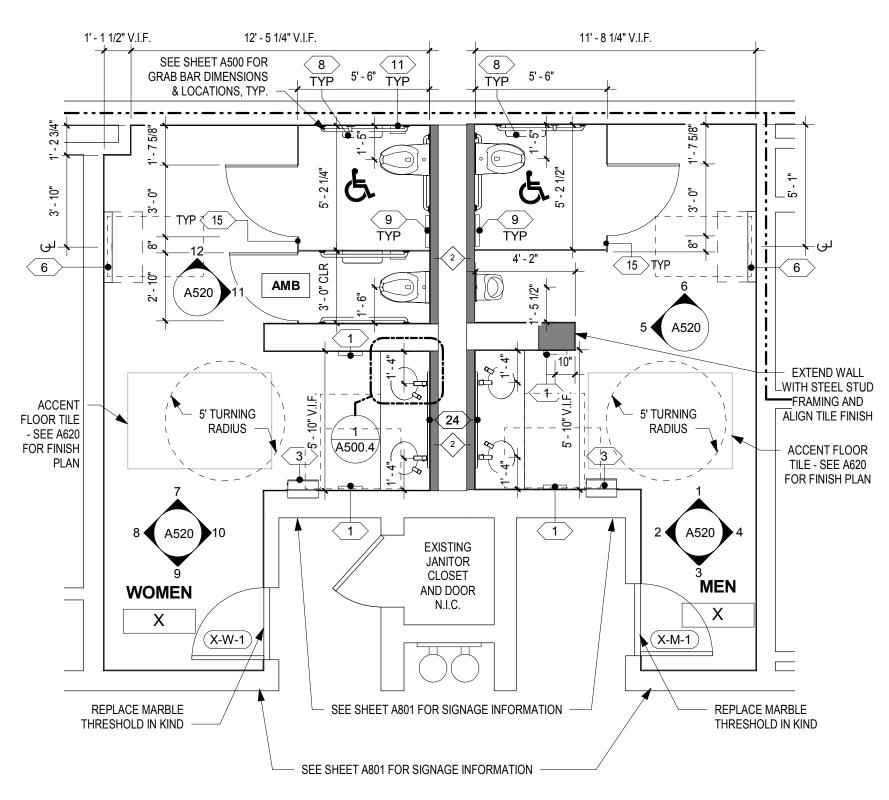

FLOOR PLAN - MEN'S & WOMEN'S ROOM X A120 SCALE: 1/4" = 1'-0"

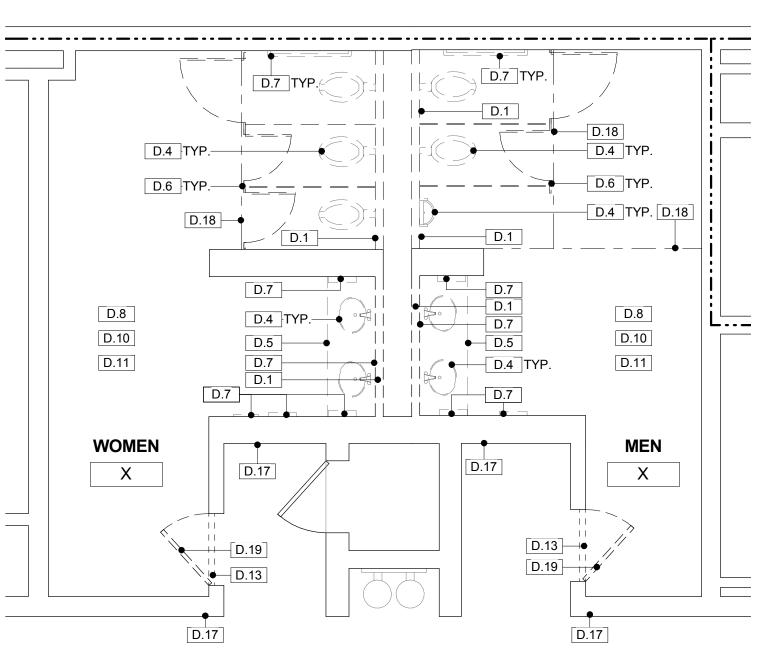

A120 SCALE: 1/4" = 1'-0"

DRAWING GENERAL NOTES

- 1. JANITOR CLOSET DOORS, HOLLOW METAL FRAMES, AND HARDWARE ARE TO REMAIN AND TO BE REPAINTED AS SCHEDULED. ENTRY DOORS AT SEMINAR- AND BALLROOM-TYPE ROOMS ARE TO BE REPLACED IN KIND IN EXISTING FRAMES. SEE DOOR SCHEDULE ON A600.1 FOR ADDITIONAL INFORMATION.
- 2. JANITOR CLOSETS ARE NOT IN CONTRACT, EXCEPT TO REPAINT INTERIOR AND EXTERIOR OF DOORS AND FRAMES AND TO PROVIDE NEW DOOR THRESHOLDS. 3. CONTRACTOR IS TO VERIFY THE CONDITION OF EXISTING
- SUBSTRATES TO RECEIVE NEW FINISHES AND CONFIRM SUITABILITY. IF EXISTING FLOORS DO NOT MEET MEET ALLOWABLE TOLERANCES PER ANSI STANDARDS FOR LARGE-FORMAT TILE, FLASH FLOORS TO LEVEL. SCRIBE WALL TILE AS NECESSARY TO ACCOMMODATE FLOOR LEVEL WITHIN ALLOWABLE TOLERANCE.
- 4. INFILL AND/OR PATCH FLOORS AND WALLS WHERE TOILET PARTITIONS, ACCESSORIES, OR WALLS REMOVED, AND PROVIDE A SOUND AND LEVEL SURFACE TO RECEIVE NEW FINISH. 5. IN SEMINAR/BALLROOM TYPE ROOMS, EXISTING CERAMIC WALL TILE IS TO REMAIN ON WALLS TO REMAIN AND NEW SCHEDULED
- TILE IS TO BE INSTALLED OVER EXISTING TILE. CONTRACTOR TO VERIFY THAT LEVELNESS OF SURFACE IS WITHIN REQUIRED TOLERANCES FOR SPECIFIED NEW TILE FINISH.

- 6. NOT USED.
- 7. GC TO VERIFY THICKNESS OF CERAMIC TILE ASSEMBLY TO BE REMOVED AND ACCOUNT FOR ANY DIFFERENCE IN THICKNESS OF NEW TILE ASSEMBLY.
- 8. NEW PLUMBING FIXTURE LOCATIONS DIFFER FROM EXISTING FIXTURE LOCATIONS. FIXTURE CARRIERS AND ASSOCIATED PLUMBING ARE TO BE RELOCATED TO DIMENSIONS SHOWN ON
- DRAWINGS. 9. SEE SHEET A500 FOR ENLARGED PLANS AND ELEVATIONS OF TYPICAL TOILET COMPARTMENTS AND TYPICAL ACCESSORY
- MOUNTING HEIGHTS. 10. SEE SHEET A500.1 FOR PARTITION TYPES. NEW WALLS ARE TO BE CONSTRUCTED IN THE IN SAME LOCATION AS EXISTING DEMOLISHED WALLS, UNLESS NOTED OTHERWISE.
- 11. SEE A600 SERIES SHEETS FOR REFLECTED CEILING PLANS, FINISH PLANS, AND FINISH SCHEDULES.
- 12. SEE OVERALL BUILDING PLANS ON SHEETS A001, A002, & A003 FOR LOCATIONS OF ALL DRINKING FOUNTAINS IN PROJECT.

ACCESSORY/EQUIPMENT LEGEND - SEMINAR-TYPE RESTROOMS

- < 1 > HAND DRYER SEMI-RECESSED
- 2 PAPER TOWEL DISPENSER AUTO, SEMI-RECESSED
- 3 PAPER TOWEL/TRASH COMBO UNIT AUTO, SEMI-RECESSED
- 4 TRASH SEMI-RECESSED WALL MTD.
- 6 DIAPER CHANGING STATION SURFACE-MTD. (UNLESS OTHERWISE NOTED)
- 8 TOILET PAPER DISPENSER DUAL JUMBO ROLL (TYP. IN
- 9 SEAT COVER DISPENSER (TYP. IN EACH STALL)
- EACH STALL)
- (11) SANITARY DISPOSAL (TYP. IN EACH WOMEN'S STALL)
- URINAL SCREENS 20" D X 60" H, WALL-MTD. 18 MIRROR - FULL LENGTH - 24" X 72"

(15) TOILET PARTITIONS 2 - COMPACT HIGH-PRESSURE

LAMINATE (PHENOLIC), 81" HIGH INCL 9" SUPPORT LEGS;

- 19 MIRROR DOUBLE WIDTH 42" X 54"
- 20 MIRROR SINGLE WIDTH 24" X 54"
- 23 MIRROR SINGLE WIDTH, NARROW 18" X 54"
- MIRROR DOUBLE WIDTH, WIDE 48" X 54"
- 25 MIRROR DOUBLE WIDTH, WIDE 48" X 48"

NOTE: SEE SPECIFICATIONS FOR ADDITIONAL INFORMATION.



WHEELCHAIR ACCESSIBLE TOILET COMPARTMENT - SEE A500 FOR TYPICAL ENLARGED PLANS AND ELEVATIONS.

AMBULATORY ACCESSIBLE TOILET COMPARTMENT - SEE A500 FOR TYPICAL ENLARGED PLANS AND ELEVATIONS.

NO SYMBOL UNLESS OTHERWISE NOTED, TOILET COMPARTMENTS ARE STANDARD. ADA / ICC ANSI A117.1 REQUIRED CLEARANCES

--- EXISTING 2-HR FIRE RATED WALL (PER AS-BUILT DRAWINGS) TO REMAIN

PARTITION TYPE - SEE SHEET A500.1


DEMOLITION GENERAL NOTES

- 1. SEE PHOTOS ON SOME SHEETS FOR IMAGES OF TYPICAL EXISTING TOILET ROOMS. 2. COORDINATE DEMOLITION SCOPE ITEMS WITH NEW WORK AND MEP DRAWINGS.
- 3. COORDINATE WITH OWNER FOR REMOVED ACCESSORIES, PLUMBING FIXTURES, LIGHTING FIXTURES, CEILING DEVICES, TOILET PARTITIONS, AND SIGNAGE TO BE SALVAGED.
- 4. JANITOR CLOSET DOORS TO REMAIN. PROTECT DURING CONSTRUCTION.
- 5. FOR STEEL BEAMS INDICATED TO BE REMOVED, GC TO VERIFY THAT BEAMS ARE NOT SUPPORTING ANY BUILDING ELEMENT PRIOR TO DEMOLITION. EXERCISE CARE WHEN REMOVING THE BEAMS SO AS NOT TO DAMAGE ANY ADJACENT CONSTRUCTION. BEAMS APPEAR TO HAVE PREVIOUSLY SUPPORTED CEILING-HUNG TOILET PARTITIONS, BUT ARE NO LONGER IN USE.

DEMOLITION KEY NOTES

REMOVE EXISTING 4" CMU CHASE WALL (AT ROOMS T,V, & W,

	EXISTING WALL IS 4" METAL FRAMING)
D.4	REMOVE EXISTING PLUMBING FIXTURE - SEE PLUMBING DWGS
D.5	REMOVE EXISTING COUNTERTOP & SUPPORT FRAMING
D.6	REMOVE EXISTING TOILET/URINAL PARTITIONS
D.7	REMOVE EXISTING WALL-MOUNTED ACCESSORIES
D.8	REMOVE EXISTING CERAMIC FLOOR TILE TO CONCRETE SLAB
D.10	REMOVE EXISTING GWB CEILING, SUPPORT STRUCTURE, & CEILING-MOUNTED DEVICES THROUGHOUT ROOM - SEE MEP DWGS.
D.11	REMOVE EXISTING LIGHT FIXTURES - SEE ELECTRICAL DWGS.
D.13	REMOVE EXISTING DOOR THRESHOLD (ALUMINUM THRESHOLD EXHIBIT-TYPE ROOMS; MARBLE THRESHOLD AT SEMINAR-TYPE ROOMS)
D.17	REMOVE EXISTING WALL-MOUNTED SIGNAGE
D.18	REMOVE EXISTING STEEL BEAM (6" TO 10" DEEP) ABOVE CEILIN
D.19	REMOVE EXISTING ENTRY DOOR AND HARDWARE - EXISTING HIFRAME TO REMAIN AND RECEIVE NEW DOOR

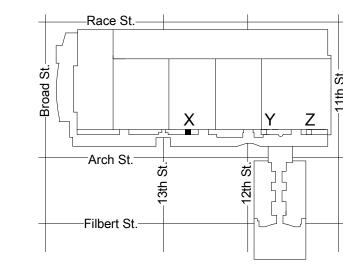

NEW FLOOR PLANS - ROOM X (SEMINAR)

CW1615

ΕW

November 25, 2019

DEMOLITION &

CONVERSE WINKLER

ARCHITECTURE 331 MONTGOMERY AVE BALA CYNWYD, PA 19144

ARCHITECTS:

ARCHITECTURE

Ph: 610.664.0806

Fax: 215.664.1075

MEP ENGINEERS:

ARORA°

Contact: Kevin Sultanik

CSA GROUP

Ph: 215.427.8700

Fax: 215.427.8752

Contact: Wing Au

REVISIONS:

ER

ANIA

PENNSYLV NVENTION

Description

SUITE 507

STRUCTURAL ENGINEERS:

PHILADELPHIA, PA 19125

e-mail: wau@csagroup.com

Contact: Elin Westrick

e-mail: ewestrick@cwarc.com

P (610) 459-7900 | F (610) 459-7950 | aroraengineers.com

e-mail: ksultanik@aroraengineers.com

1341 NORTH DELAWARE AVENUE,

Arora Engineers, Inc.

Chadds Ford, PA 19317

CONVERSE WINKLER

331 Montgomery Avenue,

Bala Cynwyd, PA, 19144


LC/KR Drawn by Checked by

Project number

As indicated


KEY PLAN - LEVEL 300

DEMO PLAN - MEN'S & WOMEN'S ROOM X

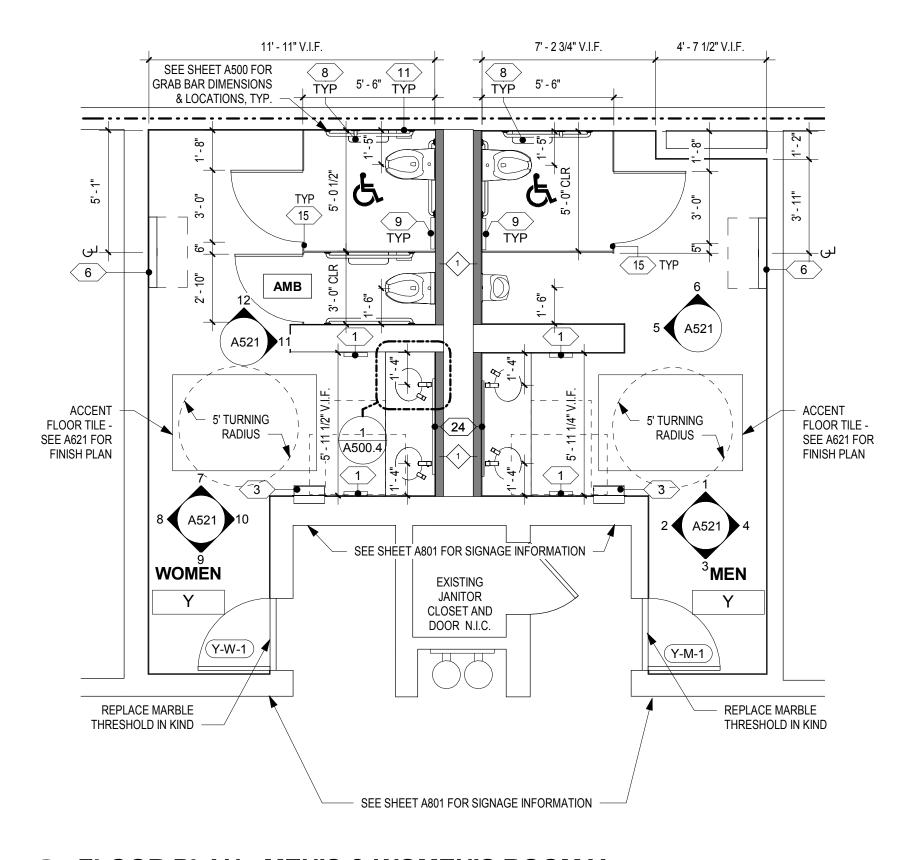

FLOOR PLAN - MEN'S & WOMEN'S ROOM Y

A121 SCALE: 1/4" = 1'-0"

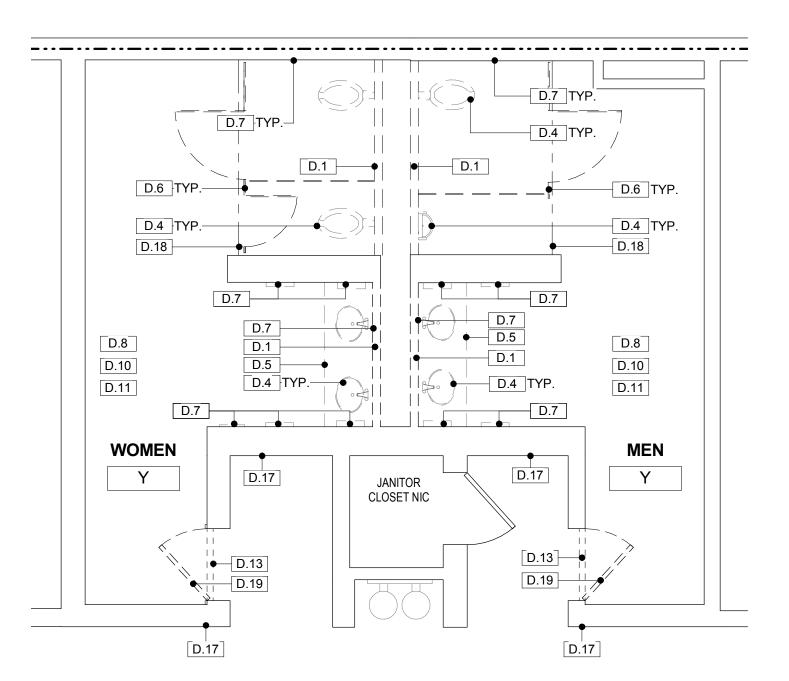

1 DEMO PLAN - MEN'S & WOMEN'S ROOM Y

A121 SCALE: 1/4" = 1'-0"

DRAWING GENERAL NOTES

- 1. JANITOR CLOSET DOORS, HOLLOW METAL FRAMES, AND HARDWARE ARE TO REMAIN AND TO BE REPAINTED AS SCHEDULED. ENTRY DOORS AT SEMINAR- AND BALLROOM-TYPE ROOMS ARE TO BE REPLACED IN KIND IN EXISTING FRAMES. SEE DOOR SCHEDULE ON A600.1 FOR ADDITIONAL INFORMATION.
- 2. JANITOR CLOSETS ARE NOT IN CONTRACT, EXCEPT TO REPAINT INTERIOR AND EXTERIOR OF DOORS AND FRAMES AND TO PROVIDE NEW DOOR THRESHOLDS.
- 3. CONTRACTOR IS TO VERIFY THE CONDITION OF EXISTING SUBSTRATES TO RECEIVE NEW FINISHES AND CONFIRM SUITABILITY. IF EXISTING FLOORS DO NOT MEET MEET ALLOWABLE TOLERANCES PER ANSI STANDARDS FOR LARGE-FORMAT TILE, FLASH FLOORS TO LEVEL. SCRIBE WALL TILE AS NECESSARY TO ACCOMMODATE FLOOR LEVEL WITHIN ALLOWABLE TOLERANCE.
- 4. INFILL AND/OR PATCH FLOORS AND WALLS WHERE TOILET PARTITIONS, ACCESSORIES, OR WALLS REMOVED, AND PROVIDE A SOUND AND LEVEL SURFACE TO RECEIVE NEW FINISH.
- 5. IN SEMINAR/BALLROOM TYPE ROOMS, EXISTING CERAMIC WALL TILE IS TO REMAIN ON WALLS TO REMAIN AND NEW SCHEDULED TILE IS TO BE INSTALLED OVER EXISTING TILE. CONTRACTOR TO VERIFY THAT LEVELNESS OF SURFACE IS WITHIN REQUIRED
- TOLERANCES FOR SPECIFIED NEW TILE FINISH.

- 6. NOT USED.
- 7. GC TO VERIFY THICKNESS OF CERAMIC TILE ASSEMBLY TO BE REMOVED AND ACCOUNT FOR ANY DIFFERENCE IN THICKNESS OF NEW TILE ASSEMBLY.
- DRAWINGS.
- MOUNTING HEIGHTS 10. SEE SHEET A500.1 FOR PARTITION TYPES. NEW WALLS ARE TO
- BE CONSTRUCTED IN THE IN SAME LOCATION AS EXISTING DEMOLISHED WALLS, UNLESS NOTED OTHERWISE.
- FINISH PLANS, AND FINISH SCHEDULES.

1 HAND DRYER - SEMI-RECESSED

- 2 PAPER TOWEL DISPENSER AUTO, SEMI-RECESSED

- 6 DIAPER CHANGING STATION SURFACE-MTD. (UNLESS OTHERWISE NOTED)
- 8 TOILET PAPER DISPENSER DUAL JUMBO ROLL (TYP. IN EACH STALL)
- 9 SEAT COVER DISPENSER (TYP. IN EACH STALL) 11 > SANITARY DISPOSAL (TYP. IN EACH WOMEN'S STALL)
- 15 TOILET PARTITIONS 2 COMPACT HIGH-PRESSURE LAMINATE (PHENOLIC), 81" HIGH INCL 9" SUPPORT LEGS;
- URINAL SCREENS 20" D X 60" H, WALL-MTD.
- (19) MIRROR DOUBLE WIDTH 42" X 54"
- 20 MIRROR SINGLE WIDTH 24" X 54"
- 23 MIRROR SINGLE WIDTH, NARROW 18" X 54"

WHEELCHAIR ACCESSIBLE TOILET COMPARTMENT - SEE A500 FOR TYPICAL ENLARGED

PLANS AND ELEVATIONS.

AMBULATORY ACCESSIBLE TOILET COMPARTMENT - SEE A500 FOR TYPICAL ENLARGED PLANS AND ELEVATIONS.

ADA / ICC ANSI A117.1 REQUIRED CLEARANCES

NO SYMBOL UNLESS OTHERWISE NOTED, TOILET COMPARTMENTS ARE STANDARD.

---- EXISTING 2-HR FIRE RATED WALL (PER AS-BUILT DRAWINGS) TO REMAIN

PARTITION TYPE - SEE SHEET A500.1


DEMOLITION GENERAL NOTES

- 1. SEE PHOTOS ON SOME SHEETS FOR IMAGES OF TYPICAL EXISTING TOILET ROOMS.
- 2. COORDINATE DEMOLITION SCOPE ITEMS WITH NEW WORK AND MEP DRAWINGS. COORDINATE WITH OWNER FOR REMOVED
- ACCESSORIES, PLUMBING FIXTURES, LIGHTING FIXTURES, CEILING DEVICES, TOILET PARTITIONS, AND SIGNAGE TO BE SALVAGED.
- 4. JANITOR CLOSET DOORS TO REMAIN. PROTECT DURING CONSTRUCTION.
- 5. FOR STEEL BEAMS INDICATED TO BE REMOVED, GC TO VERIFY THAT BEAMS ARE NOT SUPPORTING ANY BUILDING ELEMENT PRIOR TO DEMOLITION. EXERCISE CARE WHEN REMOVING THE BEAMS SO AS NOT TO DAMAGE ANY ADJACENT CONSTRUCTION. BEAMS APPEAR TO HAVE PREVIOUSLY SUPPORTED CEILING-HUNG TOILET PARTITIONS, BUT ARE NO LONGER IN USE.

DEMOLITION KEY NOTES

D.1	REMOVE EXISTING 4" CMU CHASE WALL (AT ROOMS T,V, & W, EXISTING WALL IS 4" METAL FRAMING)
D.4	REMOVE EXISTING PLUMBING FIXTURE - SEE PLUMBING DWGS
D.5	REMOVE EXISTING COUNTERTOP & SUPPORT FRAMING
D.6	REMOVE EXISTING TOILET/URINAL PARTITIONS
D.7	REMOVE EXISTING WALL-MOUNTED ACCESSORIES
D.8	REMOVE EXISTING CERAMIC FLOOR TILE TO CONCRETE SLAB
D.10	REMOVE EXISTING GWB CEILING, SUPPORT STRUCTURE, & CEILING-MOUNTED DEVICES THROUGHOUT ROOM - SEE MEP DWGS.
D.11	REMOVE EXISTING LIGHT FIXTURES - SEE ELECTRICAL DWGS.
D.13	REMOVE EXISTING DOOR THRESHOLD (ALUMINUM THRESHOLD AT EXHIBIT-TYPE ROOMS; MARBLE THRESHOLD AT SEMINAR-TYPE ROOMS)
D.17	REMOVE EXISTING WALL-MOUNTED SIGNAGE

FRAME TO REMAIN AND RECEIVE NEW DOOR

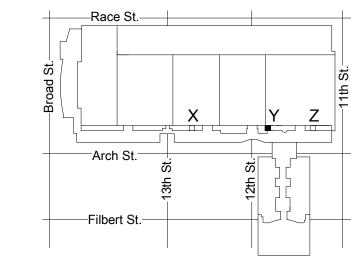

REMOVE EXISTING STEEL BEAM (6" TO 10" DEEP) ABOVE CEILING

REMOVE EXISTING ENTRY DOOR AND HARDWARE - EXISTING HM

KEY PLAN - LEVEL 300



NTS

(SEMINAR) CW1615 Project number

As indicated

8. NEW PLUMBING FIXTURE LOCATIONS DIFFER FROM EXISTING FIXTURE LOCATIONS. FIXTURE CARRIERS AND ASSOCIATED

PLUMBING ARE TO BE RELOCATED TO DIMENSIONS SHOWN ON 9. SEE SHEET A500 FOR ENLARGED PLANS AND ELEVATIONS OF

TYPICAL TOILET COMPARTMENTS AND TYPICAL ACCESSORY

11. SEE A600 SERIES SHEETS FOR REFLECTED CEILING PLANS,

12. SEE OVERALL BUILDING PLANS ON SHEETS A001, A002, & A003 FOR LOCATIONS OF ALL DRINKING FOUNTAINS IN PROJECT.

ACCESSORY/EQUIPMENT LEGEND - SEMINAR-TYPE RESTROOMS

- 3 PAPER TOWEL/TRASH COMBO UNIT AUTO, SEMI-RECESSED (18) MIRROR FULL LENGTH 24" X 72"
- 4 TRASH SEMI-RECESSED WALL MTD.

 - 24 MIRROR DOUBLE WIDTH, WIDE 48" X 54"
 - (25) MIRROR DOUBLE WIDTH, WIDE 48" X 48"

NOTE: SEE SPECIFICATIONS FOR ADDITIONAL INFORMATION.

REVISIONS: Description

CONVERSE WINKLER ARCHITECTURE

331 MONTGOMERY AVE BALA CYNWYD, PA 19144

ARCHITECTS:

Ph: 610.664.0806

Fax: 215.664.1075

MEP ENGINEERS:

ARORA°

Contact: Kevin Sultanik

CSA GROUP

Ph: 215.427.8700

Fax: 215.427.8752

Contact: Wing Au

SUITE 507

Contact: Elin Westrick

e-mail: ewestrick@cwarc.com

P (610) 459-7900 F (610) 459-7950 aroraengineers.com

e-mail: ksultanik@aroraengineers.com

1341 NORTH DELAWARE AVENUE,

STRUCTURAL ENGINEERS:

PHILADELPHIA, PA 19125

e-mail: wau@csagroup.com

Arora Engineers, Inc.

Chadds Ford, PA 19317

CONVERSE WINKLER ARCHITECTURE

331 Montgomery Avenue,

Bala Cynwyd, PA, 19144


/ANIA CENTER

PENNSYLV NVENTION (


CO

DEMOLITION & NEW FLOOR PLANS - ROOM Y

November 25, 2019 Date LC/KR Drawn by ΕW Checked by

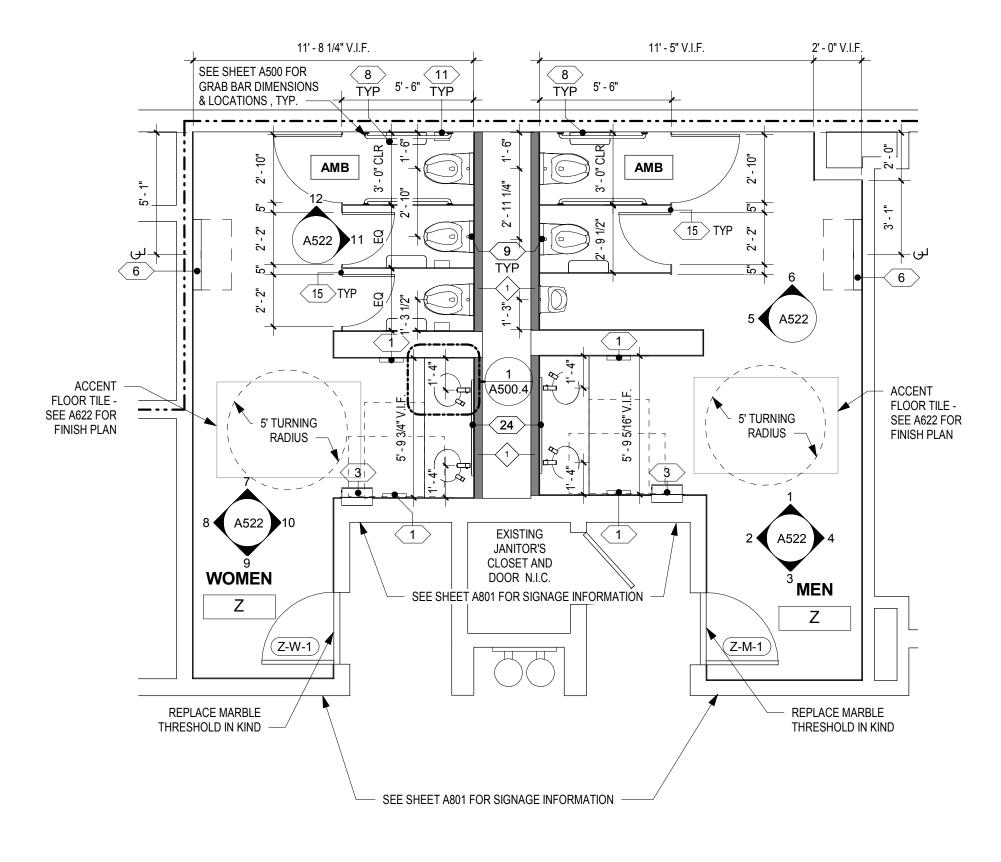

FLOOR PLAN - MEN'S & WOMEN'S ROOM Z

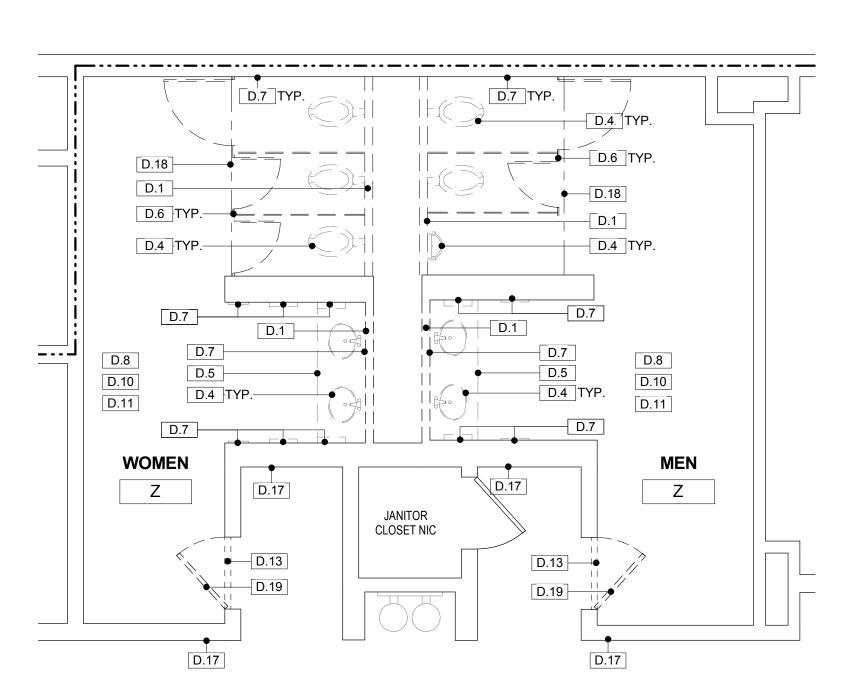

DEMO PLAN - MEN'S & WOMEN'S ROOM Z

A122 SCALE: 1/4" = 1'-0"

- 1. JANITOR CLOSET DOORS, HOLLOW METAL FRAMES, AND HARDWARE ARE TO REMAIN AND TO BE REPAINTED AS SCHEDULED. ENTRY DOORS AT SEMINAR- AND BALLROOM-TYPE ROOMS ARE TO BE REPLACED IN KIND IN EXISTING FRAMES. SEE DOOR SCHEDULE ON A600.1 FOR ADDITIONAL INFORMATION. JANITOR CLOSETS ARE NOT IN CONTRACT, EXCEPT TO REPAINT
- INTERIOR AND EXTERIOR OF DOORS AND FRAMES AND TO PROVIDE NEW DOOR THRESHOLDS.
- 3. CONTRACTOR IS TO VERIFY THE CONDITION OF EXISTING SUBSTRATES TO RECEIVE NEW FINISHES AND CONFIRM SUITABILITY. IF EXISTING FLOORS DO NOT MEET MEET NECESSARY TO ACCOMMODATE FLOOR LEVEL WITHIN ALLOWABLE TOLERANCE.
- PARTITIONS, ACCESSORIES, OR WALLS REMOVED, AND PROVIDE A SOUND AND LEVEL SURFACE TO RECEIVE NEW FINISH.
- TILE IS TO REMAIN ON WALLS TO REMAIN AND NEW SCHEDULED TILE IS TO BE INSTALLED OVER EXISTING TILE. CONTRACTOR TO TOLERANCES FOR SPECIFIED NEW TILE FINISH.

- . NOT USED.
 - GC TO VERIFY THICKNESS OF CERAMIC TILE ASSEMBLY TO BE REMOVED AND ACCOUNT FOR ANY DIFFERENCE IN THICKNESS OF NEW TILE ASSEMBLY.
- NEW PLUMBING FIXTURE LOCATIONS DIFFER FROM EXISTING FIXTURE LOCATIONS. FIXTURE CARRIERS AND ASSOCIATED
- PLUMBING ARE TO BE RELOCATED TO DIMENSIONS SHOWN ON 9. SEE SHEET A500 FOR ENLARGED PLANS AND ELEVATIONS OF
- TYPICAL TOILET COMPARTMENTS AND TYPICAL ACCESSORY MOUNTING HEIGHTS. 10. SEE SHEET A500.1 FOR PARTITION TYPES, NEW WALLS ARE TO
- BE CONSTRUCTED IN THE IN SAME LOCATION AS EXISTING DEMOLISHED WALLS, UNLESS NOTED OTHERWISE. 11. SEE A600 SERIES SHEETS FOR REFLECTED CEILING PLANS,
- FINISH PLANS, AND FINISH SCHEDULES. 12. SEE OVERALL BUILDING PLANS ON SHEETS A001, A002, & A003 FOR LOCATIONS OF ALL DRINKING FOUNTAINS IN PROJECT.

- 6 DIAPER CHANGING STATION SURFACE-MTD. (UNLESS
- 8 TOILET PAPER DISPENSER DUAL JUMBO ROLL (TYP. IN
- (11) SANITARY DISPOSAL (TYP. IN EACH WOMEN'S STALL)
- (15) TOILET PARTITIONS 2 COMPACT HIGH-PRESSURE LAMINATE (PHENOLIC), 81" HIGH INCL 9" SUPPORT LEGS; URINAL SCREENS 20" D X 60" H, WALL-MTD.
- 3 PAPER TOWEL/TRASH COMBO UNIT AUTO, SEMI-RECESSED (18) MIRROR FULL LENGTH 24" X 72"
 - 19 MIRROR DOUBLE WIDTH 42" X 54"
 - 20 MIRROR SINGLE WIDTH 24" X 54"
 - 23 MIRROR SINGLE WIDTH, NARROW 18" X 54"
 - 24 MIRROR DOUBLE WIDTH, WIDE 48" X 54"

NOTE: SEE SPECIFICATIONS FOR ADDITIONAL INFORMATION.




WHEELCHAIR ACCESSIBLE TOILET COMPARTMENT - SEE A500 FOR TYPICAL ENLARGED



AMBULATORY ACCESSIBLE TOILET COMPARTMENT - SEE A500 FOR TYPICAL ENLARGED PLANS AND ELEVATIONS.

NO SYMBOL UNLESS OTHERWISE NOTED, TOILET COMPARTMENTS ARE STANDARD.

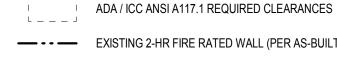

— - - — EXISTING 2-HR FIRE RATED WALL (PER AS-BUILT DRAWINGS) TO REMAIN

PARTITION TYPE - SEE SHEET A500.1

DEMOLITION GENERAL NOTES

- 1. SEE PHOTOS ON SOME SHEETS FOR IMAGES OF
- TYPICAL EXISTING TOILET ROOMS. 2. COORDINATE DEMOLITION SCOPE ITEMS WITH NEW WORK AND MEP DRAWINGS.
- 3. COORDINATE WITH OWNER FOR REMOVED ACCESSORIES, PLUMBING FIXTURES, LIGHTING FIXTURES, CEILING DEVICES, TOILET PARTITIONS, AND SIGNAGE TO BE SALVAGED.
- 4. JANITOR CLOSET DOORS TO REMAIN. PROTECT DURING CONSTRUCTION.
- 5. FOR STEEL BEAMS INDICATED TO BE REMOVED, GC TO VERIFY THAT BEAMS ARE NOT SUPPORTING ANY BUILDING ELEMENT PRIOR TO DEMOLITION. EXERCISE CARE WHEN REMOVING THE BEAMS SO AS NOT TO DAMAGE ANY ADJACENT CONSTRUCTION. BEAMS APPEAR TO HAVE PREVIOUSLY SUPPORTED CEILING-HUNG TOILET PARTITIONS, BUT ARE NO LONGER IN USE.


DEMOLITION KEY NOTES REMOVE EXISTING 4" CMU CHASE WALL (AT ROOMS T.V. & W.

REMOVE EXISTING PLUMBING FIXTURE - SEE PLUMBING DWGS REMOVE EXISTING COUNTERTOP & SUPPORT FRAMING REMOVE EXISTING TOILET/URINAL PARTITIONS REMOVE EXISTING WALL-MOUNTED ACCESSORIES REMOVE EXISTING CERAMIC FLOOR TILE TO CONCRETE SLAB REMOVE EXISTING GWB CEILING, SUPPORT STRUCTURE, & CEILING-MOUNTED DEVICES THROUGHOUT ROOM - SEE MEP REMOVE EXISTING LIGHT FIXTURES - SEE ELECTRICAL DWGS. REMOVE EXISTING DOOR THRESHOLD (ALUMINUM THRESHOLD AT EXHIBIT-TYPE ROOMS; MARBLE THRESHOLD AT SEMINAR-TYPE

REMOVE EXISTING WALL-MOUNTED SIGNAGE

FRAME TO REMAIN AND RECEIVE NEW DOOR

EXISTING WALL IS 4" METAL FRAMING)

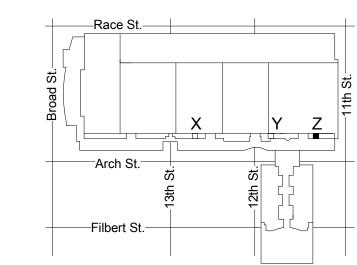

REMOVE EXISTING STEEL BEAM (6" TO 10" DEEP) ABOVE CEILING

REMOVE EXISTING ENTRY DOOR AND HARDWARE - EXISTING HM

NTS KEY PLAN - LEVEL 300



Checked by

Project number

Drawn by

CONVERSE WINKLER ARCHITECTURE

331 MONTGOMERY AVE BALA CYNWYD, PA 19144

ARCHITECTS:

ARCHITECTURE

Ph: 610.664.0806

Fax: 215.664.1075

MEP ENGINEERS:

ARORA°

Contact: Kevin Sultanik

CSA GROUP

Ph: 215.427.8700

Fax: 215.427.8752

Contact: Wing Au

REVISIONS:

/ANIA CENTER

PENNSYLV NVENTION (

0

DEMOLITION &

NEW FLOOR

PLANS - ROOM Z

(SEMINAR)

Description

SUITE 507

STRUCTURAL ENGINEERS:

PHILADELPHIA, PA 19125

e-mail: wau@csagroup.com

Contact: Elin Westrick

e-mail: ewestrick@cwarc.com

P (610) 459-7900 F (610) 459-7950 aroraengineers.com

e-mail: ksultanik@aroraengineers.com

1341 NORTH DELAWARE AVENUE,

Arora Engineers, Inc.

Chadds Ford, PA 19317

CONVERSE WINKLER

331 Montgomery Avenue,

Bala Cynwyd, PA, 19144

As indicated

November 25, 2019

CW1615

KR/LC

ΕW

DRAWING GENERAL NOTES

- ALLOWABLE TOLERANCES PER ANSI STANDARDS FOR LARGE-FORMAT TILE, FLASH FLOORS TO LEVEL. SCRIBE WALL TILE AS
- 4. INFILL AND/OR PATCH FLOORS AND WALLS WHERE TOILET
- 5. IN SEMINAR/BALLROOM TYPE ROOMS, EXISTING CERAMIC WALL VERIFY THAT LEVELNESS OF SURFACE IS WITHIN REQUIRED

ACCESSORY/EQUIPMENT LEGEND - SEMINAR-TYPE RESTROOMS

- 1 HAND DRYER SEMI-RECESSED
- 2 PAPER TOWEL DISPENSER AUTO, SEMI-RECESSED
- 4 TRASH SEMI-RECESSED WALL MTD.
- OTHERWISE NOTED)
- EACH STALL)
- 9 SEAT COVER DISPENSER (TYP. IN EACH STALL)
- 25 MIRROR DOUBLE WIDTH, WIDE 48" X 48"

JANITOR

CLOSET

● D.5

• D.4 TYP.

D.7

WHEELCHAIR ACCESSIBLE TOILET COMPARTMENT - SEE A500 FOR TYPICAL ENLARGED PLANS AND ELEVATIONS.

AMBULATORY ACCESSIBLE TOILET COMPARTMENT - SEE A500 FOR TYPICAL ENLARGED PLANS AND ELEVATIONS.

NO SYMBOL UNLESS OTHERWISE NOTED, TOILET COMPARTMENTS ARE STANDARD.

ADA / ICC ANSI A117.1 REQUIRED CLEARANCES

--- EXISTING 2-HR FIRE RATED WALL (PER AS-BUILT DRAWINGS) TO REMAIN

PARTITION TYPE - SEE SHEET A500.1

ACCESSORY/EQUIPMENT LEGEND -BALLROOM-TYPE RESTROOMS

- 1 HAND DRYER SEMI-RECESSED
- 2 PAPER TOWEL DISPENSER AUTO, SEMI-RECESSED 3 PAPER TOWEL/TRASH COMBO UNIT - AUTO, SEMI-RECESSED
- 4 TRASH SEMI-RECESSED WALL MTD.
- OTHERWISE NOTED) 7 NAPKIN/TAMPON VENDOR (1 PER WOMEN'S ROOM)
- (8) TOILET PAPER DISPENSER DUAL JUMBO ROLL (TYP. IN

6 DIAPER CHANGING STATION - SURFACE-MTD. (UNLESS

- EACH STALL) 9 SEAT COVER DISPENSER (TYP. IN EACH STALL)
- (11) SANITARY DISPOSAL (TYP. IN EACH WOMEN'S STALL)
- 15 TOILET PARTITIONS 2 COMPACT HIGH-PRESSURE LAMINATE (PHENOLIC), 81" HIGH INCL 9" SUPPORT LEGS; URINAL SCREENS 20" D X 60" H, WALL-MTD.
- 18 MIRROR FULL LENGTH 24" X 72"
- 19 MIRROR DOUBLE WIDTH 42" X 54"
- 20 MIRROR SINGLE WIDTH 24" X 54"
- (21) MIRROR SINGLE WIDTH WITH INTEGRAL LED BACKLIGHT -24" X 54" - SEE ELECT. DWGS.

- JANITOR

CLOSET

N.I.C.

D.2

D.5

D.7 TYP.

D.3 D.7 TYP.

D.13

D.4 TYP.

D.6 TYP.

_ D.13 — 🚽

← D.5

D.4 TYP.

■ D.6 TYP.

D.7 TYP.

D.8

D.10

D.11

- EXISTING VESTIBULE N.I.C.

D.4 TYP.

D.7 TYP.

D.2

D.1

D.7 TYP.

D.4 TYP.-

D.6 TYP.

D.8

D.18

D.4 TYP.

- 23 MIRROR SINGLE WIDTH, NARROW 18" X 54"
- 24 MIRROR DOUBLE WIDTH, WIDE 48" X 54"
- NOTE: SEE SPECIFICATIONS FOR ADDITIONAL INFORMATION.

DRAWING GENERAL NOTES

- 1. JANITOR CLOSET DOORS, HOLLOW METAL FRAMES, AND HARDWARE ARE TO REMAIN AND TO BE REPAINTED AS SCHEDULED. ENTRY DOORS AT SEMINAR- AND BALLROOM-TYPE ROOMS ARE TO BE REPLACED IN KIND IN EXISTING FRAMES. SEE DOOR SCHEDULE ON A600.1 FOR ADDITIONAL INFORMATION.
- 2. JANITOR CLOSETS ARE NOT IN CONTRACT, EXCEPT TO REPAINT INTERIOR AND EXTERIOR OF DOORS AND FRAMES AND TO PROVIDE NEW DOOR THRESHOLDS.

CONVERSE WINKLER ARCHITECTURE

331 MONTGOMERY AVE BALA CYNWYD, PA 19144

ARCHITECTS:

ARCHITECTURE

Ph: 610.664.0806

Fax: 215.664.1075

MEP ENGINEERS:

ARORA°

Contact: Kevin Sultanik

CSA GROUP

Ph: 215.427.8700

Fax: 215.427.8752

Contact: Wing Au

REVISIONS:

/ANIA CENTER

PENNSYLVA NVENTION (

 $\frac{1}{2}$

DEMOLITION &

NEW FLOOR

PLANS - ROOM

A1 (BALLROOM)

RESTROOM RENOVATIONS

CW1615

KR/LC

EW

Description

SUITE 507

STRUCTURAL ENGINEERS:

PHILADELPHIA, PA 19125

e-mail: wau@csagroup.com

Contact: Elin Westrick

e-mail: ewestrick@cwarc.com

P (610) 459-7900 | F (610) 459-7950 | aroraengineers.com

e-mail: ksultanik@aroraengineers.com

1341 NORTH DELAWARE AVENUE,

Arora Engineers, Inc.

Chadds Ford, PA 19317

CONVERSE WINKLER

331 Montgomery Avenue,

Bala Cynwyd, PA, 19144

- 3. CONTRACTOR IS TO VERIFY THE CONDITION OF EXISTING SUBSTRATES TO RECEIVE NEW FINISHES AND CONFIRM SUITABILITY. IF EXISTING FLOORS DO NOT MEET MEET ALLOWABLE TOLERANCES PER ANSI STANDARDS FOR LARGE-FORMAT TILE. FLASH FLOORS TO LEVEL. SCRIBE WALL TILE AS NECESSARY TO ACCOMMODATE FLOOR LEVEL WITHIN ALLOWABLE TOLERANCE.
- 4. INFILL AND/OR PATCH FLOORS AND WALLS WHERE TOILET PARTITIONS, ACCESSORIES, OR WALLS REMOVED, AND PROVIDE A SOUND AND LEVEL SURFACE TO RECEIVE NEW FINISH.
- 5. IN SEMINAR/BALLROOM TYPE ROOMS, EXISTING CERAMIC WALL TILE IS TO REMAIN ON WALLS TO REMAIN AND NEW SCHEDULED TILE IS TO BE INSTALLED OVER EXISTING TILE. CONTRACTOR TO VERIFY THAT LEVELNESS OF SURFACE IS WITHIN REQUIRED TOLERANCES FOR SPECIFIED NEW TILE FINISH.
- 6. NOT USED. 7. GC TO VERIFY THICKNESS OF CERAMIC TILE ASSEMBLY TO BE REMOVED AND ACCOUNT FOR ANY DIFFERENCE IN THICKNESS OF NEW TILE ASSEMBLY.
- 8. NEW PLUMBING FIXTURE LOCATIONS DIFFER FROM EXISTING FIXTURE LOCATIONS. FIXTURE CARRIERS AND ASSOCIATED PLUMBING ARE TO BE RELOCATED TO DIMENSIONS SHOWN ON
- DRAWINGS. 9. SEE SHEET A500 FOR ENLARGED PLANS AND ELEVATIONS OF TYPICAL TOILET COMPARTMENTS AND TYPICAL ACCESSORY MOUNTING HEIGHTS.
- 10. SEE SHEET A500.1 FOR PARTITION TYPES. NEW WALLS ARE TO BE CONSTRUCTED IN THE IN SAME LOCATION AS EXISTING DEMOLISHED WALLS, UNLESS NOTED OTHERWISE. 11. SEE A600 SERIES SHEETS FOR REFLECTED CEILING PLANS, FINISH PLANS. AND FINISH SCHEDULES.
- 12. SEE OVERALL BUILDING PLANS ON SHEETS A001, A002, & A003 FOR LOCATIONS OF ALL DRINKING FOUNTAINS IN PROJECT.

DEMOLITION GENERAL NOTES

- TYPICAL EXISTING TOILET ROOMS.
- WORK AND MEP DRAWINGS.
- 3. COORDINATE WITH OWNER FOR REMOVED ACCESSORIES, PLUMBING FIXTURES, LIGHTING FIXTURES, CEILING DEVICES, TOILET PARTITIONS,
- AND SIGNAGE TO BE SALVAGED. 4. JANITOR CLOSET DOORS TO REMAIN. PROTECT
- 5. FOR STEEL BEAMS INDICATED TO BE REMOVED. GC TO VERIFY THAT BEAMS ARE NOT SUPPORTING ANY BUILDING ELEMENT PRIOR TO DEMOLITION. EXERCISE CARE WHEN REMOVING THE BEAMS SO AS NOT TO DAMAGE ANY ADJACENT CONSTRUCTION, BEAMS APPEAR TO HAVE PREVIOUSLY SUPPORTED CEILING-HUNG TOILET PARTITIONS, BUT ARE NO LONGER IN USE.

REMOVE EXISTING 4" CMU CHASE WALL (AT ROOMS T,V, & W, **EXISTING WALL IS 4" METAL FRAMING)** REMOVE EXISTING 4" PARTIAL HEIGHT CHASE WALI REMOVE PORTION OF EXISTING WALL REMOVE EXISTING PLUMBING FIXTURE - SEE PLUMBING DWGS REMOVE EXISTING COUNTERTOP & SUPPORT FRAMING REMOVE EXISTING TOILET/URINAL PARTITIONS REMOVE EXISTING WALL-MOUNTED ACCESSORIES REMOVE EXISTING CERAMIC FLOOR TILE TO CONCRETE SLAB REMOVE EXISTING GWB CEILING, SUPPORT STRUCTURE, & CEILING-MOUNTED DEVICES THROUGHOUT ROOM - SEE MEP REMOVE EXISTING LIGHT FIXTURES - SEE ELECTRICAL DWGS. EXHIBIT-TYPE ROOMS; MARBLE THRESHOLD AT SEMINAR-TYPE

> -Race St.-Arch St.

KEY PLAN - BALLROOM LEVEL


1. SEE PHOTOS ON SOME SHEETS FOR IMAGES OF

- 2. COORDINATE DEMOLITION SCOPE ITEMS WITH NEW

- DURING CONSTRUCTION.

DEMOLITION KEY NOTES

REMOVE EXISTING DOOR THRESHOLD (ALUMINUM THRESHOLD AT REMOVE EXISTING WALL-MOUNTED SIGNAGE REMOVE EXISTING STEEL BEAM (6" TO 10" DEEP) ABOVE CEILING REMOVE EXISTING ENTRY DOOR AND HARDWARE - EXISTING HM FRAME TO REMAIN AND RECEIVE NEW DOOR

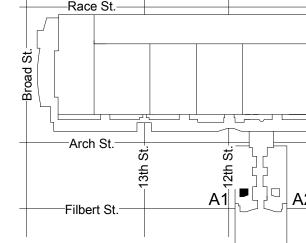

7 FLOOR PLAN - MEN'S & WOMEN'S ROOM A1

- CHANGING TABLE TO BE RECESSED IN

EXISTING WALL IN THIS LOCATION

NEW PARTIAL

HEIGHT WALL

IN EXISTING

LOCATION

5' - 6"

SEE SHEET A801 FOR SIGNAGE INFORMATION

EXISTING VESTIBULE N.I.C.

EXCEPT AS NOTED

REPLACE MARBLE

THRESHOLD IN KIND

QUARTZ

BACKSPLASH

PARTIAL

〈21〉

21

4 \ \ 1

(→ → HEIGHT WALL

(A1-M-1)

MEN

Α1

- 5' TURNING

RANGE FAUCET AND -

SOAP DISPENSER AT

THIS LOCATION - SEE

ACCENT FLOOR

TILE - SEE A623

FOR FINISH PLAN

AMB

PATCH FLOOR

WHERE WALL

CHASE WALL IN

EXISTING LOCATION

REMOVED

5

SHEET A500.5

RADIUS

(A1-W-1)

Α1

A500.4

AMB

ACCENT FLOOR

TILE - SEE A623

FOR FINISH PLAN

5' TURNING

A523

JANITOR'S CLOSET

N.I.C.

(4)

BACKSPLASH &

HEIGHT WALL

LEDGE ON PARTIAL

NEW PARTIAL

HEIGHT CHASE

LOCATION

CHANGING TABLE

TO BE RECESSED

THIS LOCATION

IN NEW WALL

WALL IN EXISTING

TOILET PARTITIONS NOTCHED OVER

LEDGE OF PARTIAL

HEIGHT WALL, TYP.

A123 SCALE: 1/4" = 1'-0"

✓ TYP

5' - 6"

JANITOR'S CLOSET

QUARTZ

LEDGE ON

PARTIAL

BACKSPLASH &

HEIGHT WALL

TOILET PARTITIONS =

NOTCHED OVER

TILED LEDGE AT

TOP OF WALL

NEW PARTIAL

CHASE WALL

IN EXISTING

LOCATION

HEIGHT

LEDGE OF PARTIAL

HEIGHT WALL, TYP.

DEMO PLAN - MEN'S & WOMEN'S ROOM A1

A123 SCALE: 1/4" = 1'-0"

● D.2

D.7 TYP.



Project number November 25, 2019 Drawn by Checked by A123 As indicated

WHEELCHAIR ACCESSIBLE TOILET COMPARTMENT - SEE A500 FOR TYPICAL ENLARGED PLANS AND ELEVATIONS.

JANITOR'S

CLOSET N.I.C.

● D.2

● D.13

D.8

D.10

D.11

← D.18

• D.3

D.4 TYP.

D.7 TYP.

D.4 TYP.

D.6 TYP.—●

D.4 TYP.—

D.1

AMBULATORY ACCESSIBLE TOILET COMPARTMENT - SEE A500 FOR TYPICAL ENLARGED PLANS AND ELEVATIONS.

NO SYMBOL UNLESS OTHERWISE NOTED, TOILET COMPARTMENTS ARE STANDARD.

ADA / ICC ANSI A117.1 REQUIRED CLEARANCES

--- EXISTING 2-HR FIRE RATED WALL (PER AS-BUILT DRAWINGS) TO REMAIN

PARTITION TYPE - SEE SHEET A500.1

ACCESSORY/EQUIPMENT LEGEND -BALLROOM-TYPE RESTROOMS

- 1 HAND DRYER SEMI-RECESSED
- 2 PAPER TOWEL DISPENSER AUTO, SEMI-RECESSED
- 3 PAPER TOWEL/TRASH COMBO UNIT AUTO, SEMI-RECESSED
- 4 TRASH SEMI-RECESSED WALL MTD.
- 6 DIAPER CHANGING STATION SURFACE-MTD. (UNLESS OTHERWISE NOTED)
- 7 NAPKIN/TAMPON VENDOR (1 PER WOMEN'S ROOM)
- 8 TOILET PAPER DISPENSER DUAL JUMBO ROLL (TYP. IN EACH STALL)
- 9 SEAT COVER DISPENSER (TYP. IN EACH STALL) 11 SANITARY DISPOSAL (TYP. IN EACH WOMEN'S STALL)
- 15 TOILET PARTITIONS 2 COMPACT HIGH-PRESSURE LAMINATE (PHENOLIC), 81" HIGH INCL 9" SUPPORT LEGS; URINAL SCREENS 20" D X 60" H, WALL-MTD.
- 18 MIRROR FULL LENGTH 24" X 72"
- 19 MIRROR DOUBLE WIDTH 42" X 54"
- 20 MIRROR SINGLE WIDTH 24" X 54"
- (21) MIRROR SINGLE WIDTH WITH INTEGRAL LED BACKLIGHT -24" X 54" - SEE ELECT. DWGS.

JANITOR'S

CLOSET N.I.C.

D.4 TYP.

D.7 TYP.—

D.13

D.10

D.11

D.6 TYP.

D.4 TYP.

D.13

D.17

● D.5

D.7 TYP.

- 23 MIRROR SINGLE WIDTH, NARROW 18" X 54"
- (24) MIRROR DOUBLE WIDTH, WIDE 48" X 54" NOTE: SEE SPECIFICATIONS FOR ADDITIONAL INFORMATION.

DRAWING GENERAL NOTES

- 1. JANITOR CLOSET DOORS, HOLLOW METAL FRAMES, AND HARDWARE ARE TO REMAIN AND TO BE REPAINTED AS SCHEDULED. ENTRY DOORS AT SEMINAR- AND BALLROOM-TYPE ROOMS ARE TO BE REPLACED IN KIND IN EXISTING FRAMES. SEE DOOR SCHEDULE ON A600.1 FOR ADDITIONAL INFORMATION.
- JANITOR CLOSETS ARE NOT IN CONTRACT, EXCEPT TO REPAINT INTERIOR AND EXTERIOR OF DOORS AND FRAMES AND TO PROVIDE NEW DOOR THRESHOLDS.
- 3. CONTRACTOR IS TO VERIFY THE CONDITION OF EXISTING SUBSTRATES TO RECEIVE NEW FINISHES AND CONFIRM SUITABILITY. IF EXISTING FLOORS DO NOT MEET MEET ALLOWABLE TOLERANCES PER ANSI STANDARDS FOR LARGE-FORMAT TILE, FLASH FLOORS TO LEVEL. SCRIBE WALL TILE AS NECESSARY TO ACCOMMODATE FLOOR LEVEL WITHIN ALLOWABLE TOLERANCE.

CONVERSE WINKLER ARCHITECTURE

331 MONTGOMERY AVE BALA CYNWYD, PA 19144

ARCHITECTS:

ARCHITECTURE

Ph: 610.664.0806

Fax: 215.664.1075

MEP ENGINEERS:

Contact: Kevin Sultanik

CSA GROUP

Ph: 215.427.8700

Fax: 215.427.8752

Contact: Wing Au

REVISIONS:

Description

RESTROOM RENOVATIONS

CW1615

LC/KR

As indicated

SUITE 507

STRUCTURAL ENGINEERS:

PHILADELPHIA, PA 19125

e-mail: wau@csagroup.com

Contact: Elin Westrick

e-mail: ewestrick@cwarc.com

P (610) 459-7900 | F (610) 459-7950 | aroraengineers.com

e-mail: ksultanik@aroraengineers.com

1341 NORTH DELAWARE AVENUE,

Arora Engineers, Inc.

Chadds Ford, PA 19317

CONVERSE WINKLER


331 Montgomery Avenue,

Bala Cynwyd, PA, 19144

- 4. INFILL AND/OR PATCH FLOORS AND WALLS WHERE TOILET PARTITIONS, ACCESSORIES, OR WALLS REMOVED, AND PROVIDE A SOUND AND LEVEL SURFACE TO RECEIVE NEW FINISH.
- 5. IN SEMINAR/BALLROOM TYPE ROOMS, EXISTING CERAMIC WALL TILE IS TO REMAIN ON WALLS TO REMAIN AND NEW SCHEDULED TILE IS TO BE INSTALLED OVER EXISTING TILE. CONTRACTOR TO VERIFY THAT LEVELNESS OF SURFACE IS WITHIN REQUIRED TOLERANCES FOR SPECIFIED NEW TILE FINISH.
- NOT USED. 7. GC TO VERIFY THICKNESS OF CERAMIC TILE ASSEMBLY TO BE REMOVED AND ACCOUNT FOR ANY DIFFERENCE IN THICKNESS OF NEW TILE ASSEMBLY
- 8. NEW PLUMBING FIXTURE LOCATIONS DIFFER FROM EXISTING FIXTURE LOCATIONS. FIXTURE CARRIERS AND ASSOCIATED PLUMBING ARE TO BE RELOCATED TO DIMENSIONS SHOWN ON DRAWINGS
- 9. SEE SHEET A500 FOR ENLARGED PLANS AND ELEVATIONS OF TYPICAL TOILET COMPARTMENTS AND TYPICAL ACCESSORY MOUNTING HEIGHTS.
- 10. SEE SHEET A500.1 FOR PARTITION TYPES. NEW WALLS ARE TO BE CONSTRUCTED IN THE IN SAME LOCATION AS EXISTING DEMOLISHED WALLS, UNLESS NOTED OTHERWISE. 11. SEE A600 SERIES SHEETS FOR REFLECTED CEILING PLANS,
- FINISH PLANS, AND FINISH SCHEDULES. 12. SEE OVERALL BUILDING PLANS ON SHEETS A001, A002, & A003 FOR LOCATIONS OF ALL DRINKING FOUNTAINS IN PROJECT.

DEMOLITION GENERAL NOTES

- 1. SEE PHOTOS ON SOME SHEETS FOR IMAGES OF
- 2. COORDINATE DEMOLITION SCOPE ITEMS WITH NEW
- 3. COORDINATE WITH OWNER FOR REMOVED ACCESSORIES, PLUMBING FIXTURES, LIGHTING FIXTURES, CEILING DEVICES, TOILET PARTITIONS,
- 4. JANITOR CLOSET DOORS TO REMAIN. PROTECT DURING CONSTRUCTION. 5. FOR STEEL BEAMS INDICATED TO BE REMOVED, GC TO VERIFY THAT BEAMS ARE NOT SUPPORTING ANY BUILDING ELEMENT PRIOR TO DEMOLITION. EXERCISE CARE WHEN REMOVING THE BEAMS SO

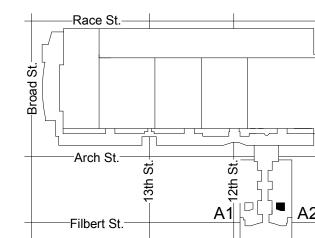

REMOVE EXISTING STEEL BEAM (6" TO 10" DEEP) ABOVE CEILING

REMOVE EXISTING ENTRY DOOR AND HARDWARE - EXISTING HM FRAME TO REMAIN AND RECEIVE NEW DOOR

KEY PLAN - BALLROOM LEVEL


TYPICAL EXISTING TOILET ROOMS.

- WORK AND MEP DRAWINGS.
- AND SIGNAGE TO BE SALVAGED.
- AS NOT TO DAMAGE ANY ADJACENT CONSTRUCTION. BEAMS APPEAR TO HAVE PREVIOUSLY SUPPORTED CEILING-HUNG TOILET

PARTITIONS, BUT ARE NO LONGER IN USE.

D.1	REMOVE EXISTING 4" CMU CHASE WALL (AT ROOMS T,V, & W, EXISTING WALL IS 4" METAL FRAMING)
D.2	REMOVE EXISTING 4" PARTIAL HEIGHT CHASE WALL
D.3	REMOVE PORTION OF EXISTING WALL
D.4	REMOVE EXISTING PLUMBING FIXTURE - SEE PLUMBING DWGS
D.5	REMOVE EXISTING COUNTERTOP & SUPPORT FRAMING
D.6	REMOVE EXISTING TOILET/URINAL PARTITIONS
D.7	REMOVE EXISTING WALL-MOUNTED ACCESSORIES
D.8	REMOVE EXISTING CERAMIC FLOOR TILE TO CONCRETE SLAB
D.10	REMOVE EXISTING GWB CEILING, SUPPORT STRUCTURE, & CEILING-MOUNTED DEVICES THROUGHOUT ROOM - SEE MEP DWGS.
D.11	REMOVE EXISTING LIGHT FIXTURES - SEE ELECTRICAL DWGS.
D.13	REMOVE EXISTING DOOR THRESHOLD (ALUMINUM THRESHOLD AT EXHIBIT-TYPE ROOMS; MARBLE THRESHOLD AT SEMINAR-TYPE ROOMS)
D.17	REMOVE EXISTING WALL-MOUNTED SIGNAGE

DEMOLITION KEY NOTES

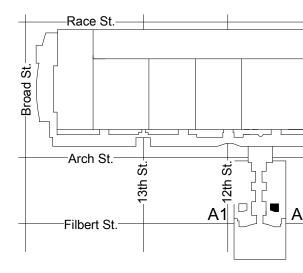

Project number November 25, 2019 Checked by A124

DEMOLITION &

NEW FLOOR

PLANS - ROOM

A2 (BALLROOM)

PENNSYLVANIA CONVENTION CENT

FLOOR PLAN - MEN'S & WOMEN'S ROOM A2 A124 SCALE: 1/4" = 1'-0"

WHERE WALL REMOVED @

NEW CHASE WALL

IN SAME LOCATION

AS EXISTING

SEE SHEET A801 FOR SIGNAGE INFORMATION

EXISTING VESTIBULE N.I.C. EXCEPT AS NOTED

REPLACE MARBLE

THRESHOLD IN KIND

QUARTZ

BACKSPLASH

& LEDGE ON

PARTIAL

HEIGHT WALL

 $\langle 1 \rangle \langle 4 \rangle$

(A2-M-1)

5' TURNING

RADIUS

ACCENT FLOOR

TILE - SEE A623

FOR FINISH PLAN

AMB

5' - 6"

JANITOR'S CLOSET

QUARTZ

LEDGE ON

PARTIAL **HEIGHT WALL**

BACKSPLASH &

TOILET PARTITIONS

LEDGE OF PARTIAL HEIGHT WALL, TYP.

NOTCHED OVER

TILED LEDGE AT

TOP OF WALL

NEW PARTIAL

HEIGHT CHASE WALL IN EXISTING

CHANGING TABLE TO BE

WALL IN THIS LOCATION

RECESSED IN NEW

LOCATION

(18)

WOMEN

5' TURNING

ENHANCED REACH

RANGE FAUCET AND

SOAP DISPENSER AT THIS LOCATION - SEE

SHEET A500.5

TILE - SEE A623

FOR FINISH PLAN

AMB

5' - 6"

RADIUS

A524

NEW PARTIAL

HEIGHT WALL

IN EXISTING

LOCATION

5' - 6"

JANITOR'S CLOSET

QUARTZ

BACKSPLASH &

LEDGE ON PARTIAL

NEW PARTIAL

HEIGHT WALL

CHANGING TABLE TO BE


IN THIS LOCATION

RECESSED IN EXISTING WALL

(A2-W-1)


1 DEMO PLAN - MEN'S & WOMEN'S ROOM A2

A124 SCALE: 1/4" = 1'-0"

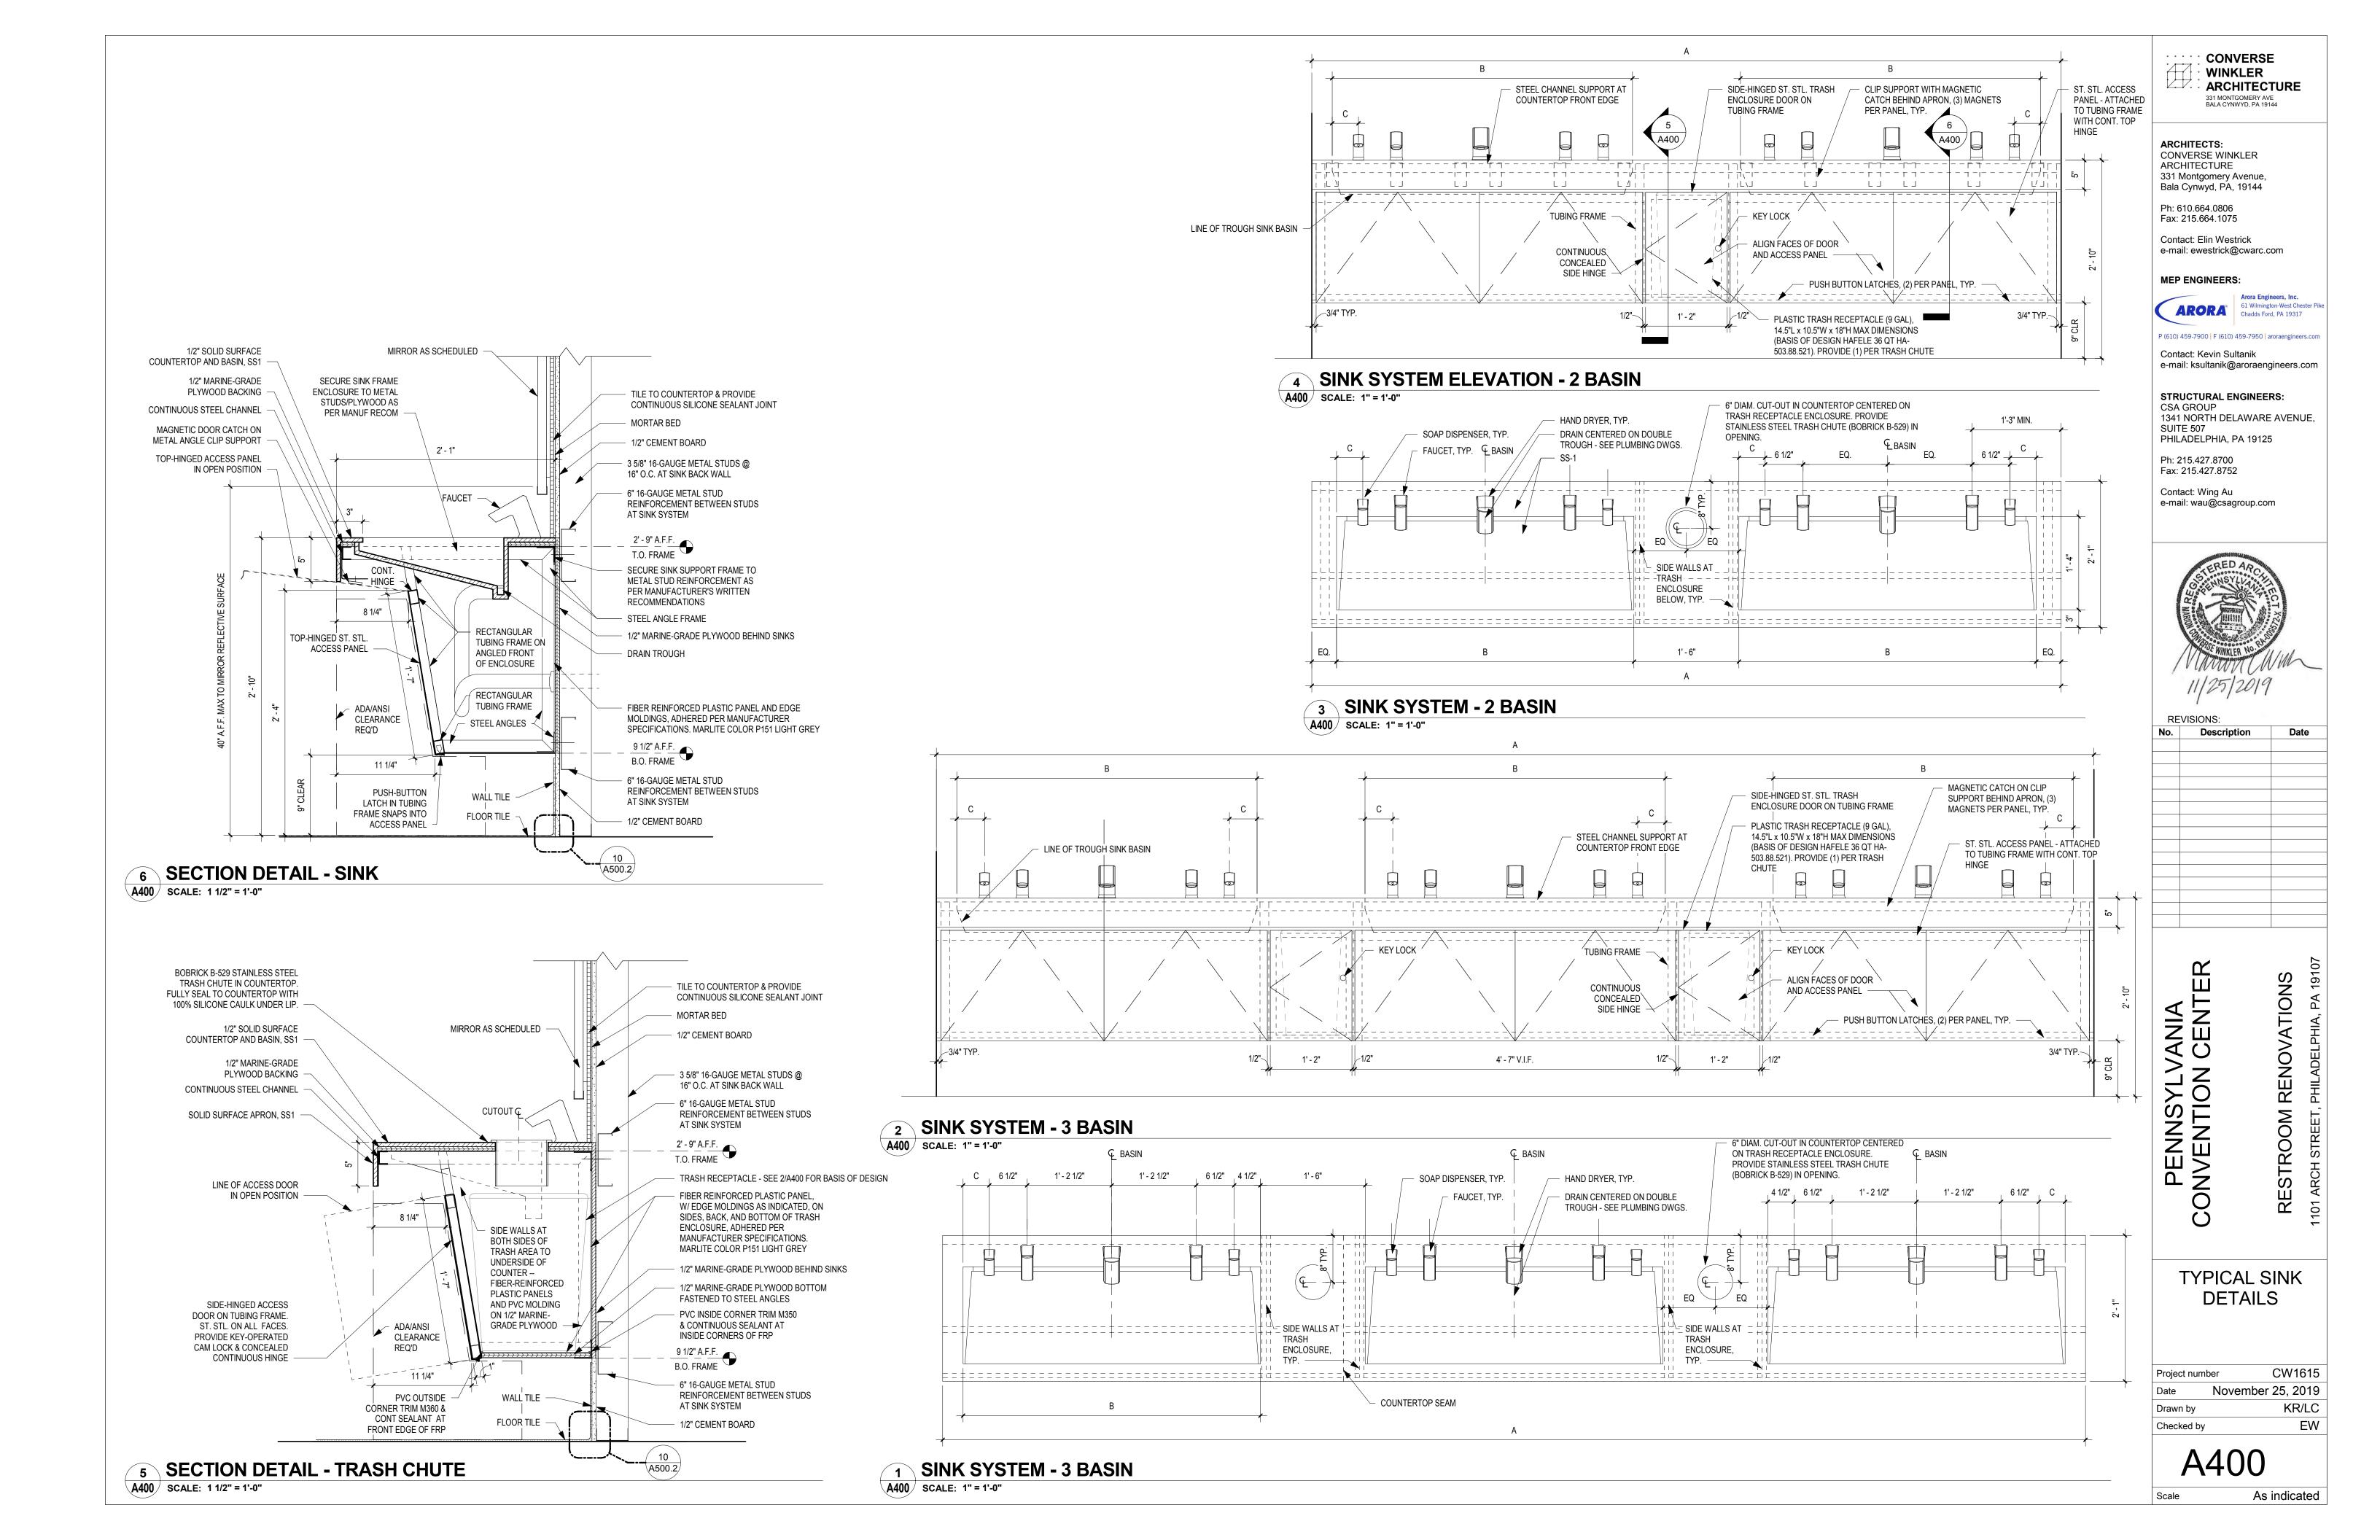


		TROUGH SINK CO	NFIGURA	TIONS SCHE	EDULE (EXF	IIBIT HALL-TYP	E RESTROOM	S)
Room Letter	Room Name	Countertop Length V.I.F. (A)	Basin Length (B)	Soap Location (C)	No. of Basins	No. Trash Enclosures	Detail Reference	Enhanced Reach Side
F	MEN	10' - 3"	3' - 11"	4 1/2"	2	1	5/A400	
F	WOMEN	17' - 2 1/2"	4' - 3"	4 1/2"	3	2	1/A400	RIGHT (DTL 7/A401)
G	MEN	5' - 0 1/2"	4' - 3"	3 1/2"	1	0	3/A401	
G	WOMEN	5' - 0 1/4"	4' - 3"	3 1/2"	1	0	3/A401	
Н	MEN	5' - 0 3/4"	4' - 3"	3 1/2"	1	0	3/A401	
Н	WOMEN	5' - 0 1/4"	4' - 3"	3 1/2"	1	0	3/A401	
J	MEN	14' - 10"	3' - 8"	4 1/2"	2	1	5/A400	RIGHT (DTL 7/A401)
J	MEN	10' - 2"	3' - 11"	4 1/2"	3	2	1/A400	
J	WOMEN	14' - 8 1/2"	3' - 8"	4 1/2"	2	1	5/A400	LEFT (DTL 7/A401)
J	WOMEN	10' - 0 3/4"	3' - 11"	4 1/2"	3	2	1/A400	
K	MEN	6' - 6 3/4"	4' - 3"	4 1/2"	1	1	2/A401	RIGHT (DTL 7/A401)
K	MEN	11' - 2 1/4"	4' - 3"	4 1/2"	2	1	5/A400	
K	WOMEN	6' - 8 3/4"	4' - 3"	4 1/2"	1	1	2/A401	LEFT (DTL 7/A401)
K	WOMEN	11' - 3 5/8"	4' - 3"	4 1/2"	2	1	5/A400	
N	WOMEN	12' - 10"	4' - 3"	4 1/2"	2	1	5/A400	
Ο	MEN	12' - 9"	4' - 3"	4 1/2"	2	1	5/A400	
Р	MEN	15' - 6 1/2"	3' - 11"	4 1/2"	2	1	5/A400	LEFT (DTL 7/A401)
Р	MEN	10' - 11 1/2"	4' - 3"	4 1/2"	3	2	1/A400	
Р	WOMEN	10' - 8 1/2"	4' - 3"	4 1/2"	2	1	5/A400	RIGHT (DTL 7/A401)
Р	WOMEN	15' - 4 3/4"	3' - 11"	5"	3	2	1/A400	
Q	MEN	11' - 6 3/4"	4' - 3"	4 1/2"	2	1	3/A400	
Q	WOMEN	8' - 11 1/2"	6' - 9"	4"	1-TRIPLE	1	1/A401	
R	MEN	11' - 6 1/2"	4' - 3"	4 1/2"	2	1	3/A400	
R	WOMEN	8' - 9 3/4"	6' - 9"	4"	1-TRIPLE	1	1/A401	
S	MEN	11' - 6 3/4"	4' - 3"	4 1/2"	2	1	3/A400	
S	WOMEN	8' - 9 1/2"	6' - 9"	4"	1-TRIPLE	1	1/A401	


NOTES: ONE ENHANCED REACH STATION REQUIRED PER ROOM WITH 6 OR MORE FAUCETS. SEE FLOOR PLANS AND SCHEDULE FOR LOCATIONS.

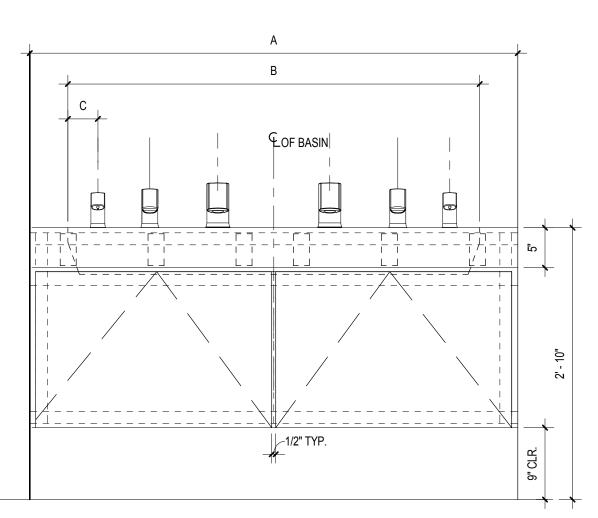


6 SINK SYSTEM ELEVATION - 1 BASIN

A401 SCALE: 1" = 1'-0"

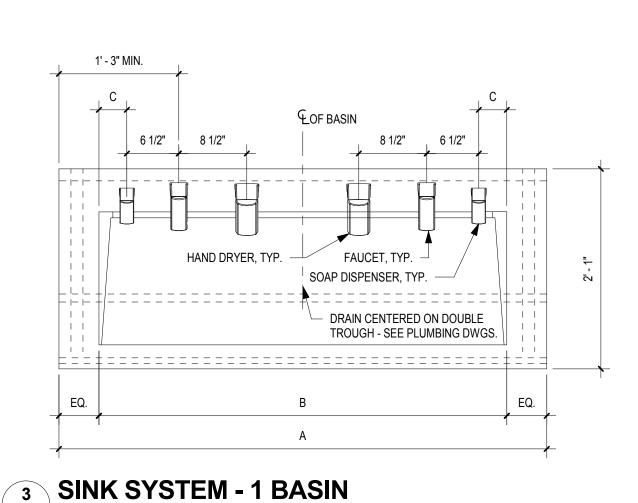

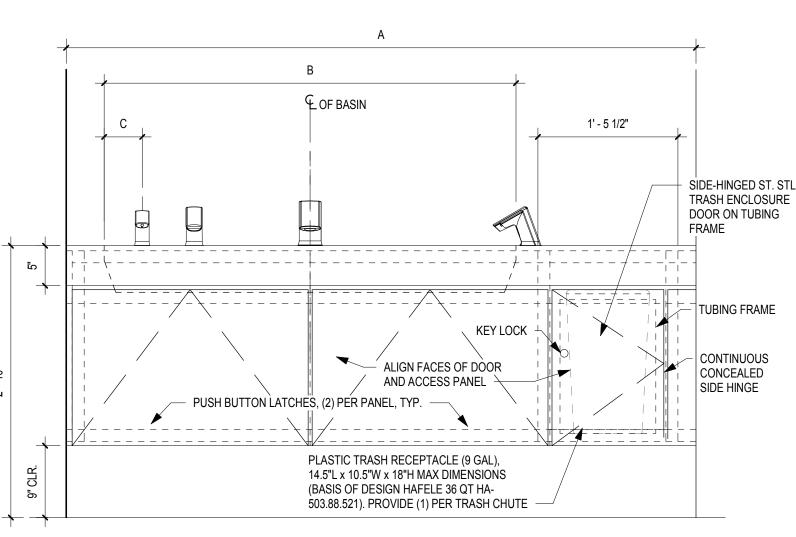


SINK SYSTEM ELEVATION - 1 BASIN WITH TRASH

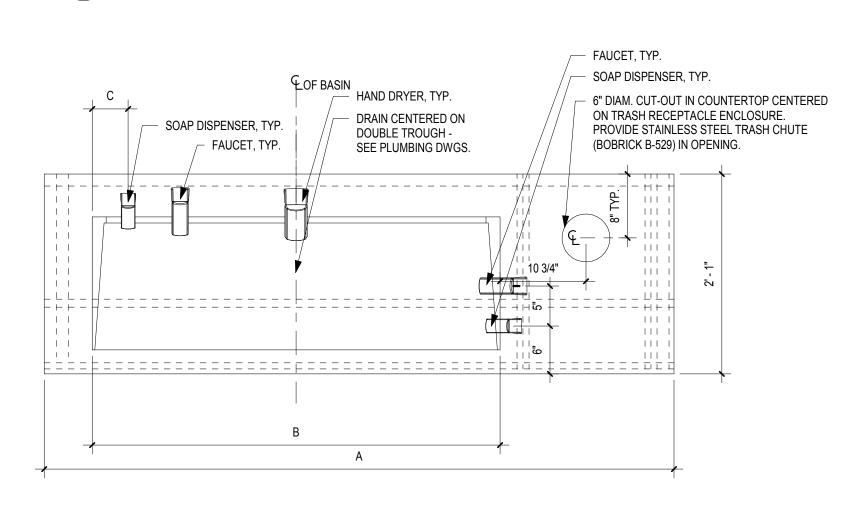


SINK SYSTEM - 1 BASIN WITH TRASH A401 SCALE: 1" = 1'-0"

LOF BASIN



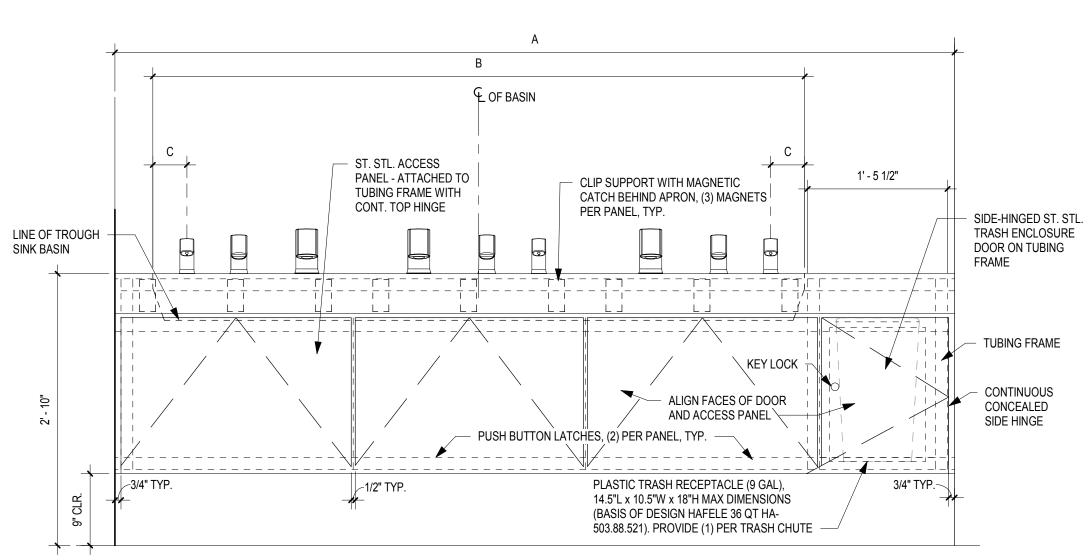

4 SINK SYSTEM ELEVATION - 1 TRIPLE BASIN SCALE: 1" = 1'-0"

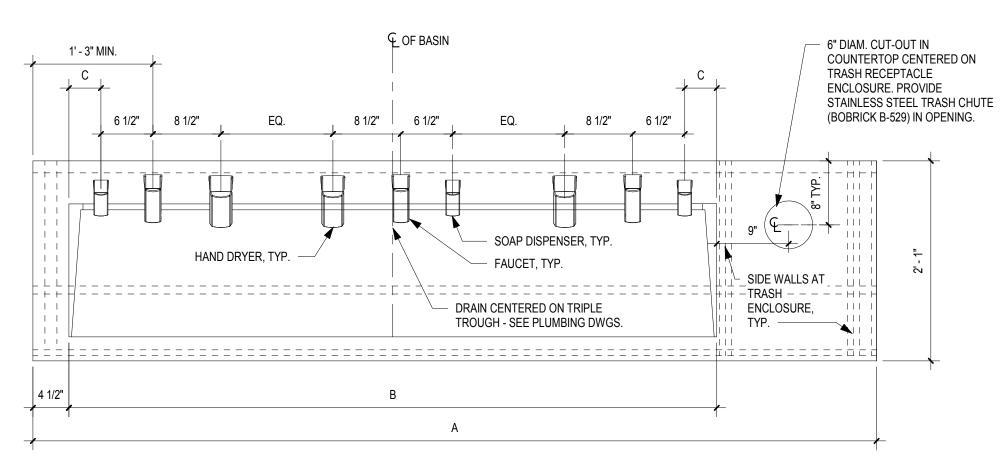

SINK SYSTEM - 1 TRIPLE BASIN A401 SCALE: 1" = 1'-0"

CONVERSE WINKLER ARCHITECTURE 331 MONTGOMERY AVE BALA CYNWYD, PA 19144

ARCHITECTS: CONVERSE WINKLER ARCHITECTURE 331 Montgomery Avenue, Bala Cynwyd, PA, 19144 Ph: 610.664.0806

Fax: 215.664.1075 Contact: Elin Westrick e-mail: ewestrick@cwarc.com

MEP ENGINEERS:

ARORA° Chadds Ford, PA 19317


P (610) 459-7900 | F (610) 459-7950 | aroraengineers.com Contact: Kevin Sultanik

e-mail: ksultanik@aroraengineers.com STRUCTURAL ENGINEERS:

CSA GROUP 1341 NORTH DELAWARE AVENUE, SUITE 507 PHILADELPHIA, PA 19125

Ph: 215.427.8700 Fax: 215.427.8752

Contact: Wing Au e-mail: wau@csagroup.com

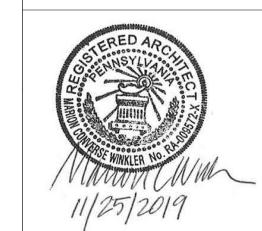

REVISIONS: Description

PENNSYLVANIA CONVENTION CENTER


TYPICAL SINK **DETAILS**

CW1615 Project number November 25, 2019 KR/LC Drawn by EW Checked by


A401

1" = 1'-0"



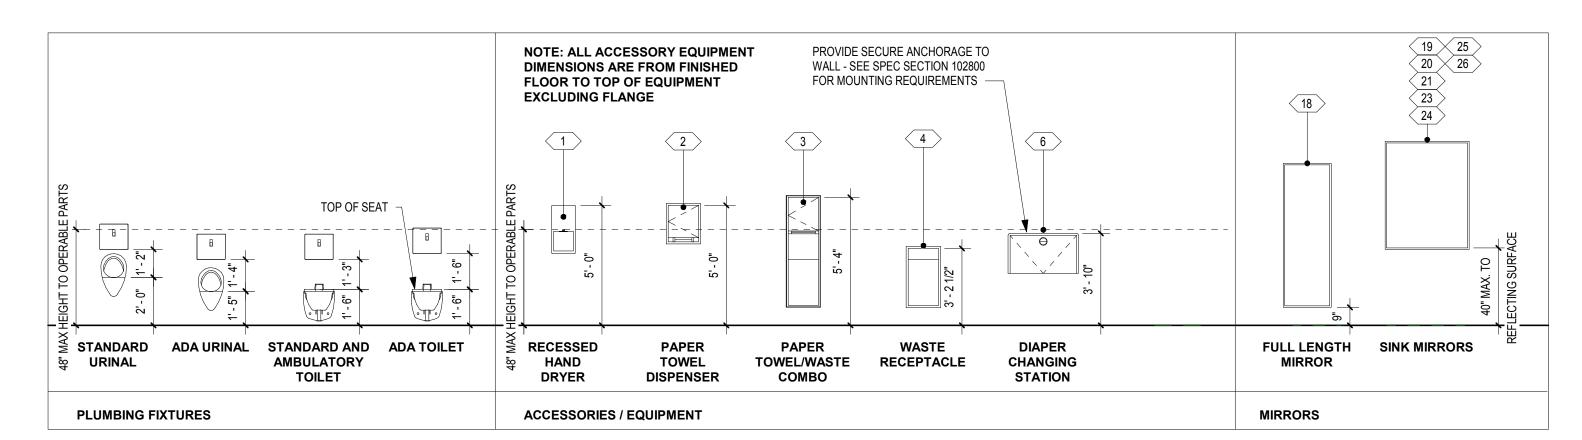


TYPICAL MOUNTING HEIGHTS

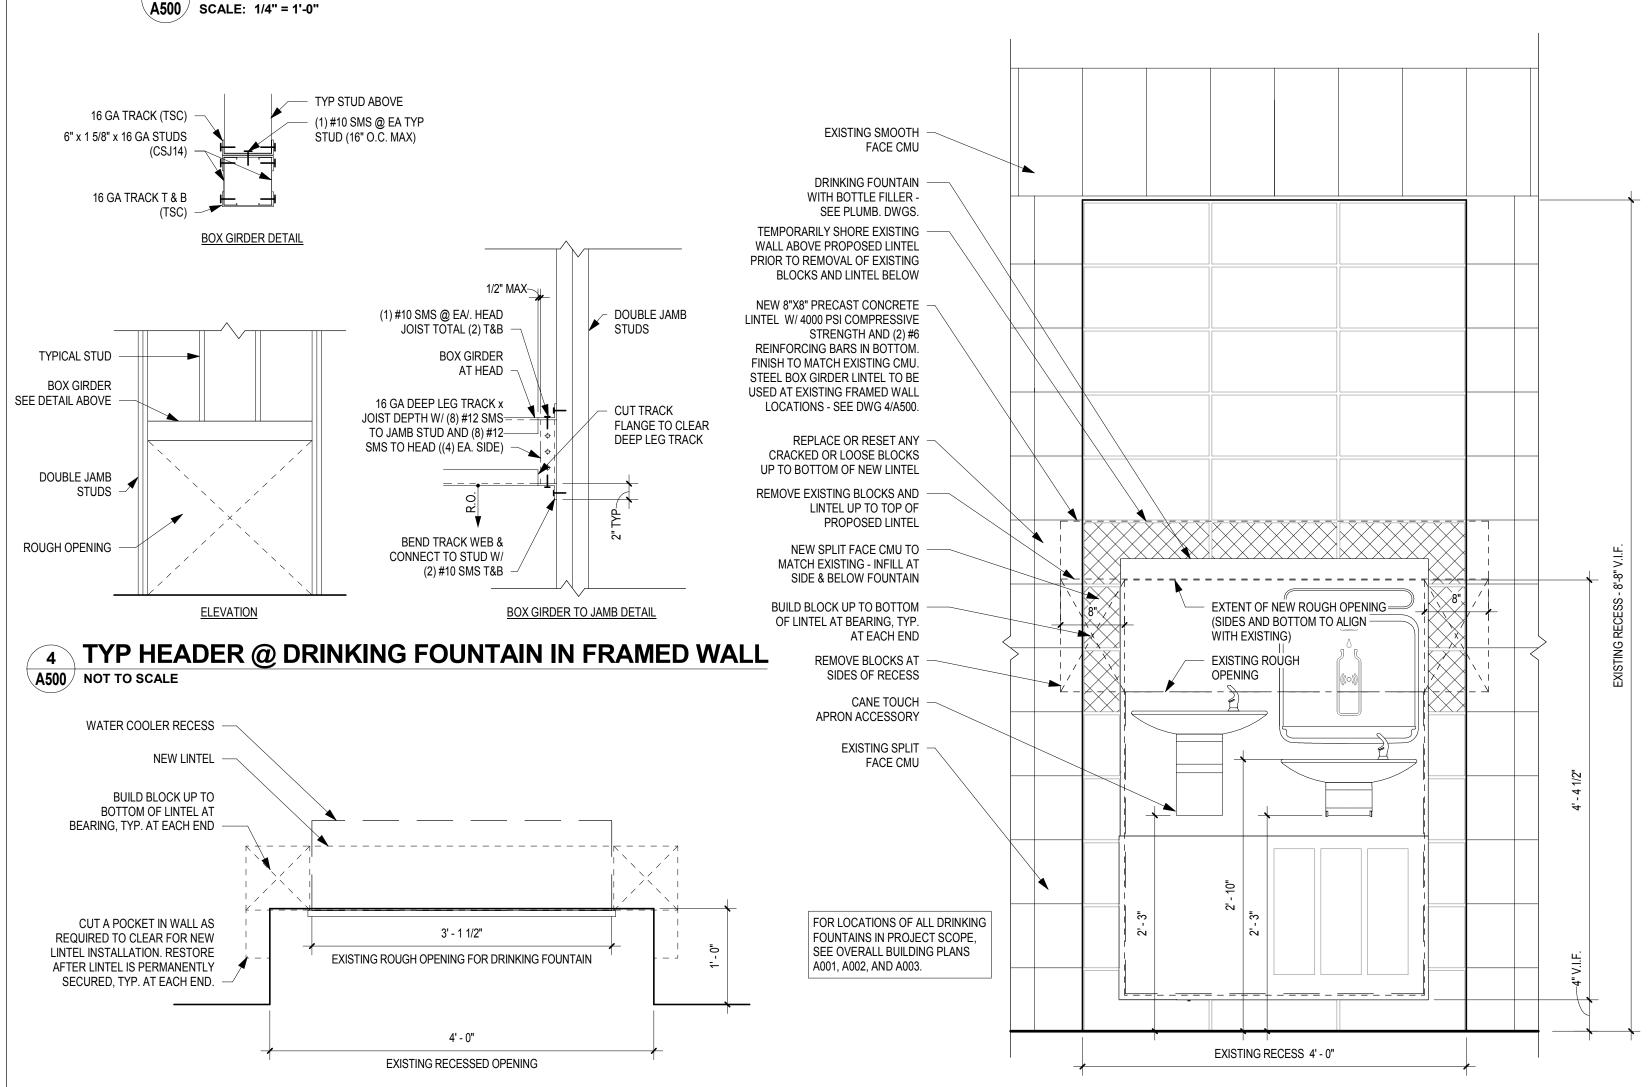


NOTE: SIMILAR FOR OTHER DRINKING FOUNTAINS LOCATED IN EXISTING CMU WALL. **TYPICAL PLAN @ EXHIBIT HALL DRINKING FOUNTAIN** A500 SCALE: 1" = 1'-0"


TYPICAL ELEVATION @ EXHIBIT HALL DRINKING FOUNTAIN A500 SCALE: 1" = 1'-0"

NOTE: SIMILAR FOR OTHER DRINKING FOUNTAINS LOCATED IN EXISTING CMU WALL.

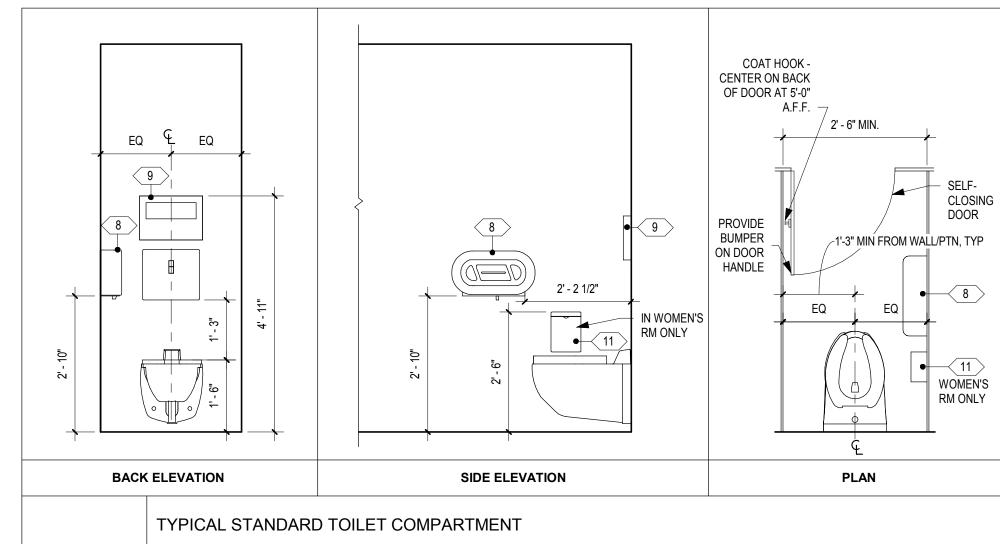

SCALE: 1/2" = 1'-0"

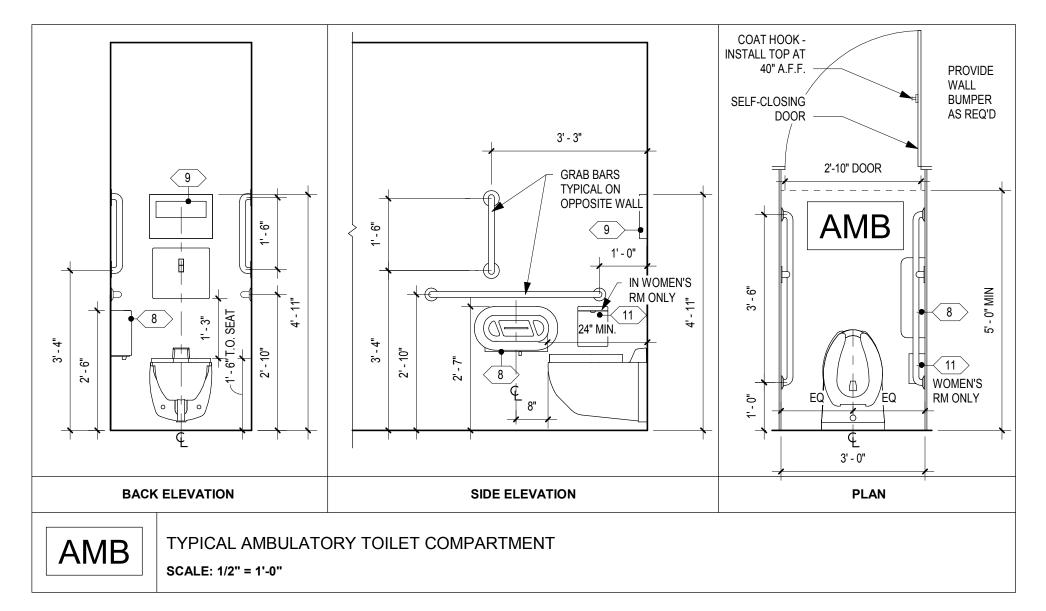

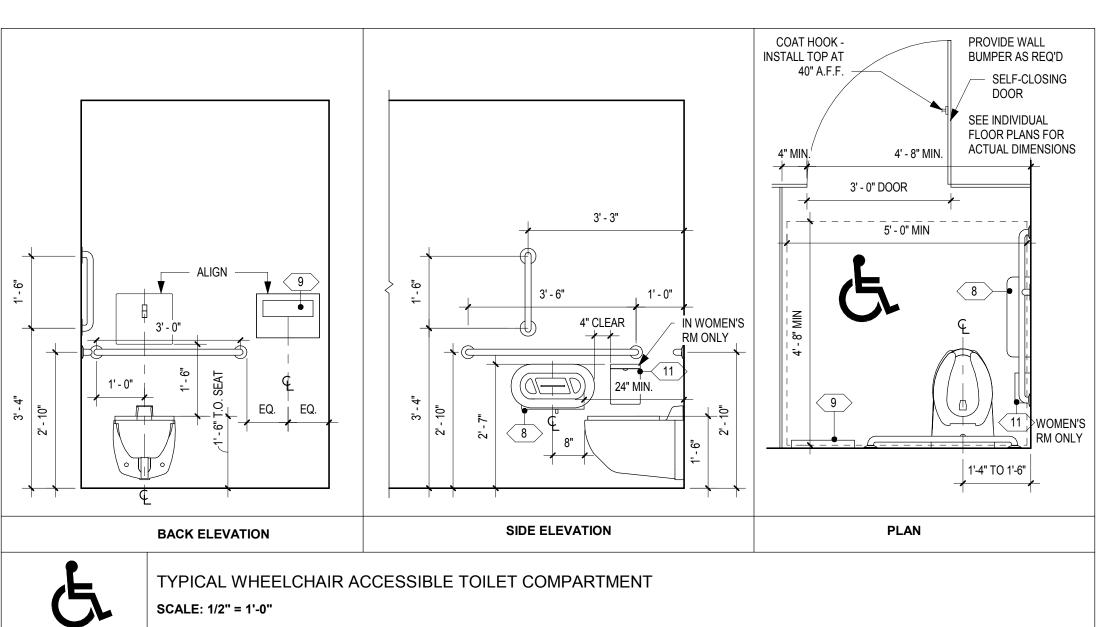

1. SEE INDIVIDUAL ELEVATIONS FOR TILE NOTES 2. SEE PLANS FOR SIDE OF COMPARTMENTS ON WHICH TO MOUNT ACCESSORIES 3. ALL GRAB BAR DIMENSIONS SHOWN TO CENTERLINE OF GRAB BAR

> **TYPICAL TOILET COMPARTMENTS** A500 SCALE: 1/2" = 1'-0"

CONVERSE **WINKLER ARCHITECTURE** BALA CYNWYD, PA 19144

ARCHITECTS: CONVERSE WINKLER ARCHITECTURE 331 Montgomery Avenue, Bala Cynwyd, PA, 19144 Ph: 610.664.0806

Fax: 215.664.1075 Contact: Elin Westrick e-mail: ewestrick@cwarc.com

MEP ENGINEERS:

ARORA° Chadds Ford, PA 19317

P (610) 459-7900 | F (610) 459-7950 | aroraengineers.com

Contact: Kevin Sultanik e-mail: ksultanik@aroraengineers.com

STRUCTURAL ENGINEERS: CSA GROUP 1341 NORTH DELAWARE AVENUE, SUITE 507

PHILADELPHIA, PA 19125 Ph: 215.427.8700 Fax: 215.427.8752

Contact: Wing Au e-mail: wau@csagroup.com



REVISIONS: Description


/ANIA CENTER PENNSYLV, CONVENTION (

TYPICAL DETAILS

CW1615 Project number

November 25, 2019 KR/LC Drawn by Checked by

A500

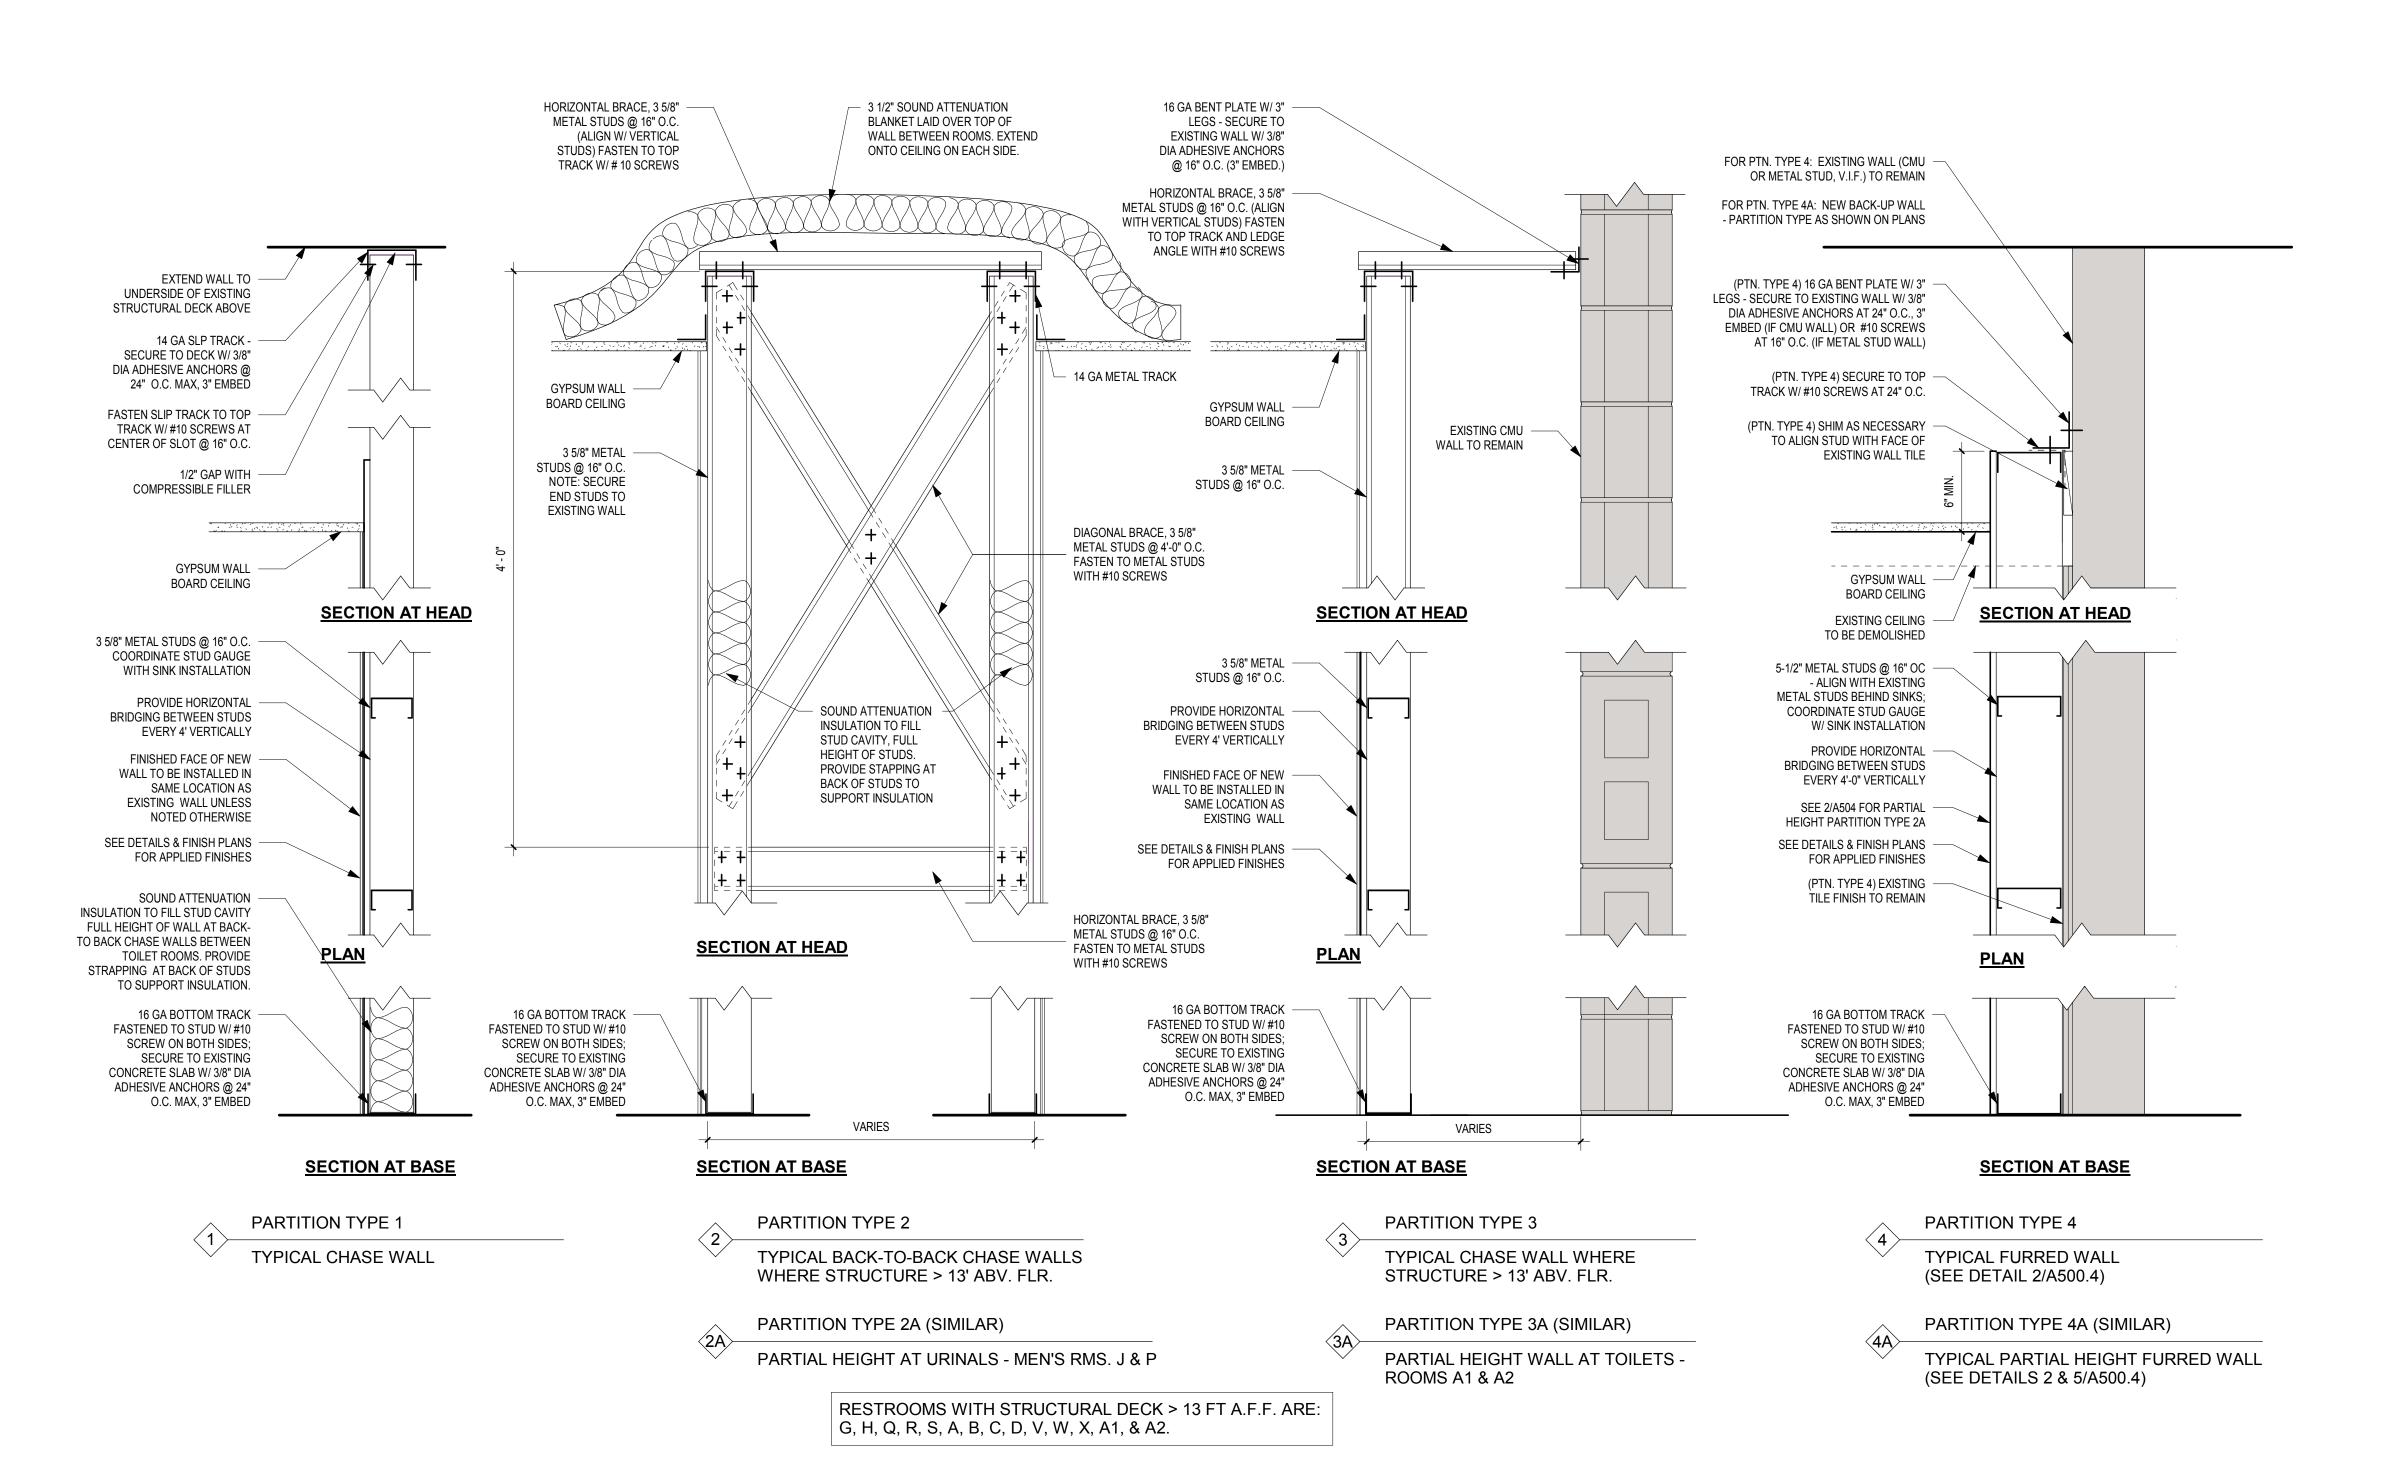

CONVERSE **WINKLER** ARCHITECTURE 331 MONTGOMERY AVE BALA CYNWYD, PA 19144

ARCHITECTS: CONVERSE WINKLER ARCHITECTURE 331 Montgomery Avenue, Bala Cynwyd, PA, 19144

Ph: 610.664.0806

Contact: Elin Westrick e-mail: ewestrick@cwarc.com

MEP ENGINEERS:

Fax: 215.664.1075



P (610) 459-7900 F (610) 459-7950 aroraengineers.com Contact: Kevin Sultanik


e-mail: ksultanik@aroraengineers.com

STRUCTURAL ENGINEERS: CSA GROUP 1341 NORTH DELAWARE AVENUE, SUITE 507

Ph: 215.427.8700 Fax: 215.427.8752

Contact: Wing Au e-mail: wau@csagroup.com

PHILADELPHIA, PA 19125

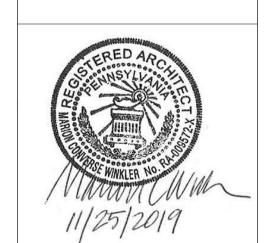

REVISIONS: Description


> /ANIA CENTER RESTROOM RENOVATIONS PENNSYLV, CONVENTION (

TYPICAL WALL **PARTITION TYPES**

CW1615 Project number November 25, 2019 KR/LC Drawn by EW Checked by

A500.1

1 1/2" = 1'-0"

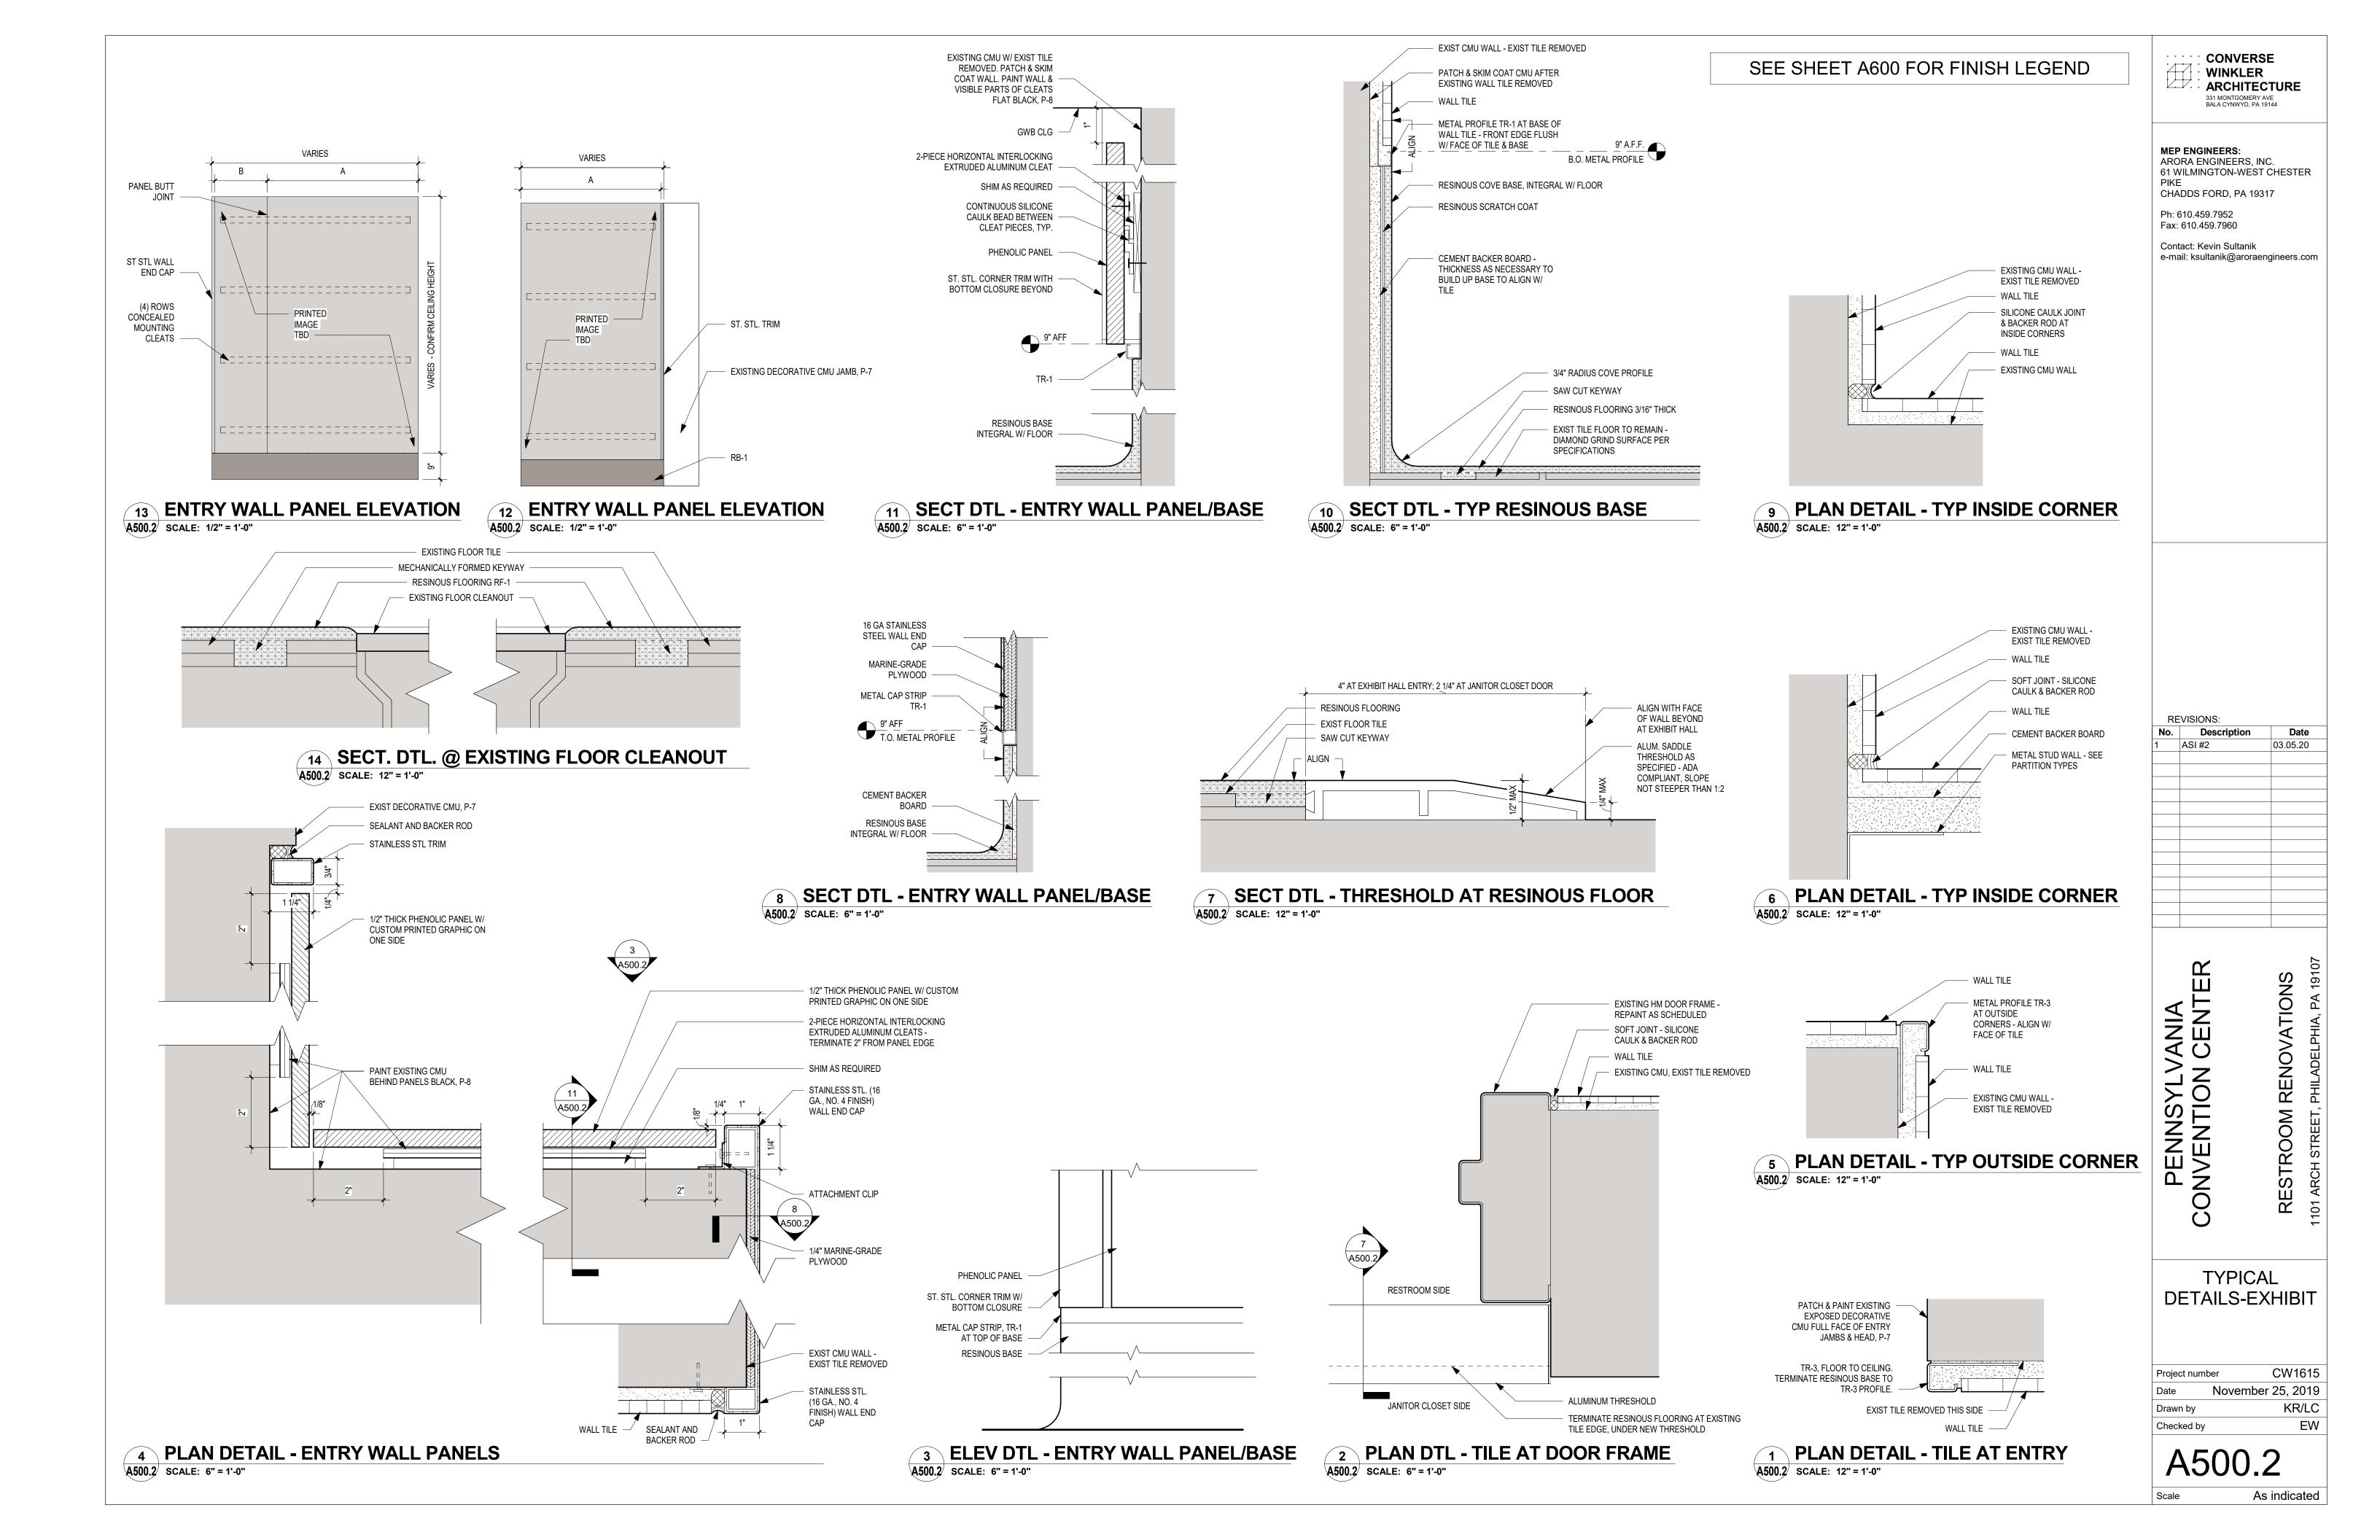

PROVIDE WHITE CAULK AT JOINT OF WALL TO CEILING, TYP.

4' - 8" V.I.F. 1' - 9 1/2" V.I.F. 18' - 0" V.I.F. WALL FRONT WALL SIDE WALL BACK EQ A EQ B EQ B CUT TILE AS NECESSARY IN FIRST & LAST COLUMNS CT-3 CT-3 COLOR COLOR CT-2 COLOR CT-3 COLOR CT-2 CT-2 ACCENT COLOR - SEE CHART CT-3 CT-2 COLOR COLOR COLOR 🖊 CT-3 CT-2 CT-2 CT-2 CŢ-2 COLOR COLOR CT-3 COLOR CT-2 CT-2 CT-3 COLOR CT-3 CT-3 COLOR CT-3 CT-2 CT-2 COLOR CT-3 COLOR COLOR COLOR CT-3 CT-2 CT-3 COLOR CT-3 CT-3 COLOR CT-3 COLOR CT-3 CT-3 CT-2 CT-2 CT-3 COLOR COLOR COLOR CT-2 CT-2 CT-2 CT-3 CT-3 CT-2 CT-3 COLOR CT-3 CT-2 CT-3 CT-3 CT-2 COLOR CT-3 CT-2 COLOR COLOR CT-3 COLOR C†-2 COLOR COLOR CT-2 COLOR CT-3 CT-2 COLOR COLOR CT-3 color COLOR COLOR CT-2 CT-3 COLOR CT-2 COLOR CT-2 COLOR CT-3 COLOR COLOR CT-3 CT-3 CT-2 CT-3 COLOR CT-3 COLOR COLOR CT-3 CT-2 CT-3 COLOR CT-3 CT-2 CT-2 CT-2 COLOR COLOR COLOR COLOR DEVELOPED ELEVATION -[|]€ WALL & TILE WALL TURNS 90 DEGREES

6 WALL TILE PATTERN - WP-6 - ROOM O

A500.3 SCALE: 1/2" = 1'-0"


		L					V.I.F.					L	
						CUT TILE AS NECE	ESSARY IN FIRST &	LAST COLUMNS —				1	_
	-VARIES	EQ.										EQ.	
ı	A	1									-7		_
_		CT-3	CT-2	COLOR	COLOR	CT-2	COLOR	CT-2	CT-3	CT-2	CT-2	COLOR 🗻	— ACCENT COLOR - SEE CHART
	₽	CT-3	CT-2 CT-3	CT-3	CT-3	COLOR CT-2	COLOR CT-2	- CT-3	CT-2	COLOR CT-2	COLOR	CT-3 CT-3	
	4	COLOR CT-2	COLOR	CT-2	CT-2	CT-3	CT-3	CT-3 CT-2	COLOR	CT-3	CT-3 COLOR	CT-2	
	5∞	CT-3	CT-3	COLOR	CT-3	COLOR CT-2	COLOR CT-3	COLOR CT-3	CT-2	COLOR	CT-3	CT-3	
	4	CT-2 CT-2	COLOR CT-2	CT-3	CT-3 COLOR	CT-2	CT-2	COLOR	CT-3 COLOR	CT-3 COLOR	CT-2	COLOR CT-2	
	₽ 4	COLOR	COLOR	CT-2	CT-2	COLOR CT-2	CT-3	CT-2 COLOR	COLOR CT-3	CT-2	CT-3	CT-2	
VARIES	₽	CT-2 CT-3	CT-2	CT-3	CT-3 COLOR	CT-2	COLOR	COLOR CT-3	CT-2	CT-3	CT-2 CT-2	CT-3 CT-2	
ΙΑΝ	₽	COLOR	COLOR	CT-2 CT-3	COLOR CT-3	CT-2	CT-3 CT ₁ -2	COLOR	CT-3	COLOR COLOR	COLOR	COLOR COLOR	
	4	COLOR	COLOR	COLOR	CT-3	COLOR	CT-3	CT-3 COLOR	CT-2	CT-2	COLOR	COLOR	
	₽ -	CT-3	CT-3 COLOR	CT-2 COLOR	CT-2 COLOR	CT-2 CT-3	СТ-2	COLOR CT-2	COLOR	CT-3	CT-3 CT-3	CT-3	1
	₽	CT-2	CT-2	CT-3	CT-2	CT-2	COLOR	CT-2	CT-3	CT-2	CT-2	CT-2	
		COLOR	CI-3	CT-2	COLOR	CT-3	CT-3	COLOR	CT-2	CT-3	COLOR	COLOR	/ TR-1
		Y Y	γ γ γ	// // / /	Y Y		<u> </u>	7	Y v	<u> </u>			ND-1
4							E WALL	&TILE .		1			

WALL TILE PATTERN - WP-4 - ROOMS G, H

A500.3 SCALE: 1/2" = 1'-0"


ACCENT COLOR VARIATIONS BY ROOM			
ROOM	ACCENT COLOR		
F (MEN/WOMEN)	CT-5		
G (MEN/WOMEN)	CT-5		
H (MEN/WOMEN)	CT-5		
J (MEN/WOMEN)	CT-6		
K (MEN/WOMEN)	CT-7		
N (WOMEN)	CT-5		
O (MEN)	CT-5		
P (MEN/WOMEN)	CT-5		
Q (MEN/WOMEN)	CT-5		
R (MEN/WOMEN)	CT-7		
S (MEN/WOMEN)	CT-6		

NOTE: SEE SHEET A600 FOR FINISH LEGEND AND SCHEDULES. SEE FINISH PLANS (A600 SERIES) FOR ACCENT WALL LOCATIONS.

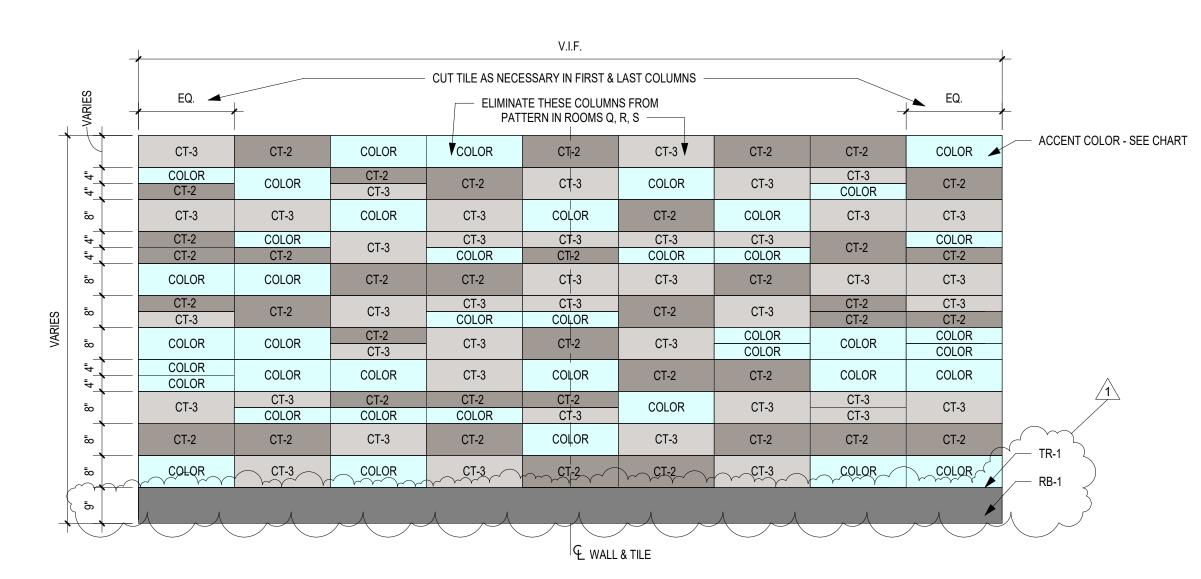


5 WALL TILE PATTERN - WP-5 - ROOMS N, Q, R, S

A500.3 SCALE: 1/2" = 1'-0"

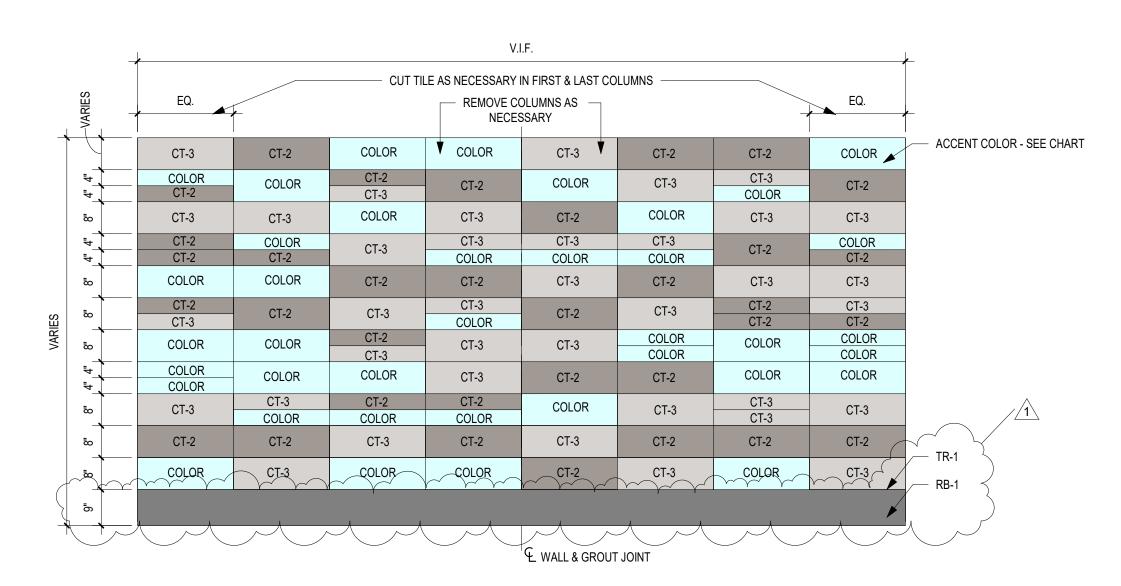

3 WALL TILE PATTERN - WP-3 - ROOMS F, J, K, P

A500.3 SCALE: 1/2" = 1'-0"

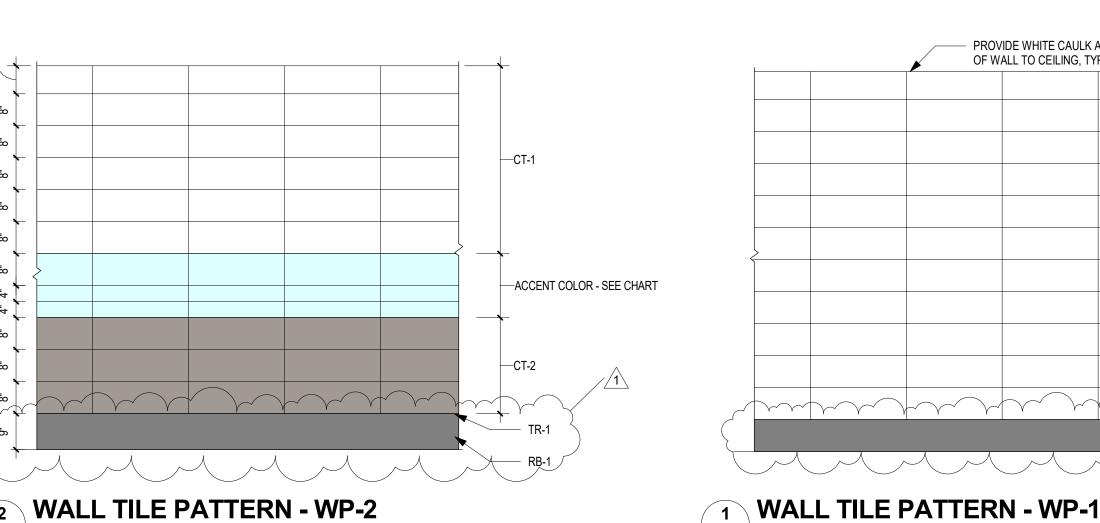

WALL TILE PATTERN - WP-2 A500.3 SCALE: 1/2" = 1'-0"

A500.3 SCALE: 1/2" = 1'-0"



CONVERSE

ARCHITECTURE

WINKLER

Fax: 215.664.1075 Contact: Elin Westrick

e-mail: ewestrick@cwarc.com

MEP ENGINEERS:

ARORA Chadds Ford, PA 19317

P (610) 459-7900 | F (610) 459-7950 | aroraengineers.com


Contact: Kevin Sultanik e-mail: ksultanik@aroraengineers.com

STRUCTURAL ENGINEERS:

CSA GROUP 1341 NORTH DELAWARE AVENUE, SUITE 507 PHILADELPHIA, PA 19125

Ph: 215.427.8700 Fax: 215.427.8752

Contact: Wing Au e-mail: wau@csagroup.com

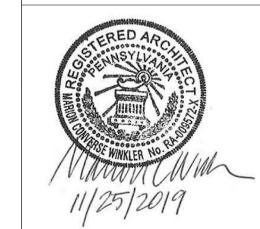

REVISIONS: Date Description 03.05.20 ASI #2

PENNSYLVANIA CONVENTION CENTER

TYPICAL WALL PATTERN **DETAILS-EXHIBIT**

CW1615 Project number November 25, 2019 Drawn by KR/LC EW Checked by

A500.3

A500.4

As indicated

A500.4 SCALE: 1 1/2" = 1'-0"

START W/ FULL TILE ABOVE COVE BASE 2 FULL TILES **6 FRONT ELEVATION - ACCENT WALL**

1 FULL TILE ON

FACE OF SOFFIT

TR-7

BACKSPLASH - Q1

COUNTERTOP - Q1

STAINLESS STEEL

ENCLOSURE BEYOND

90-DEGREE INSIDE CORNER

TURN PROFILE, TR-4

RADIUSED CORNER

ACCENT WALL TILE,

A500.4 SCALE: 1" = 1'-0"

GWB CEILING, P-1

CEILING AND SOFFIT)

FLOOR LEVEL WITHIN

SIDE ELEVATION - ACCENT WALL

ALLOWABLE TOLERANCE

A500.4 SCALE: 1" = 1'-0"

TR-5 (IN CORNER BETWEEN

PROFILE, TR-4

TR-5

RADIUSED CORNER PROFILE, TR-4 GWB SOFFIT CEILING, P-3 THIN PORCELAIN TILE, CT-12 ACCENT WALL TILE, RADIUSED CORNER PROFILE, TR-4 10 FULL TILES PROFILE TR-7 AT TOP OF SIDE AND BACK SPLASHES. FACE OF SIDESPLASH FLUSH W/ CT-13. CUT TILE AS REQ'D TERMINATE SIDE SPLASH (Q1) AT EDGE OF CORNER PROFILÉ ST. STL. ENCLOSURE PANEL FRAMING & BACKER FULL SIZE TILES ON CONTINUOUS METAL SIDE AND END OF COVE BASE WITH INSIDE AND OUTSIDE CORNER PROFILES, TR-2, TYP. FULL CT-12 TILE - SCRIBE TILE AS REQ'D TO ACCOMMODATE

1' - 5" **5 SECTION @ SINK W/ NEW SIDE WALLS** A500.4 SCALE: 1 1/2" = 1'-0" ACCENT TILE CT-13 ON THIN-SET MORTAR BED OVER 1/2" CEMENT BACKER BOARD QUARTZ BACKSPLASH & LEDGE (Q1) ON PARTIAL HEIGHT 5 1/2" BETWEEN _ SPOUT CENTERS_ - ENHANCED REACH QUARTZ SIDE RANGE FIXTURES AS SPLASH (Q1) -INDICATED ON PLANS ALIGN FACE FINISH W/ CT-13 .___^____ ACCENT TILE CT-13 CHANNEL INTO STUD WALLS AT BOTH ENDS AND BEAR ON DOUBLE STEEL STUDS - CONTINUE STUD ABOVE

ENLARGED PLAN @ SINK W/ NEW SIDE WALLS

A500.4 SCALE: 1 1/2" = 1'-0"

⊕MAIN CLG ≤ 8'-6"

◆ SOFFIT CLG

CEILING

A500.4 SCALE: 1 1/2" = 1'-0"

TRANSITION PROFILE TR-7

3/4" MARINE-GRADE PLYWD

TOP-HINGED ST STL

ENCLOSURE PANEL

IN OPEN POSITION

ALIGN APRON W/

CONTINUOUS STEEL CHANNEL

APRON (NOT INCLUDED W/ SINK

TO ACCOMMODATE CHANNEL.

ASSEMBLY). SINK CONFIGURATION

9' - 0"
GWB CEILING

START WITH FULL TILE ABOVE COVE

SUPPORT W/ WD BLOCKING BEHIND

TILE EDGE

SET ROUGH

BOARD TO

ACCOMMODATE

1/2" CEMENT

BACKER BOARD

TERMINATE AT OUTSIDE CORNER PROFILE

3/4" QUARTZ (Q1) AT

SINK COUNTERTOP &

APRON

1/8" PENCIL-

C4X7.25

MAGNETIC

ROUND EDGE,

ALIGN CT-12 GROUT

JOINT W/ SOFFIT WHEN

MAIN CEILING IS ≤ 8'-6".

CUT FIRST COURSE OF

2' - 0"

QUARTZ SIDESPLASH (Q1)

CONT STL ANGLE

TOP-HINGED ST. STL

ENCLOSURE PANEL

10 1/2" CLR

COUNTERTOP SUPPORT FRAME -

WELDED 2" STEEL ANGLES

ST. STL BOTTOM EDGE -

FOLDED 90° AND HEMMED

SMOOTH - PUSH BUTTON

CATCH TO FRAME

CLEARANCE


REQ'D BY ADA

& ANSI A117.1


FLUSH W/ CT-13 TILE

CT-12 TILE AT FLOOR

SEE SHEET A600 FOR FINISH LEGEND

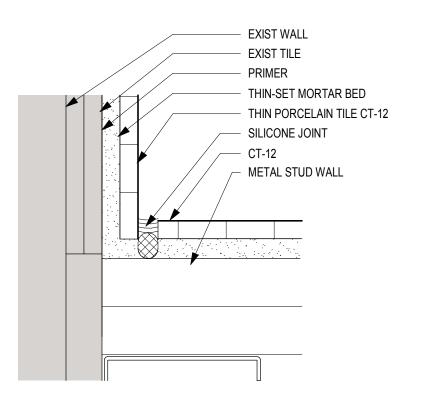


8 PLAN DTL - TYP. INSIDE CORNER A500.5 SCALE: 12" = 1'-0"

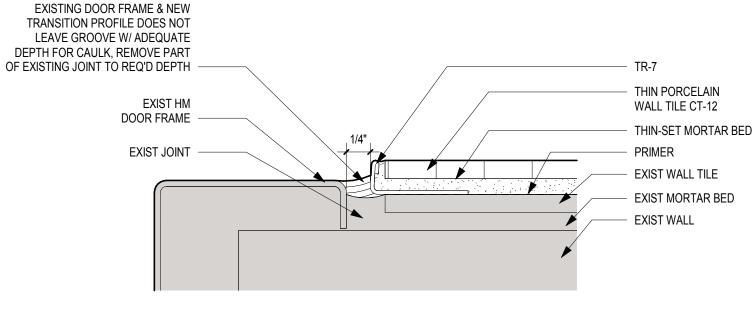


SILICONE JOINT- IF JUNCTION OF


7 HEAD/JAMB DTL @ EXIST DOOR FRAME A500.5 SCALE: 12" = 1'-0"

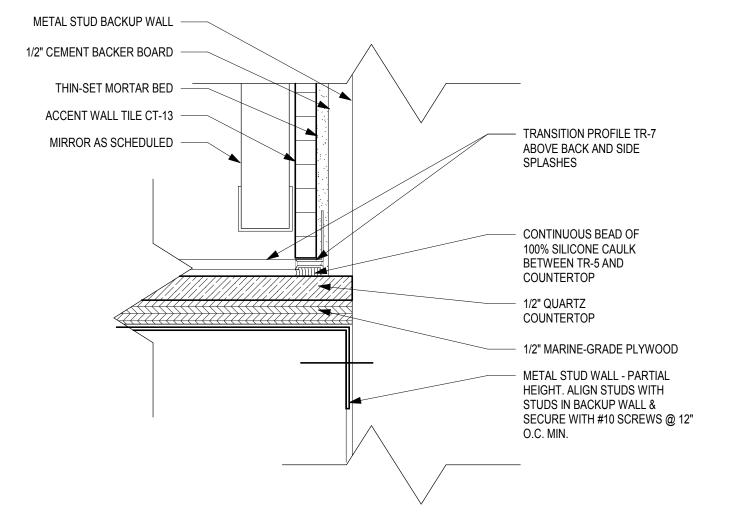

4 SECTION DTL - ACCENT WALL TILE @ COUNTERTOP A500.5 SCALE: 6" = 1'-0"

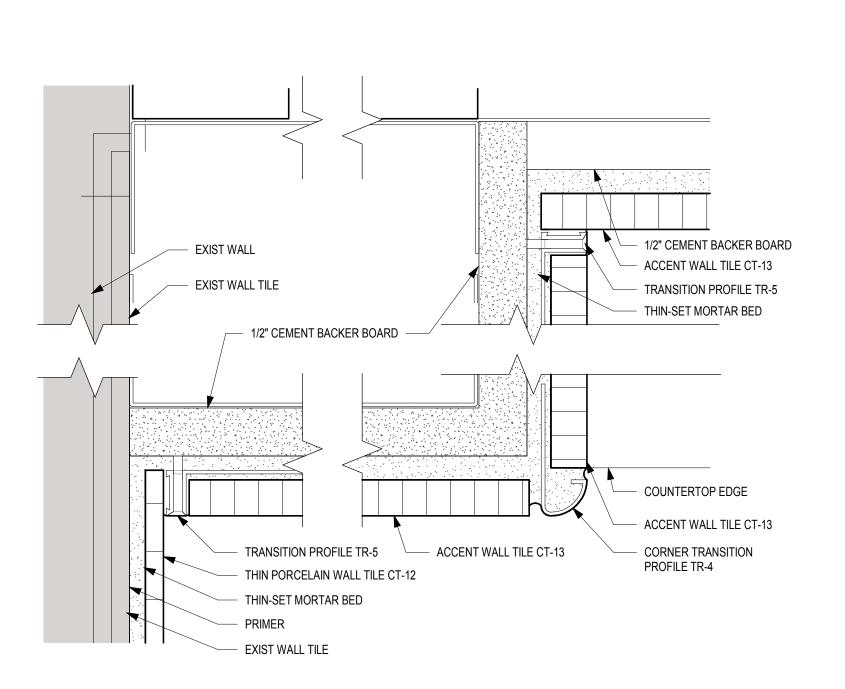

1 PLAN DTL - ACCENT TILE AT SINK
A500.5 SCALE: 12" = 1'-0"

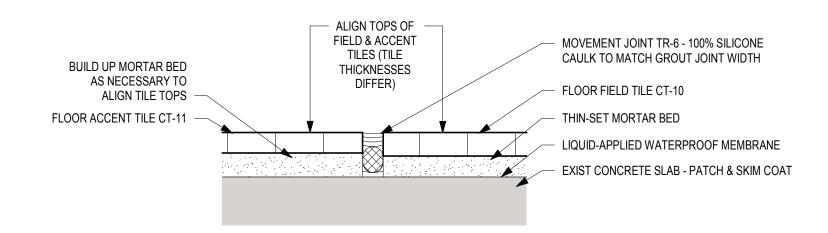

6 SECTION DTL - FLOOR MOVEMENT JOINT A500.5 SCALE: 12" = 1'-0"

1/2" CEMENT BACKER BOARD

THIN-SET MORTAR BED

ACCENT WALL TILE CT-13
STAINLESS STEEL

LINE OF EXISTING FLOOR


TILE TO BE REMOVED


THIN-SET MORTAR BED

EXISTING CONCRETE SLAB -PATCH AFTER EXISTING FLOOR TILE & MORTAR BED REMOVED -

COVE PROFILE TR-2

FLOOR TILE CT-10

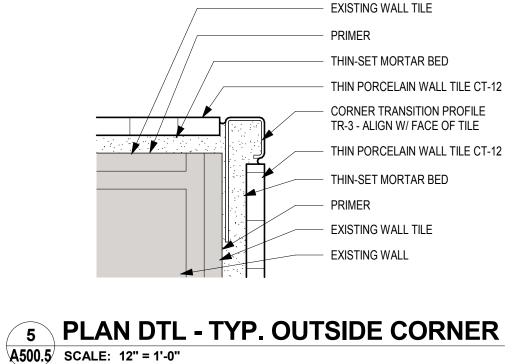


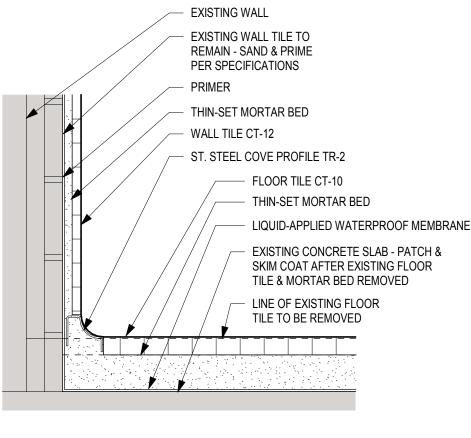



3 SECT DTL - ACCENT WALL TILE @ COVE BASE A500.5 SCALE: 6" = 1'-0"


METAL STUD WALL - PARTIAL HEIGHT

1/4" DIAMETER ADHESIVE ANCHOR @ 16" O.C. WITH 2" MIN. EMBEDMENT

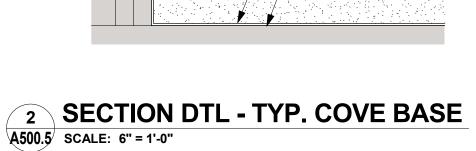

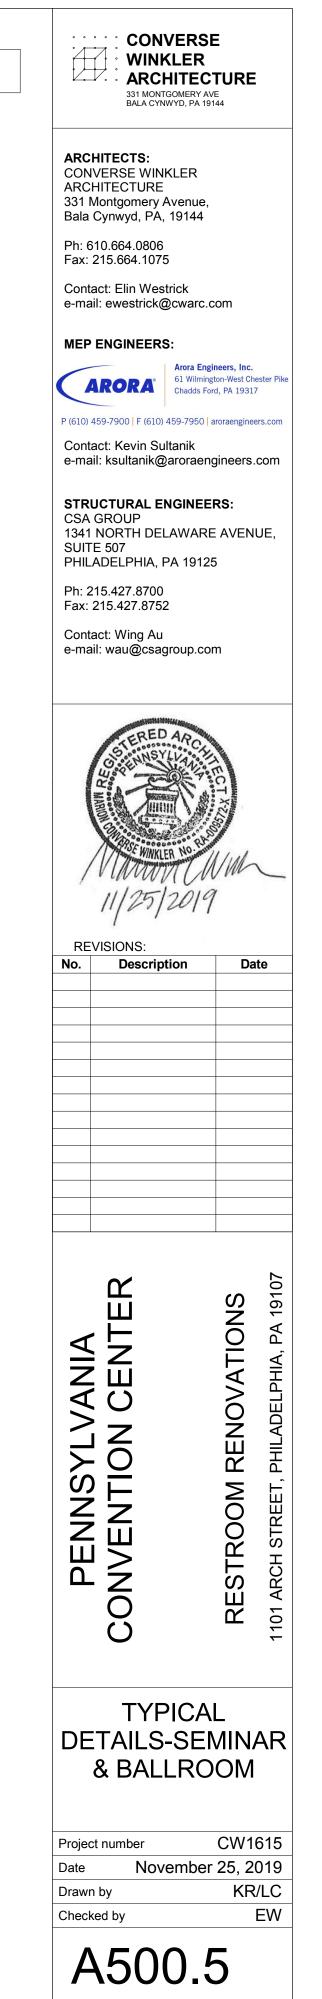


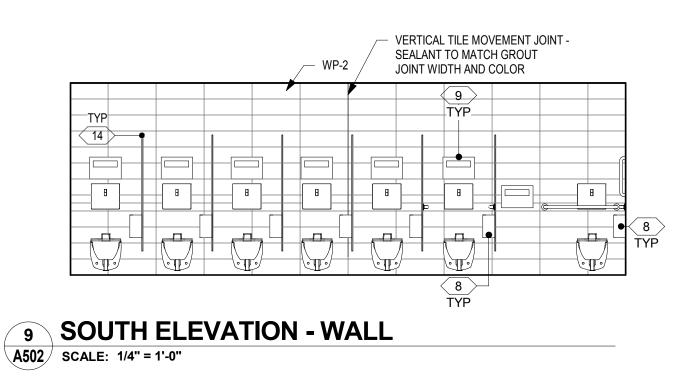


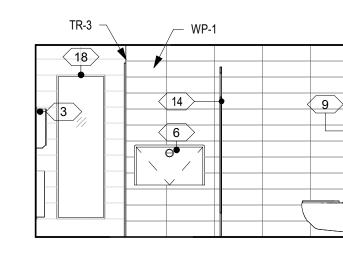


EAST ELEVATION

A502 SCALE: 1/4" = 1'-0"

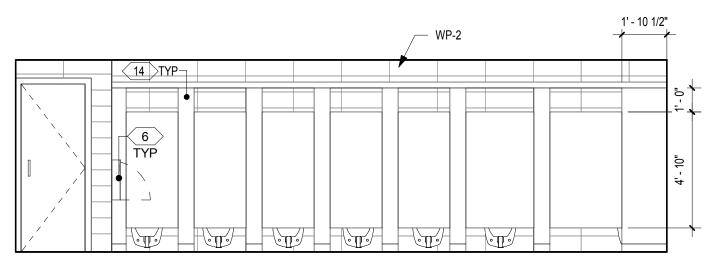

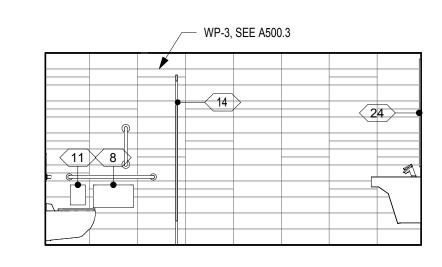

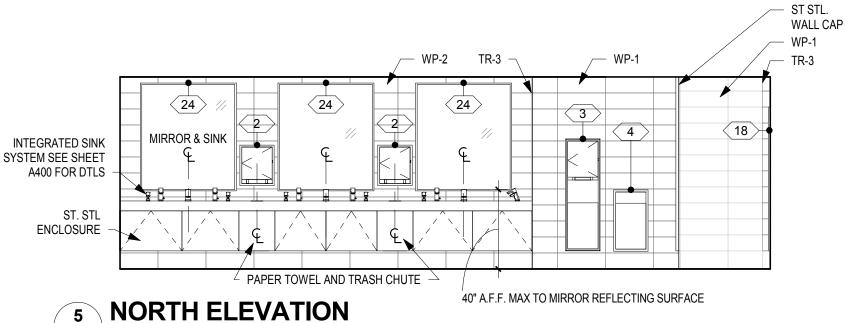

7 SOUTH ELEVATION - PARTITIONS A502 SCALE: 1/4" = 1'-0"


6 WEST ELEVATION A502 SCALE: 1/4" = 1'-0"

A502 SCALE: 1/4" = 1'-0"

SEE A602 FOR FINISHES


INTERIOR ELEVATIONS - WOMEN'S ROOM F


• 14

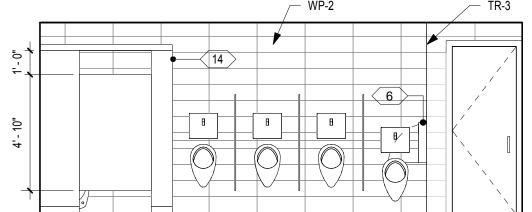

SOUTH ELEVATION - PARTITIONS

A502 SCALE: 1/4" = 1'-0"

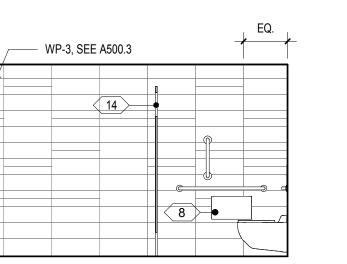

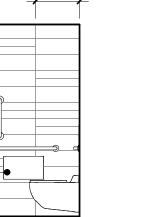

EAST ELEVATION A502 SCALE: 1/4" = 1'-0"


INTEGRATED

FOR DTLS


SINK SYSTEM -

SEE SHEET A400

ST. STL ENCLOSURE

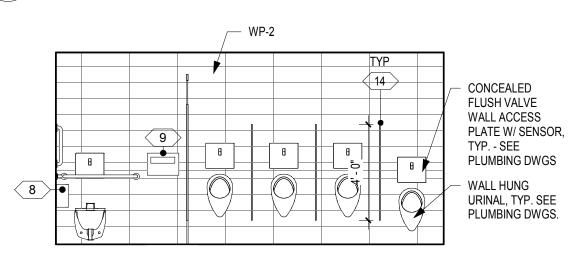


SOUTH ELEVATION - WALL A502 SCALE: 1/4" = 1'-0"

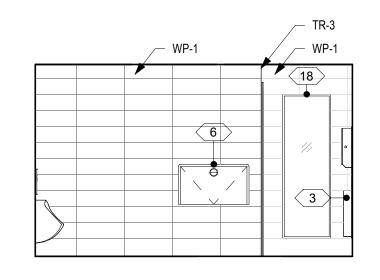

WEST ELEVATION

A502 SCALE: 1/4" = 1'-0" SEE A602 FOR FINISHES

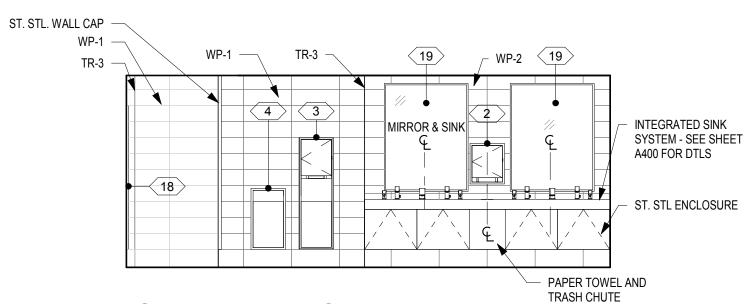


NORTH ELEVATION

A502 SCALE: 1/4" = 1'-0"

DRAWING GENERAL NOTES

- 1. SEE A500 FOR ACCESSORY / EQUIPMENT LEGEND.
- 2. SEE A500 FOR TYPICAL TOILET COMPARTMENT ELEVATIONS AND ACCESSORY MOUNTING HEIGHTS.
- 3. SEE A500.3 FOR TYPICAL WALL TILE PATTERN DETAILS IN EXHIBIT HALL RESTROOMS. 4. SEE A500.4 FOR TYPICAL ACCENT WALL TILE ELEVATIONS
- IN SEMINAR-TYPE RESTROOMS.
- 5. SEE A600-SERIES FOR FINISH PLANS, LEGENDS, AND SCHEDULES.
- 6. ALL OUTSIDE CORNERS TO RECEIVE TRANSITION PROFILE TR-3 EXCEPT AT CT-13 ACCENT TILE. 7. PROVIDE 5" ROUND ST. STL. ACCESS PLATE IN WALL AT
- WATER HAMMER ARRESTOR LOCATIONS SEE PLUMBING DWGS & COORDINATE WITH OWNER/ARCHITECT.
- 8. SEE DRAWING GENERAL NOTES IN A100-SERIES FOR

ADDITIONAL INFORMATION.

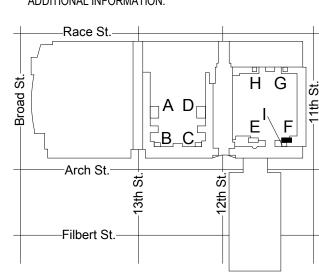

KEY PLAN - LEVEL 100 NTS

CONVERSE **WINKLER** ARCHITECTURE 331 MONTGOMERY AVE BALA CYNWYD, PA 19144

ARCHITECTS:
CONVERSE WINKLER ARCHITECTURE 331 Montgomery Avenue, Bala Cynwyd, PA, 19144

Ph: 610.664.0806 Fax: 215.664.1075

Contact: Elin Westrick e-mail: ewestrick@cwarc.com

MEP ENGINEERS:



P (610) 459-7900 | F (610) 459-7950 | aroraengineers.com


Contact: Kevin Sultanik e-mail: ksultanik@aroraengineers.com

STRUCTURAL ENGINEERS: CSA GROUP 1341 NORTH DELAWARE AVENUE, SUITE 507

PHILADELPHIA, PA 19125

Ph: 215.427.8700 Fax: 215.427.8752

Contact: Wing Au e-mail: wau@csagroup.com

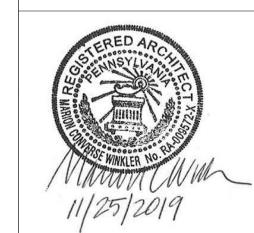

REVISIONS: Description

PENNSYLVANIA CONVENTION CENTER

RESTROOM RENOVATIONS
101 ARCH STREET, PHILADELPHIA, PA 191

ELEVATIONS & DETAILS - ROOM F (EXHIBIT)


CW1615 Project number November 25, 2019 Date KR/LC Drawn by


EW


Checked by A502

As indicated

INTERIOR ELEVATIONS - MEN'S ROOM F

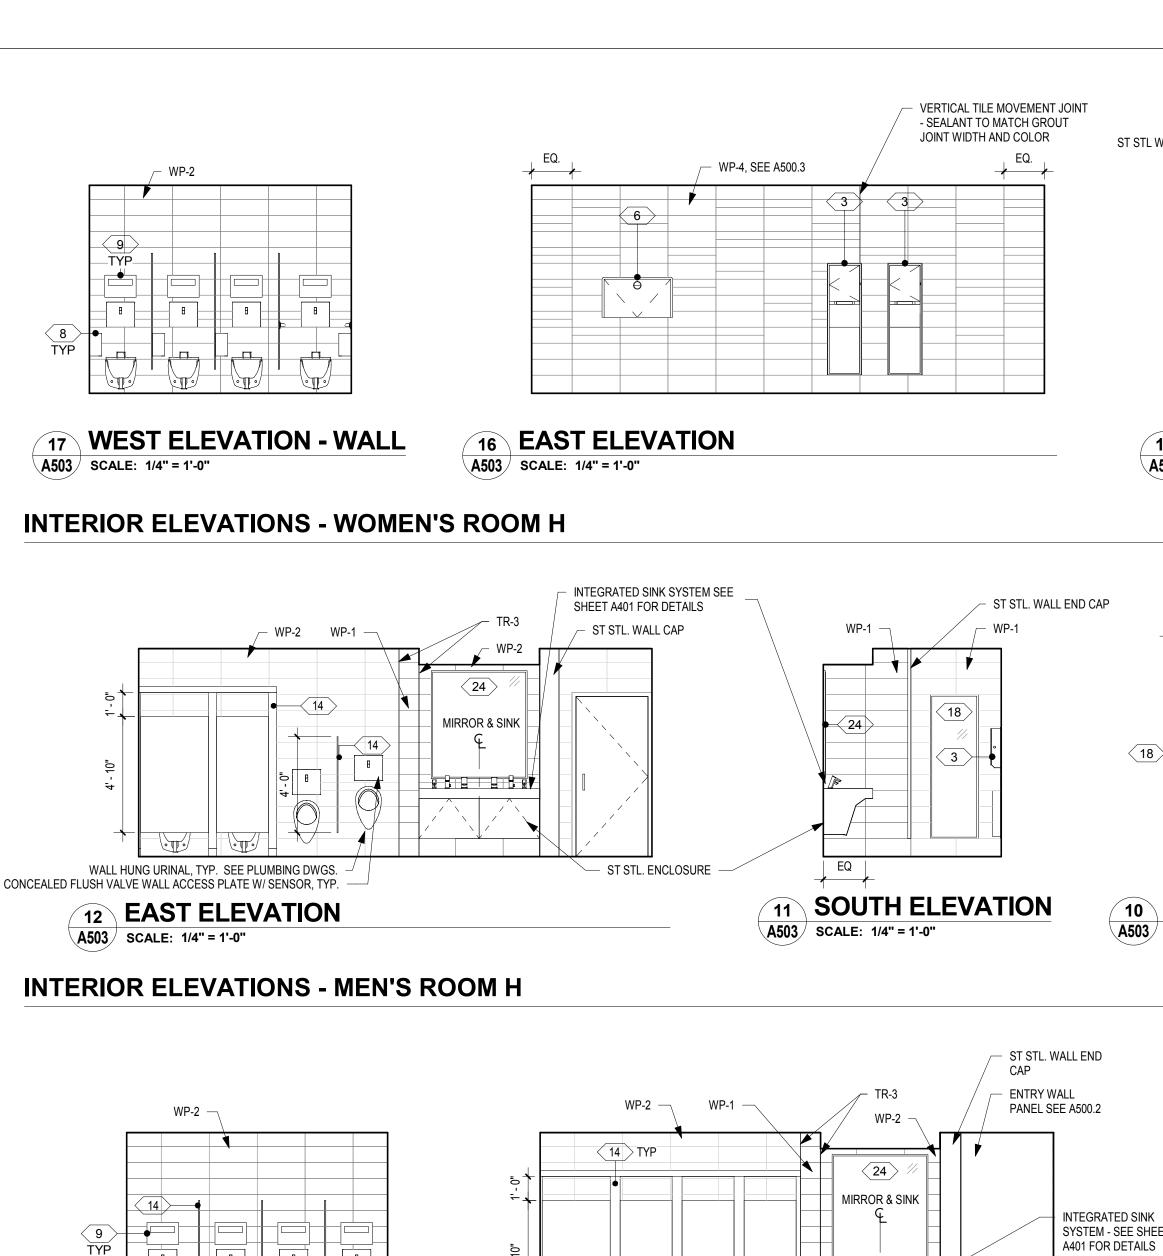


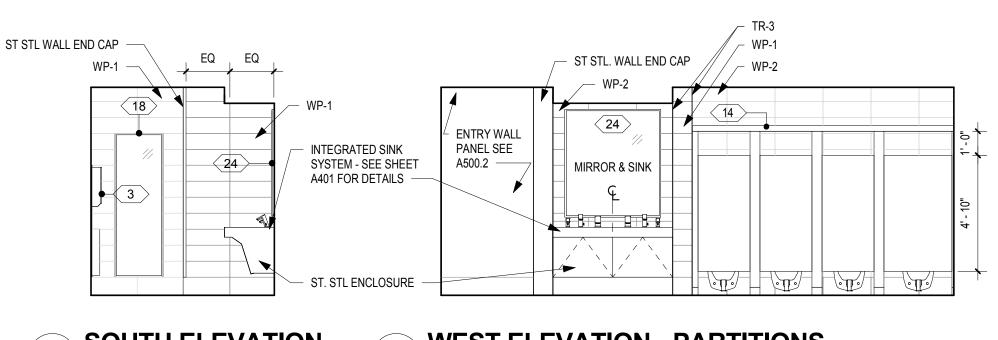

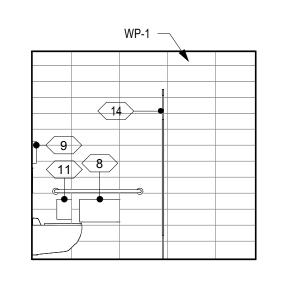


NORTH ELEVATION A503 | SCALE: 1/4" = 1'-0"

14 WEST ELEVATION - PARTITIONS SOUTH ELEVATION A503 SCALE: 1/4" = 1'-0" SCALE: 1/4" = 1'-0"

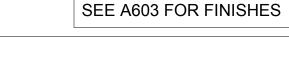


WP-4, SEE A500.3


SEE A603 FOR FINISHES

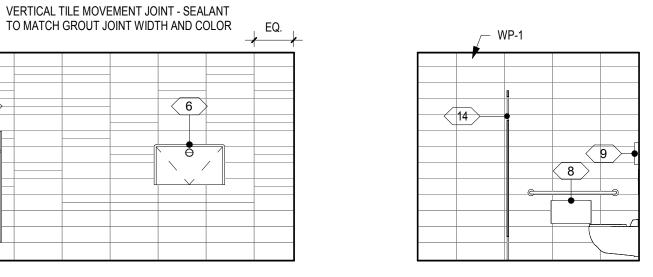






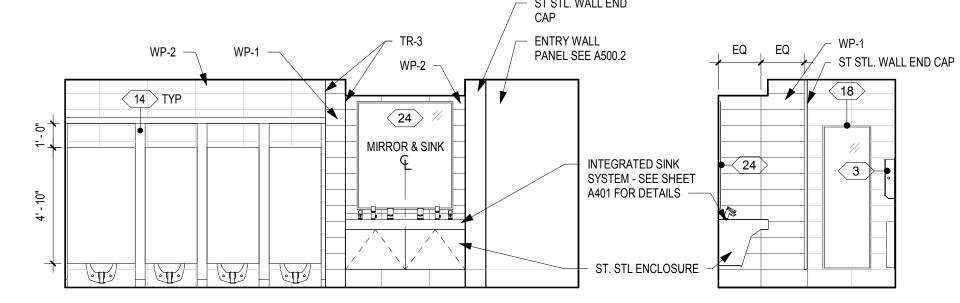

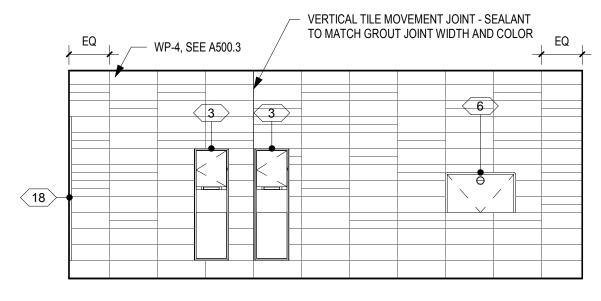

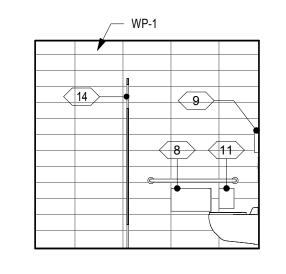

18 EAST ELEVATION - WALL A503 SCALE: 1/4" = 1'-0"

8 EAST ELEVATION - PARTITIONS A503 SCALE: 1/4" = 1'-0"


SOUTH ELEVATION A503 | SCALE: 1/4" = 1'-0"

6 WEST ELEVATION A503 SCALE: 1/4" = 1'-0"

5 NORTH ELEVATION SCALE: 1/4" = 1'-0"

INTERIOR ELEVATIONS - WOMEN'S ROOM G

SEE A603 FOR FINISHES

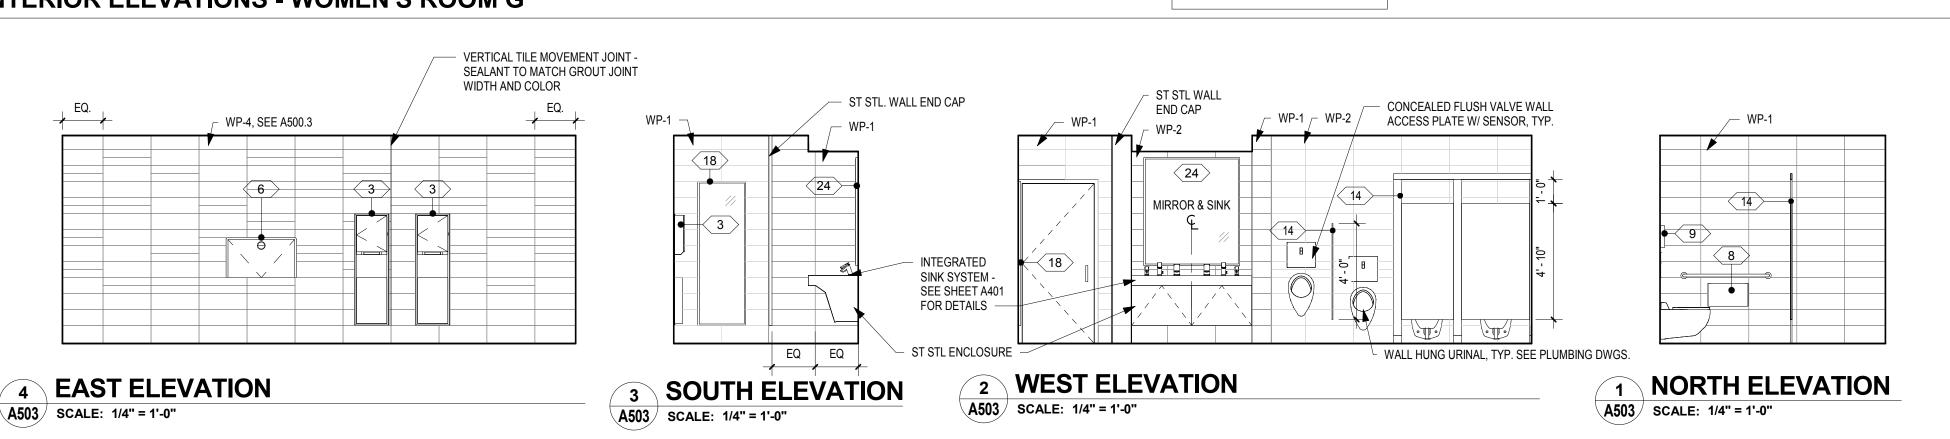


INTERIOR ELEVATIONS - MEN'S ROOM G

SEE A603 FOR FINISHES

DRAWING GENERAL NOTES

- 1. SEE A500 FOR ACCESSORY / EQUIPMENT LEGEND.
- 2. SEE A500 FOR TYPICAL TOILET COMPARTMENT ELEVATIONS AND ACCESSORY MOUNTING HEIGHTS.
- 3. SEE A500.3 FOR TYPICAL WALL TILE PATTERN DETAILS IN
- EXHIBIT HALL RESTROOMS. 4. SEE A500.4 FOR TYPICAL ACCENT WALL TILE ELEVATIONS
- IN SEMINAR-TYPE RESTROOMS. 5. SEE A600-SERIES FOR FINISH PLANS, LEGENDS, AND
- SCHEDULES.
- 6. ALL OUTSIDE CORNERS TO RECEIVE TRANSITION PROFILE
- TR-3 EXCEPT AT CT-13 ACCENT TILE.
 7. PROVIDE 5" ROUND ST. STL. ACCESS PLATE IN WALL AT
- WATER HAMMER ARRESTOR LOCATIONS SEE PLUMBING DWGS & COORDINATE WITH OWNER/ARCHITECT. 8. SEE DRAWING GENERAL NOTES IN A100-SERIES FOR
- ADDITIONAL INFORMATION.

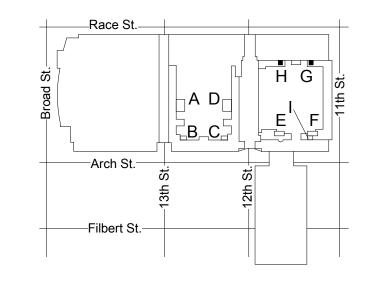

KEY PLAN - LEVEL 100

ARCHITECTURE 331 MONTGOMERY AVE BALA CYNWYD, PA 19144

CONVERSE **WINKLER**

ARCHITECTS: CONVERSE WINKLER ARCHITECTURE 331 Montgomery Avenue, Bala Cynwyd, PA, 19144

Ph: 610.664.0806 Fax: 215.664.1075

Contact: Elin Westrick e-mail: ewestrick@cwarc.com



P (610) 459-7900 F (610) 459-7950 aroraengineers.com


Contact: Kevin Sultanik e-mail: ksultanik@aroraengineers.com

STRUCTURAL ENGINEERS: CSA GROUP 1341 NORTH DELAWARE AVENUE, SUITE 507

PHILADELPHIA, PA 19125

Ph: 215.427.8700 Fax: 215.427.8752

Contact: Wing Au e-mail: wau@csagroup.com

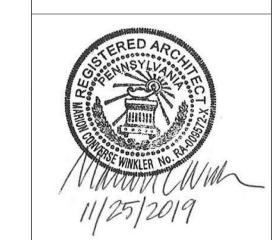

REVISIONS: Description


PENNSYLVANIA CONVENTION CENTER RESTROOM RENOVATIONS
101 ARCH STREET, PHILADELPHIA, PA 191

ELEVATIONS & DETAILS -ROOMS G, H (EXHIBIT)


CW1615 Project number Date November 25, 2019 Author Drawn by Checker Checked by

A503

NTS

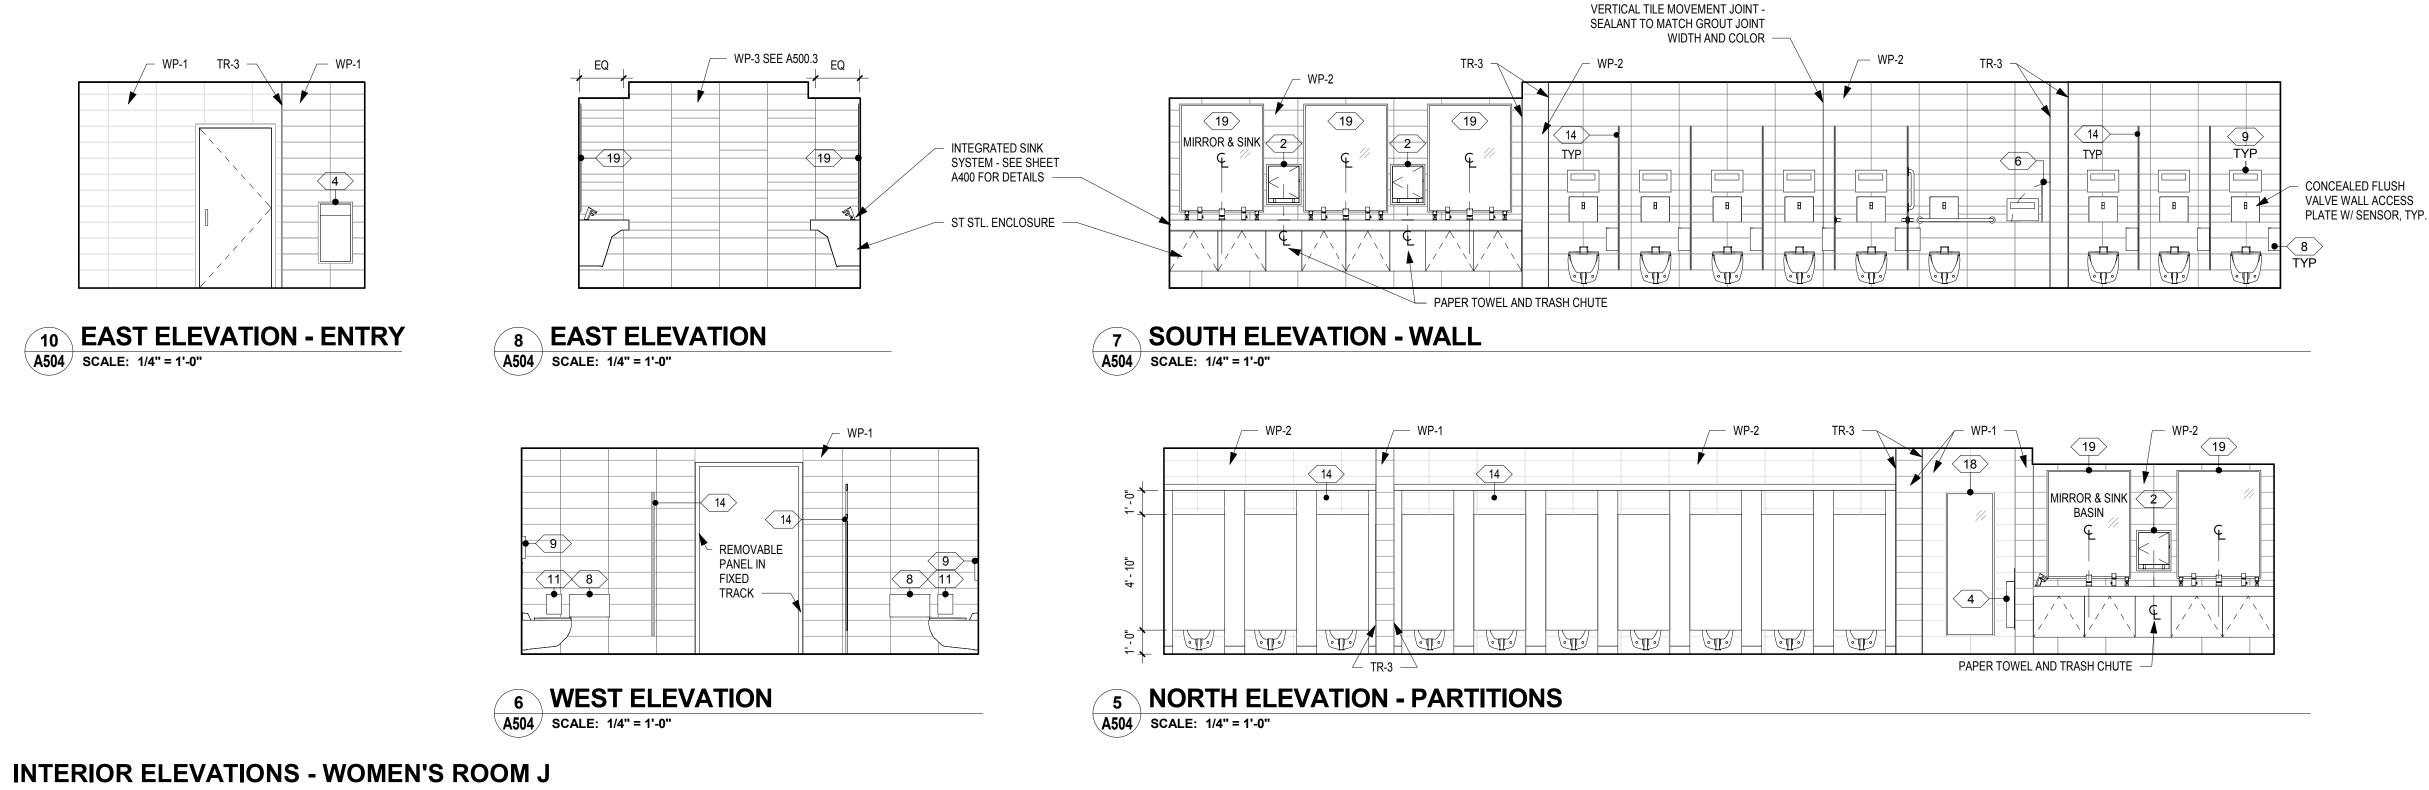




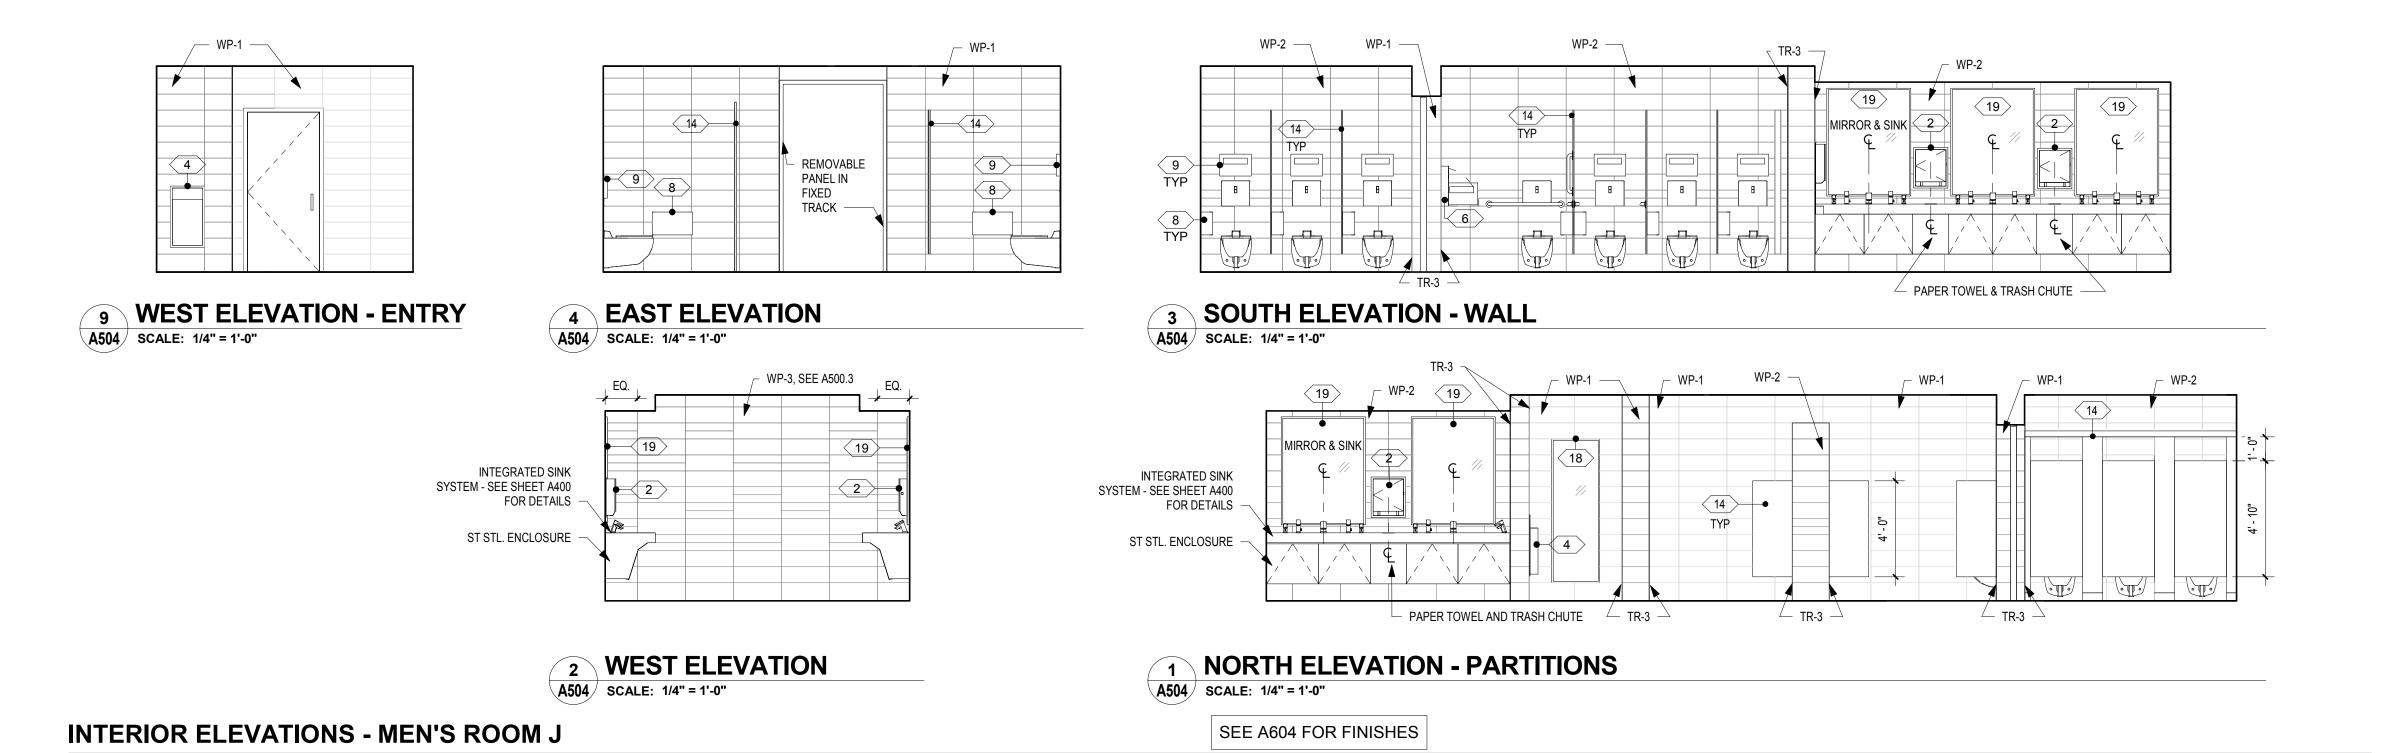

DRAWING GENERAL NOTES

- 1. SEE A500 FOR ACCESSORY / EQUIPMENT LEGEND.
- 2. SEE A500 FOR TYPICAL TOILET COMPARTMENT ELEVATIONS AND ACCESSORY MOUNTING HEIGHTS.
- 3. SEE A500.3 FOR TYPICAL WALL TILE PATTERN DETAILS IN
- EXHIBIT HALL RESTROOMS.

 4. SEE A500.4 FOR TYPICAL ACCENT WALL TILE ELEVATIONS
- IN SEMINAR-TYPE RESTROOMS. 5. SEE A600-SERIES FOR FINISH PLANS, LEGENDS, AND
- SCHEDULES.
- 6. ALL OUTSIDE CORNERS TO RECEIVE TRANSITION PROFILE TR-3 EXCEPT AT CT-13 ACCENT TILE.
- 7. PROVIDE 5" ROUND ST. STL. ACCESS PLATE IN WALL AT WATER HAMMER ARRESTOR LOCATIONS - SEE PLUMBING
- DWGS & COORDINATE WITH OWNER/ARCHITECT. 8. SEE DRAWING GENERAL NOTES IN A100-SERIES FOR ADDITIONAL INFORMATION.

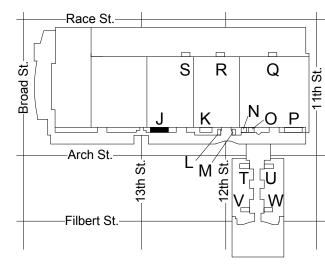

KEY PLAN - LEVEL 200

CONVERSE **WINKLER** ARCHITECTURE 331 MONTGOMERY AVE BALA CYNWYD, PA 19144

ARCHITECTS: CONVERSE WINKLER ARCHITECTURE 331 Montgomery Avenue, Bala Cynwyd, PA, 19144

Ph: 610.664.0806

Contact: Elin Westrick e-mail: ewestrick@cwarc.com

Fax: 215.664.1075

MEP ENGINEERS:



P (610) 459-7900 | F (610) 459-7950 | aroraengineers.com

Contact: Kevin Sultanik e-mail: ksultanik@aroraengineers.com


STRUCTURAL ENGINEERS: CSA GROUP 1341 NORTH DELAWARE AVENUE,

PHILADELPHIA, PA 19125

Ph: 215.427.8700 Fax: 215.427.8752

SUITE 507

Contact: Wing Au e-mail: wau@csagroup.com

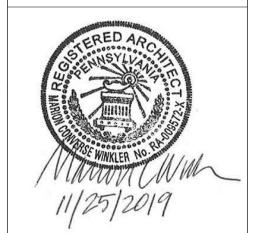

REVISIONS: Description

PENNSYLVANIA CONVENTION CENTER

RESTROOM RENOVATIONS
101 ARCH STREET, PHILADELPHIA, PA 191

ELEVATIONS & DETAILS - ROOM J (EXHIBIT)


CW1615 Project number November 25, 2019 Date LC/KR Drawn by

A504


Checked by

NTS


As indicated

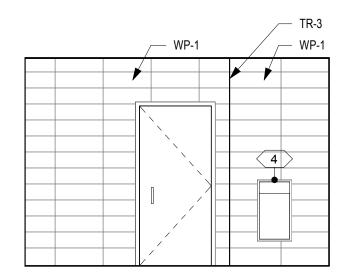




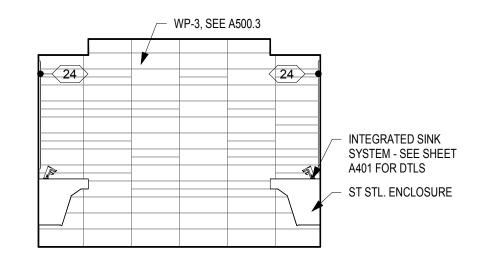




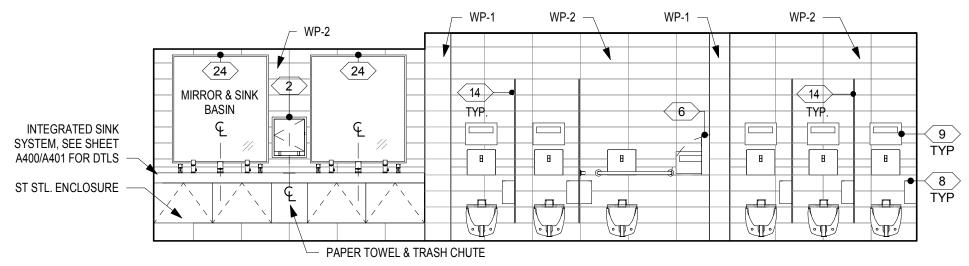



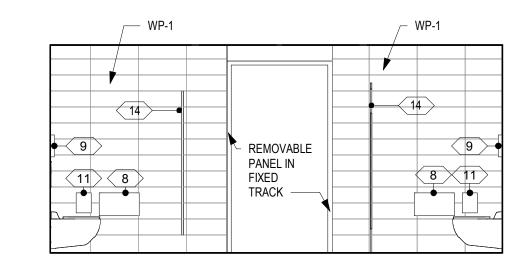



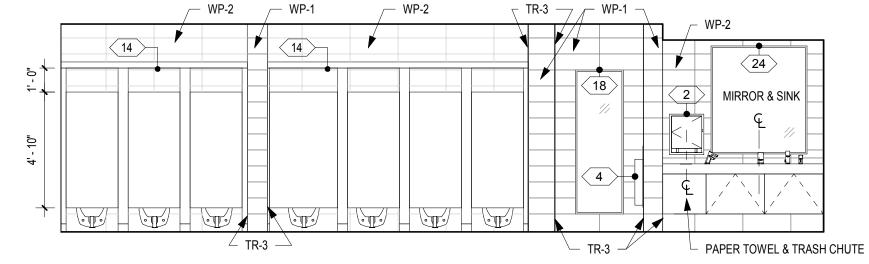


NORTH ELEVATION - PARTITIONS A505 SCALE: 1/4" = 1'-0"


INTERIOR ELEVATIONS - WOMEN'S ROOM K

INTERIOR ELEVATIONS - MEN'S ROOM K


SEE A605 FOR FINISHES

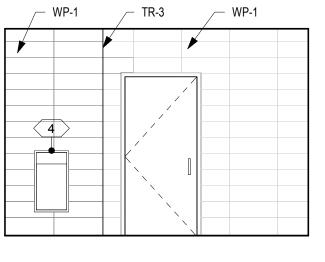



10 WEST ELEVATION - ENTRY A505 SCALE: 1/4" = 1'-0"

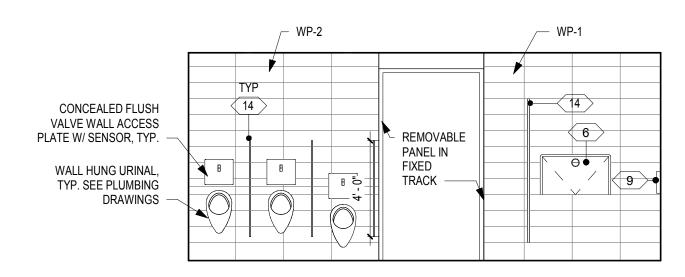

EAST ELEVATION A505 SCALE: 1/4" = 1'-0"

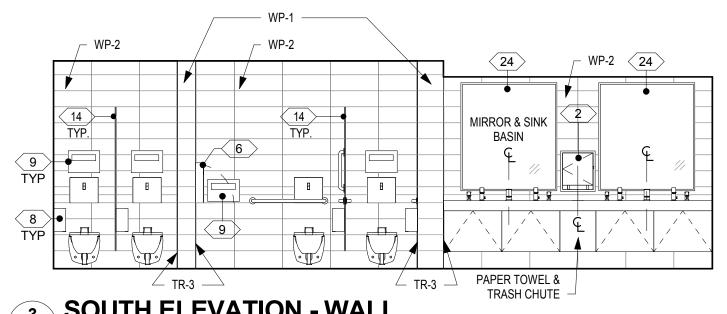

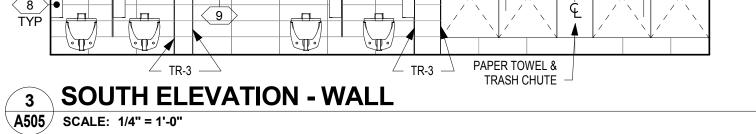

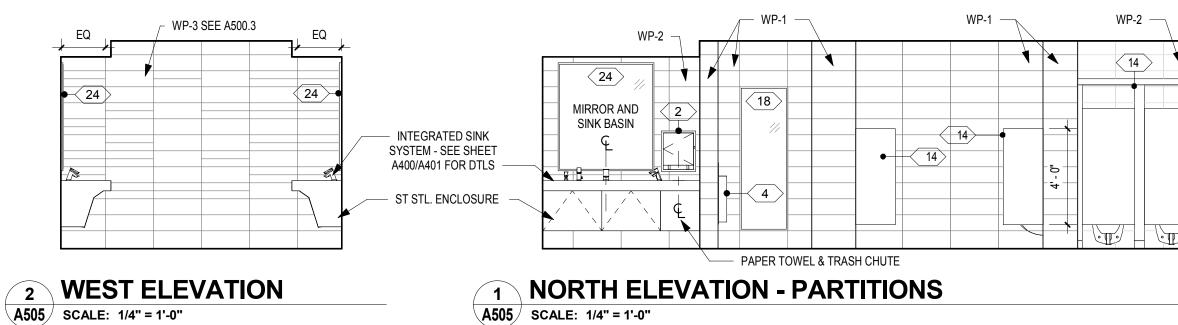

SEE A605 FOR FINISHES

A505 SCALE: 1/4" = 1'-0"

S R Q —Arch St.-

DRAWING GENERAL NOTES

EXHIBIT HALL RESTROOMS.

ADDITIONAL INFORMATION.

IN SEMINAR-TYPE RESTROOMS.

1. SEE A500 FOR ACCESSORY / EQUIPMENT LEGEND. 2. SEE A500 FOR TYPICAL TOILET COMPARTMENT ELEVATIONS AND ACCESSORY MOUNTING HEIGHTS. 3. SEE A500.3 FOR TYPICAL WALL TILE PATTERN DETAILS IN

4. SEE A500.4 FOR TYPICAL ACCENT WALL TILE ELEVATIONS

6. ALL OUTSIDE CORNERS TO RECEIVE TRANSITION PROFILE TR-3 EXCEPT AT CT-13 ACCENT TILE.
7. PROVIDE 5" ROUND ST. STL. ACCESS PLATE IN WALL AT

WATER HAMMER ARRESTOR LOCATIONS - SEE PLUMBING DWGS & COORDINATE WITH OWNER/ARCHITECT.

5. SEE A600-SERIES FOR FINISH PLANS, LEGENDS, AND

8. SEE DRAWING GENERAL NOTES IN A100-SERIES FOR

KEY PLAN - LEVEL 200

—Filbert St.-

CONVERSE **WINKLER** ARCHITECTURE 331 MONTGOMERY AVE BALA CYNWYD, PA 19144

ARCHITECTS: CONVERSE WINKLER ARCHITECTURE 331 Montgomery Avenue, Bala Cynwyd, PA, 19144

Fax: 215.664.1075

Ph: 610.664.0806

Contact: Elin Westrick e-mail: ewestrick@cwarc.com

MEP ENGINEERS:



P (610) 459-7900 F (610) 459-7950 aroraengineers.com


Contact: Kevin Sultanik e-mail: ksultanik@aroraengineers.com

STRUCTURAL ENGINEERS:

CSA GROUP 1341 NORTH DELAWARE AVENUE, SUITE 507 PHILADELPHIA, PA 19125

Ph: 215.427.8700 Fax: 215.427.8752

Contact: Wing Au e-mail: wau@csagroup.com

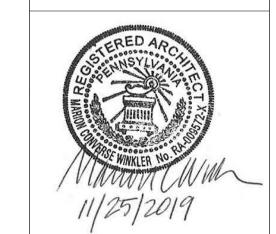

REVISIONS:		
No.	Description	Date

PENNSYLVANIA CONVENTION CENTER RESTROOM RENOVATIONS
101 ARCH STREET, PHILADELPHIA, PA 191


ELEVATIONS & DETAILS - ROOM K (EXHIBIT)


CW1615 Project number November 25, 2019 Date KR/LC Drawn by EW Checked by

A505

As indicated

NTS

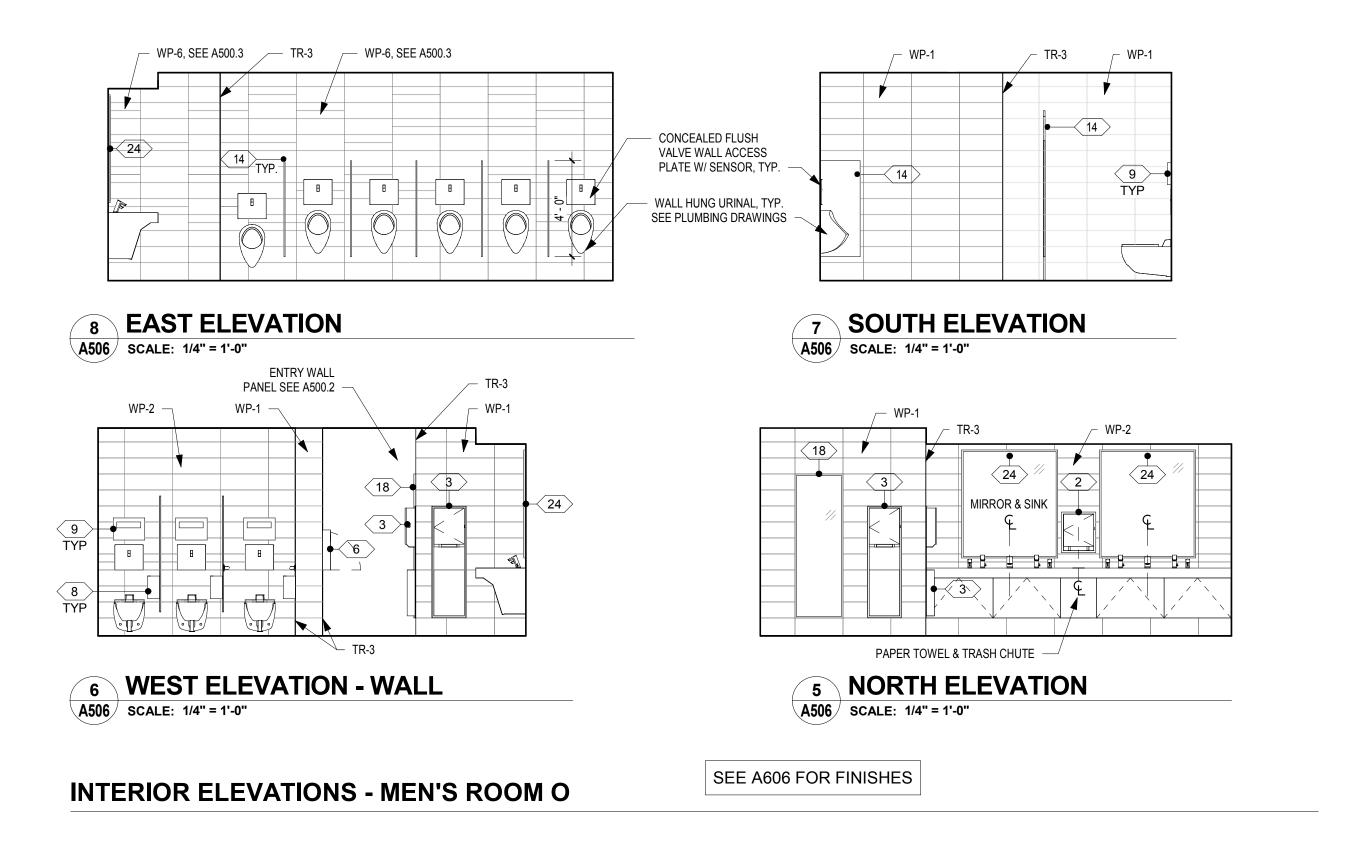

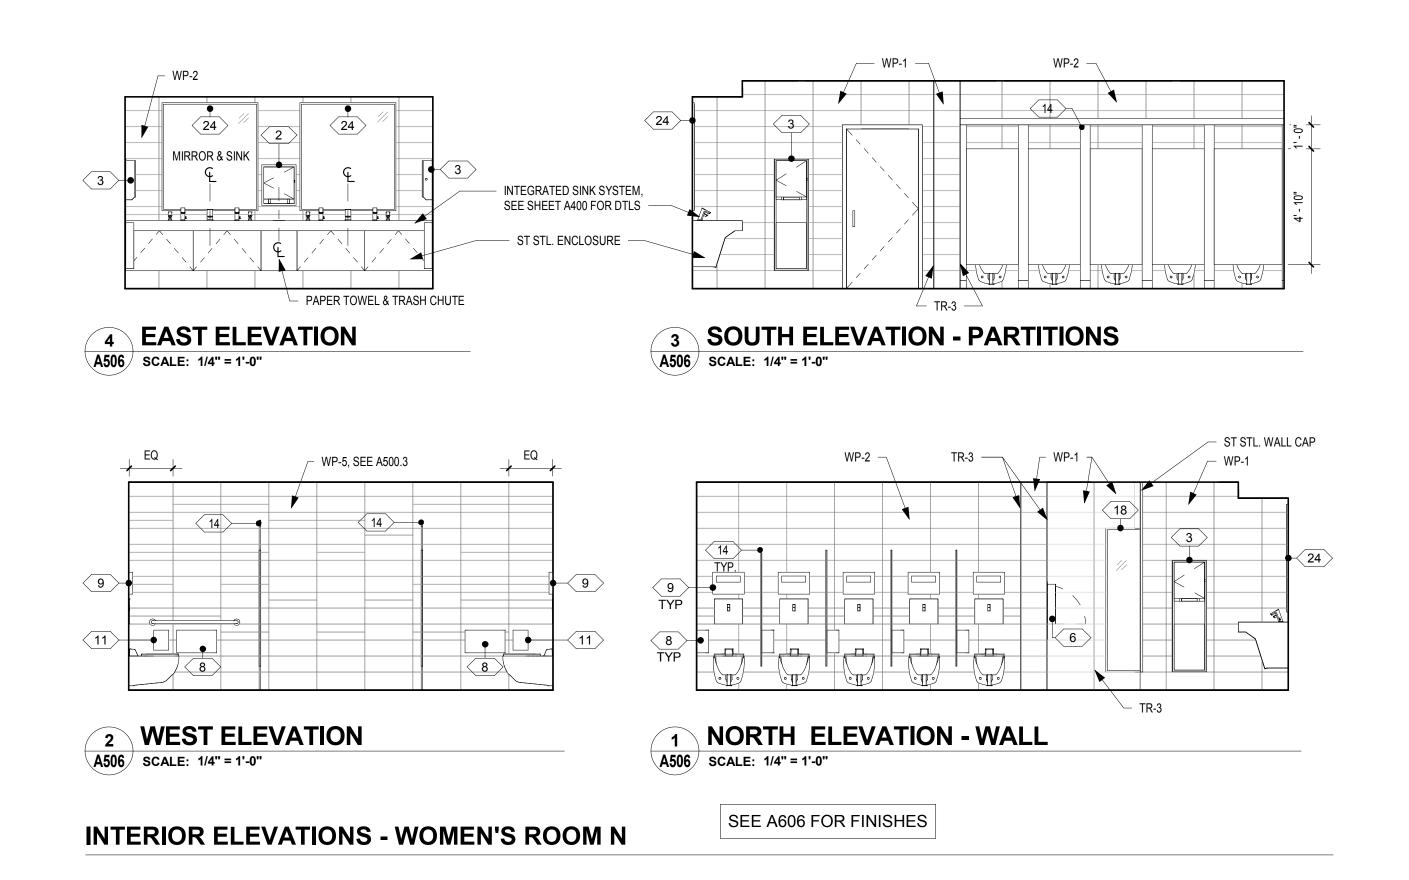


DRAWING GENERAL NOTES

- SEE A500 FOR ACCESSORY / EQUIPMENT LEGEND.
 SEE A500 FOR TYPICAL TOILET COMPARTMENT
- ELEVATIONS AND ACCESSORY MOUNTING HEIGHTS. 3. SEE A500.3 FOR TYPICAL WALL TILE PATTERN DETAILS IN
- EXHIBIT HALL RESTROOMS.
- 4. SEE A500.4 FOR TYPICAL ACCENT WALL TILE ELEVATIONS IN SEMINAR-TYPE RESTROOMS.
- 5. SEE A600-SERIES FOR FINISH PLANS, LEGENDS, AND
- SCHEDULES. 6. ALL OUTSIDE CORNERS TO RECEIVE TRANSITION PROFILE
- TR-3 EXCEPT AT CT-13 ACCENT TILE.

 7. PROVIDE 5" ROUND ST. STL. ACCESS PLATE IN WALL AT
- WATER HAMMER ARRESTOR LOCATIONS SEE PLUMBING DWGS & COORDINATE WITH OWNER/ARCHITECT.

 8. SEE DRAWING GENERAL NOTES IN A100-SERIES FOR
- ADDITIONAL INFORMATION.

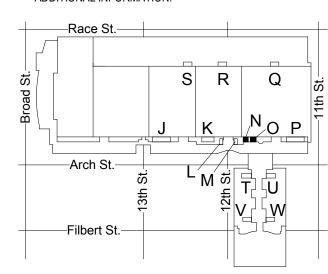

KEY PLAN - LEVEL 200

CONVERSE **WINKLER** ARCHITECTURE 331 MONTGOMERY AVE BALA CYNWYD, PA 19144

ARCHITECTS:
CONVERSE WINKLER ARCHITECTURE 331 Montgomery Avenue, Bala Cynwyd, PA, 19144

Ph: 610.664.0806 Fax: 215.664.1075

Contact: Elin Westrick e-mail: ewestrick@cwarc.com

MEP ENGINEERS:



P (610) 459-7900 | F (610) 459-7950 | aroraengineers.com


Contact: Kevin Sultanik e-mail: ksultanik@aroraengineers.com

STRUCTURAL ENGINEERS: **CSA GROUP** 1341 NORTH DELAWARE AVENUE,

SUITE 507 PHILADELPHIA, PA 19125

Ph: 215.427.8700 Fax: 215.427.8752

Contact: Wing Au e-mail: wau@csagroup.com

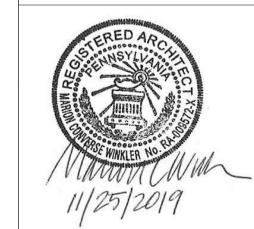

REVISIONS: Description


PENNSYLVANIA CONVENTION CENTER RESTROOM RENOVATIONS
101 ARCH STREET, PHILADELPHIA, PA 191

ELEVATIONS & DETAILS -ROOMS N, O (EXHIBIT)

CW1615 Project number November 25, 2019 Date LC/KR Drawn by EW Checked by

A506

NTS

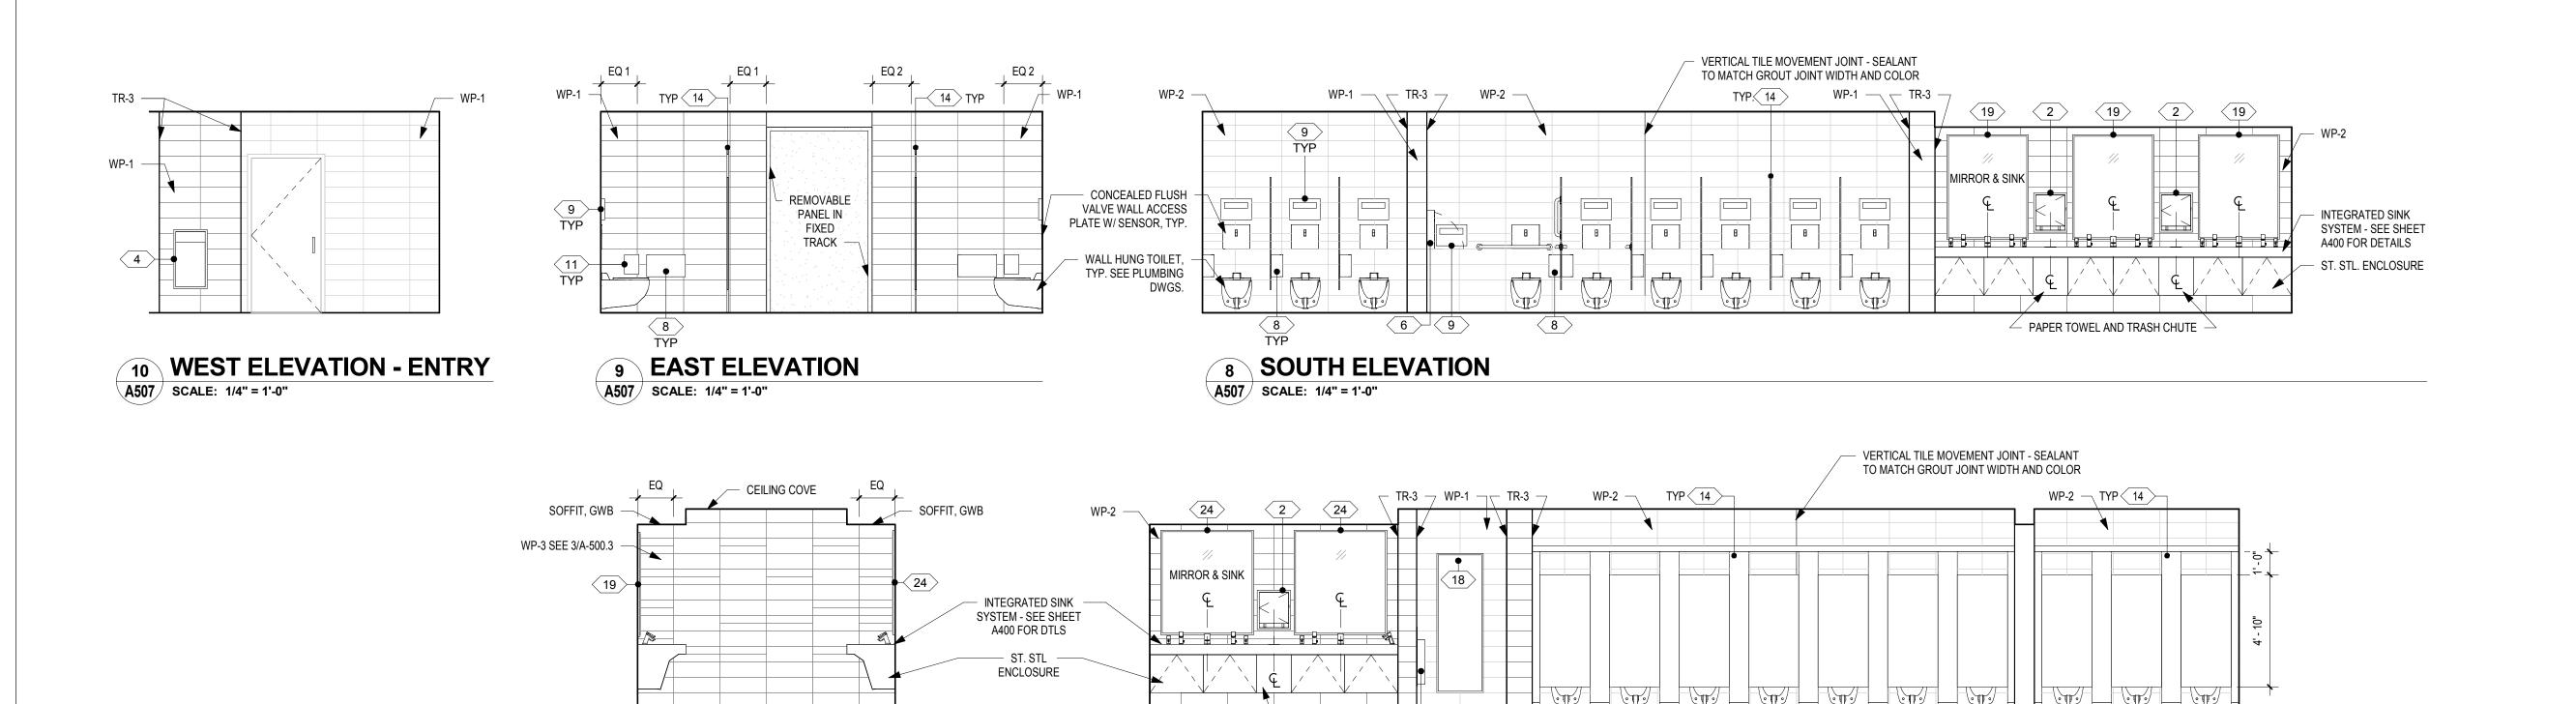

INTERIOR ELEVATIONS - WOMEN'S ROOM P

7 WEST ELEVATION - SINK


A507 | SCALE: 1/4" = 1'-0"

SEE A607 FOR FINISHES

A507 SCALE: 1/4" = 1'-0"

PAPER TOWEL
AND TRASH CHUTE

NORTH ELEVATION

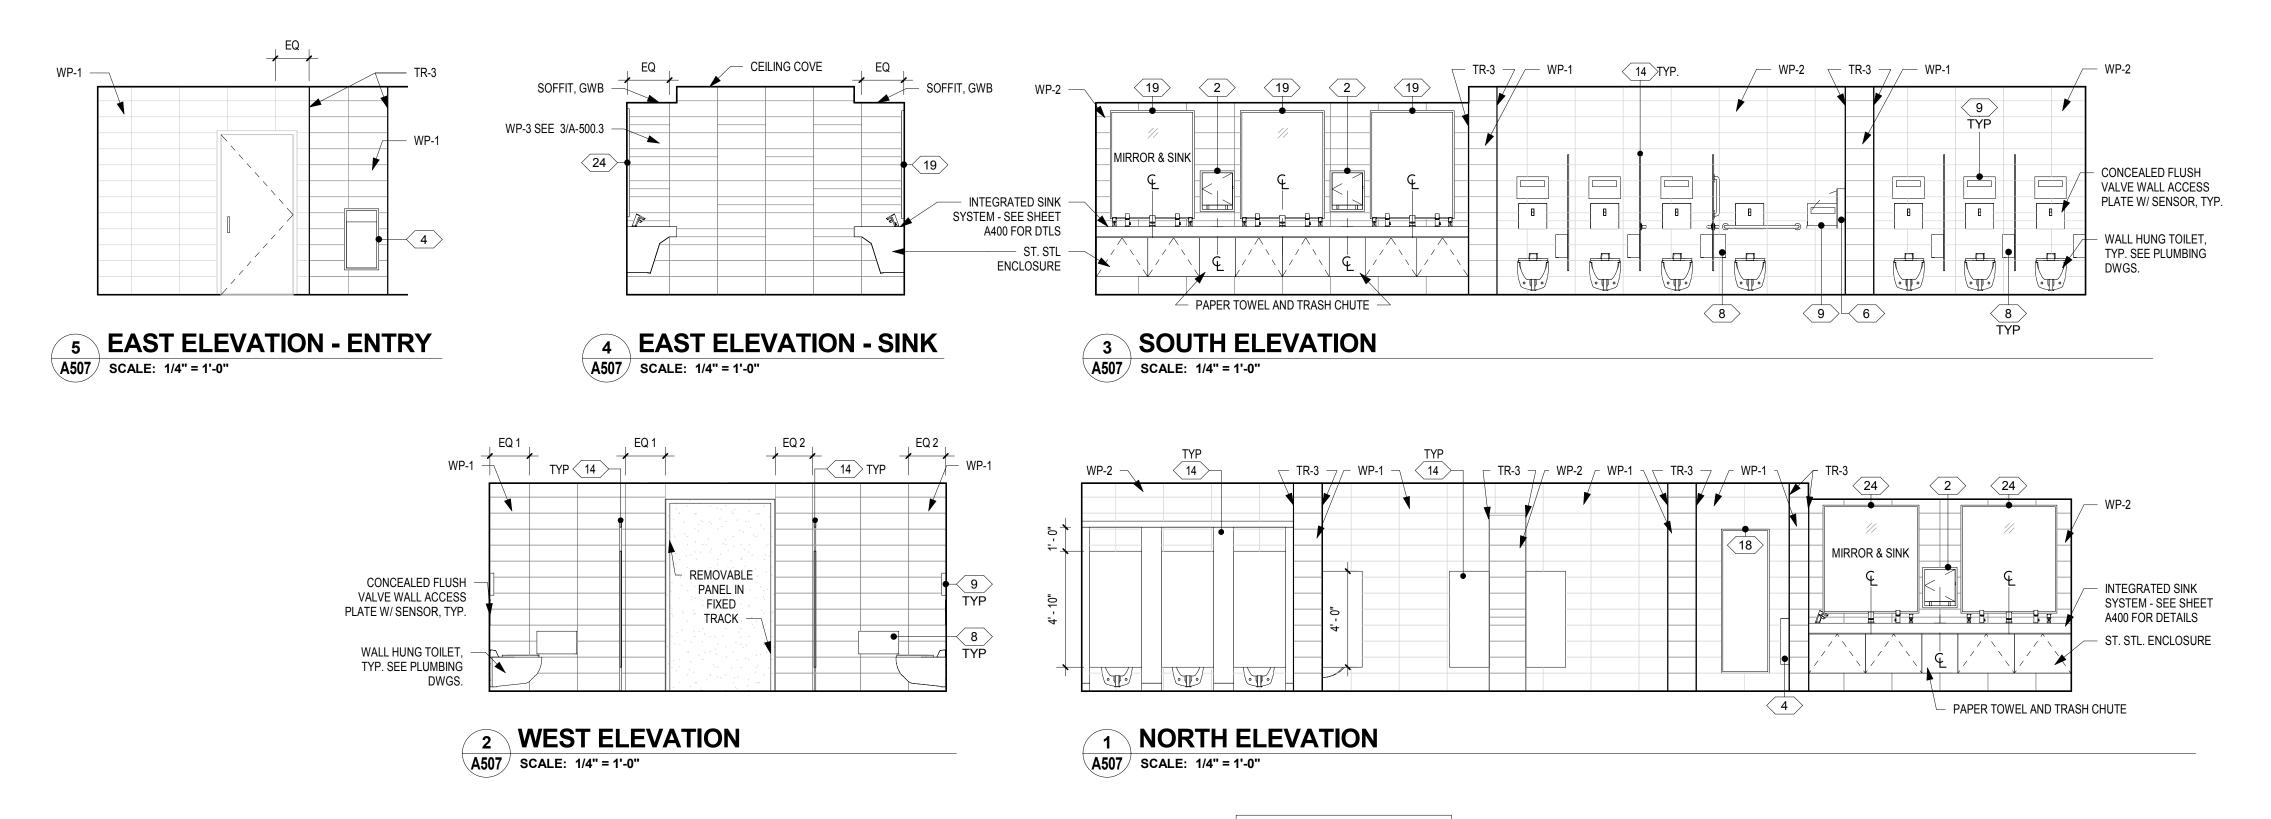


INTERIOR ELEVATIONS - MEN'S ROOM P

SEE A607 FOR FINISHES

DRAWING GENERAL NOTES

- 1. SEE A500 FOR ACCESSORY / EQUIPMENT LEGEND.
- 2. SEE A500 FOR TYPICAL TOILET COMPARTMENT ELEVATIONS AND ACCESSORY MOUNTING HEIGHTS.
- ELEVATIONS AND ACCESSORY MOUNTING HEIGHTS.

 3. SEE A500.3 FOR TYPICAL WALL TILE PATTERN DETAILS IN
- EXHIBIT HALL RESTROOMS.
 4. SEE A500.4 FOR TYPICAL ACCENT WALL TILE ELEVATIONS
- IN SEMINAR-TYPE RESTROOMS.
- 5. SEE A600-SERIES FOR FINISH PLANS, LEGENDS, AND
- SCHEDULES.
 6. ALL OUTSIDE CORNERS TO RECEIVE TRANSITION PROFILE
- TR-3 EXCEPT AT CT-13 ACCENT TILE.
 7. PROVIDE 5" ROUND ST. STL. ACCESS PLATE IN WALL AT
- WATER HAMMER ARRESTOR LOCATIONS SEE PLUMBING DWGS & COORDINATE WITH OWNER/ARCHITECT.
- 8. SEE DRAWING GENERAL NOTES IN A100-SERIES FOR ADDITIONAL INFORMATION.

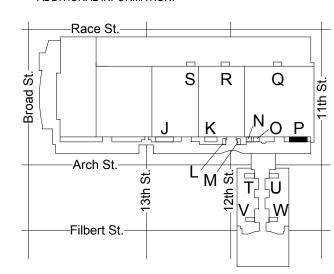

NTS

KEY PLAN - LEVEL 200

CONVERSE
WINKLER
ARCHITECTURE
331 MONTGOMERY AVE
BALA CYNWYD, PA 19144

ARCHITECTS: CONVERSE WINKLER ARCHITECTURE 331 Montgomery Avenue, Bala Cynwyd, PA, 19144

Bala Cynwyd, PA, 19
Ph: 610.664.0806
Fax: 215.664.1075

Contact: Elin Westrick e-mail: ewestrick@cwarc.com

MEP ENGINEERS:

Arora Engineers, Inc.
61 Wilmington-West Chester F
Chadds Ford, PA 19317

Chadds Ford, PA 19317

P (610) 459-7900 | F (610) 459-7950 | aroraengineers.com

Contact: Kevin Sultanik
e-mail: ksultanik@aroraengineers.com


STRUCTURAL ENGINEERS: CSA GROUP 1341 NORTH DELAWARE AVENUE,

PHILADELPHIA, PA 19125

Ph: 215.427.8700 Fax: 215.427.8752

SUITE 507

Contact: Wing Au e-mail: wau@csagroup.com

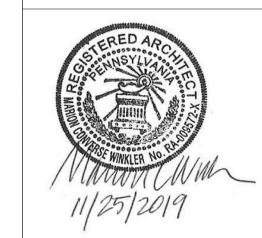

REVISIONS:

No. Description Date

PENNSYLVANIA
CONVENTION CENTER
RESTROOM RENOVATIONS
1101 ARCH STREET, PHILADELPHIA, PA 19107

ELEVATIONS &
DETAILS - ROOM
P (EXHIBIT)

Project number CW1615

Date November 25, 2019


Drawn by LC/KR


EW

A507

Checked by


le As indicated

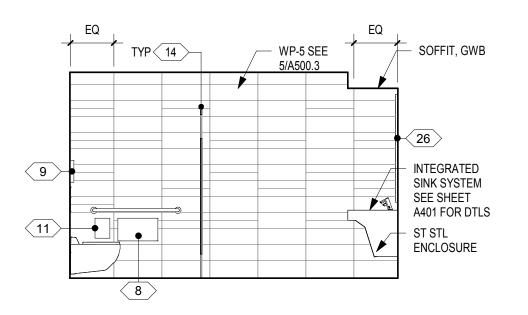


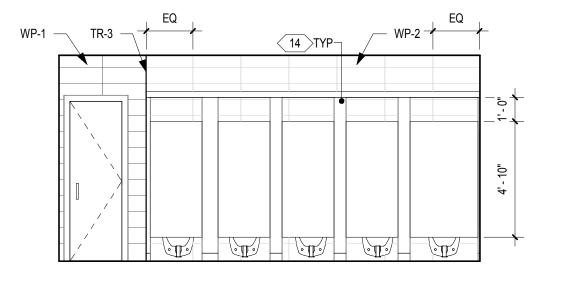






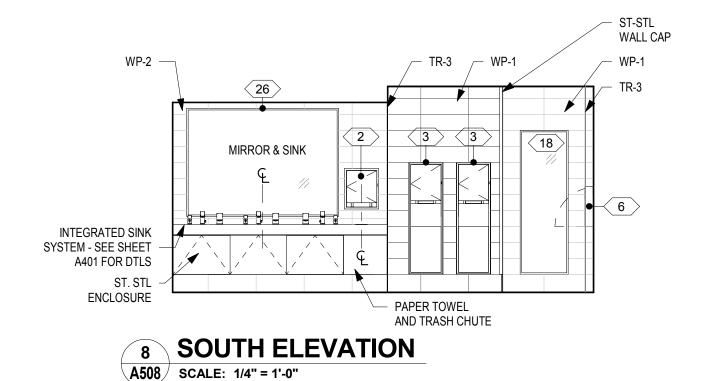

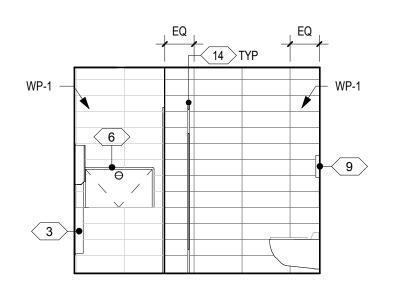

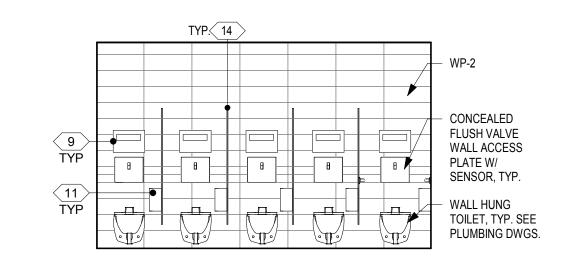



WEST ELEVATION A508 SCALE: 1/4" = 1'-0"

6 NORTH ELEVATION - WALL A508 SCALE: 1/4" = 1'-0"

INTERIOR ELEVATIONS - WOMEN'S ROOM Q


SEE A608 FOR FINISHES

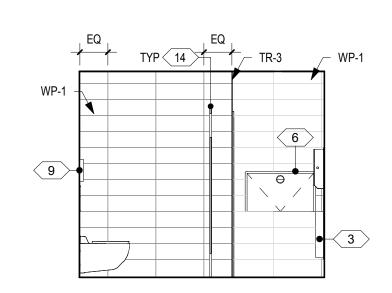

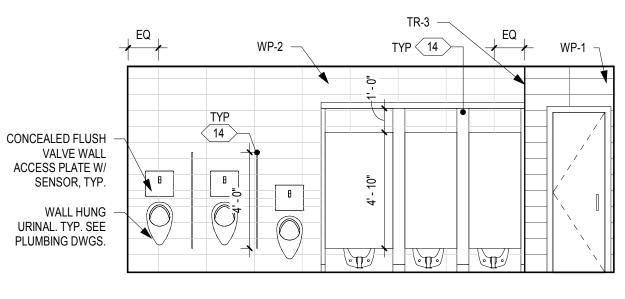


EAST ELEVATION A508 SCALE: 1/4" = 1'-0"



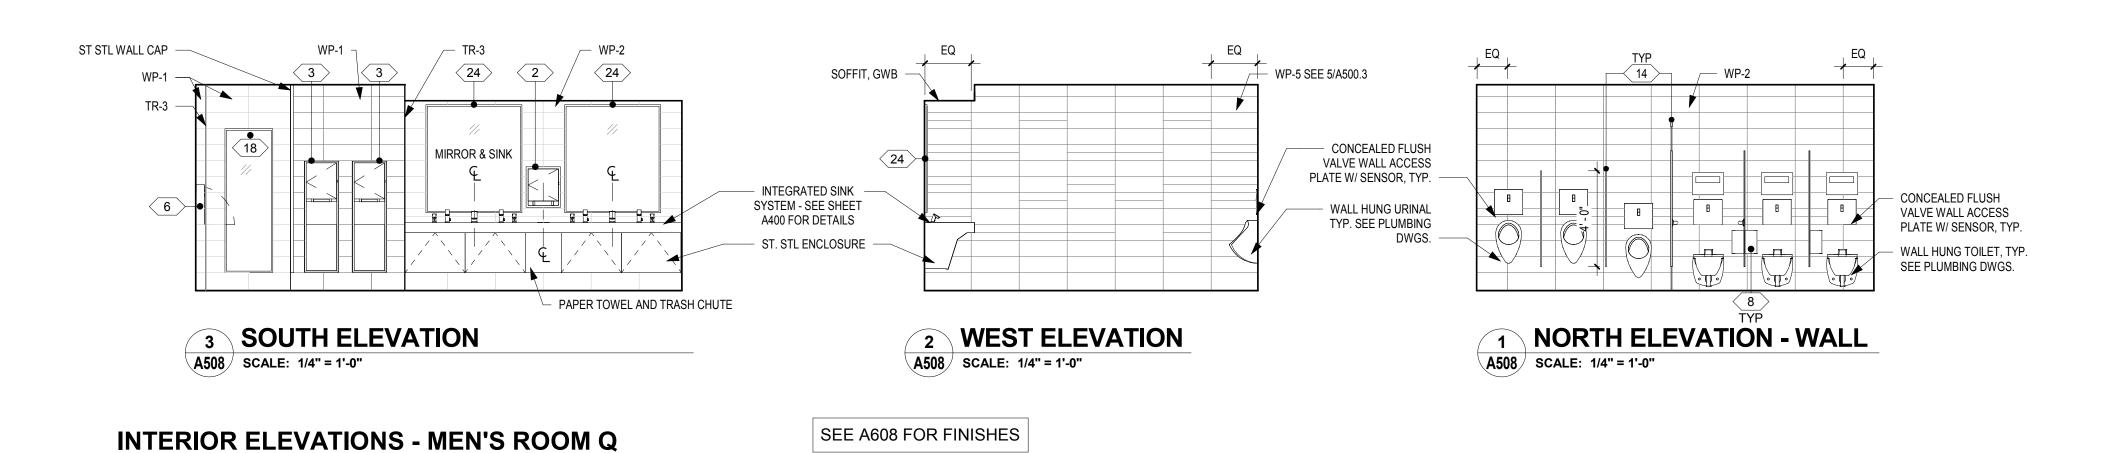

DRAWING GENERAL NOTES

- 1. SEE A500 FOR ACCESSORY / EQUIPMENT LEGEND.
- 2. SEE A500 FOR TYPICAL TOILET COMPARTMENT
- ELEVATIONS AND ACCESSORY MOUNTING HEIGHTS. 3. SEE A500.3 FOR TYPICAL WALL TILE PATTERN DETAILS IN
- EXHIBIT HALL RESTROOMS. 4. SEE A500.4 FOR TYPICAL ACCENT WALL TILE ELEVATIONS
- IN SEMINAR-TYPE RESTROOMS. 5. SEE A600-SERIES FOR FINISH PLANS, LEGENDS, AND
- SCHEDULES.
- 6. ALL OUTSIDE CORNERS TO RECEIVE TRANSITION PROFILE TR-3 EXCEPT AT CT-13 ACCENT TILE.
- 7. PROVIDE 5" ROUND ST. STL. ACCESS PLATE IN WALL AT WATER HAMMER ARRESTOR LOCATIONS - SEE PLUMBING
- DWGS & COORDINATE WITH OWNER/ARCHITECT. 8. SEE DRAWING GENERAL NOTES IN A100-SERIES FOR
- ADDITIONAL INFORMATION.

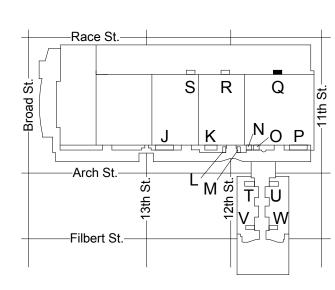

KEY PLAN - LEVEL 200

CONVERSE **WINKLER** ARCHITECTURE 331 MONTGOMERY AVE BALA CYNWYD, PA 19144

ARCHITECTS: CONVERSE WINKLER ARCHITECTURE 331 Montgomery Avenue, Bala Cynwyd, PA, 19144

Ph: 610.664.0806 Fax: 215.664.1075

Contact: Elin Westrick e-mail: ewestrick@cwarc.com

MEP ENGINEERS:



P (610) 459-7900 F (610) 459-7950 aroraengineers.com

Contact: Kevin Sultanik e-mail: ksultanik@aroraengineers.com

STRUCTURAL ENGINEERS: CSA GROUP 1341 NORTH DELAWARE AVENUE,

PHILADELPHIA, PA 19125

Ph: 215.427.8700 Fax: 215.427.8752

SUITE 507

Contact: Wing Au e-mail: wau@csagroup.com



REVISIONS: Description Date

PENNSYLVANIA CONVENTION CENTER


RESTROOM RENOVATIONS
101 ARCH STREET, PHILADELPHIA, PA 191 **ELEVATIONS & DETAILS - ROOM** Q (EXHIBIT)


CW1615 Project number November 25, 2019 Date LC/KR Drawn by

Checked by A508

NTS


As indicated

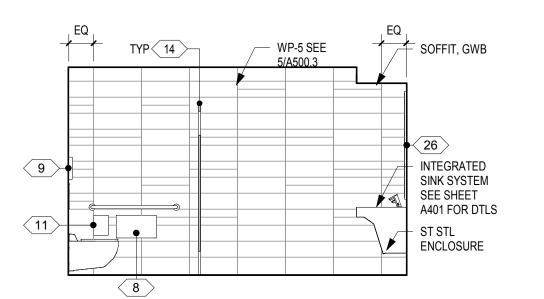


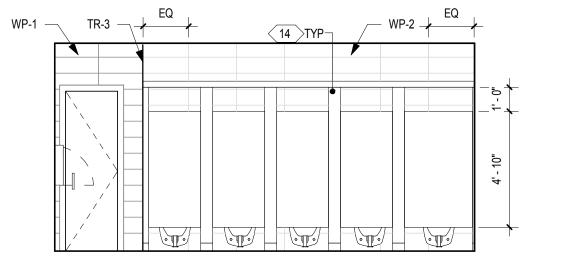


10 EAST ELEVATION A509 SCALE: 1/4" = 1'-0"



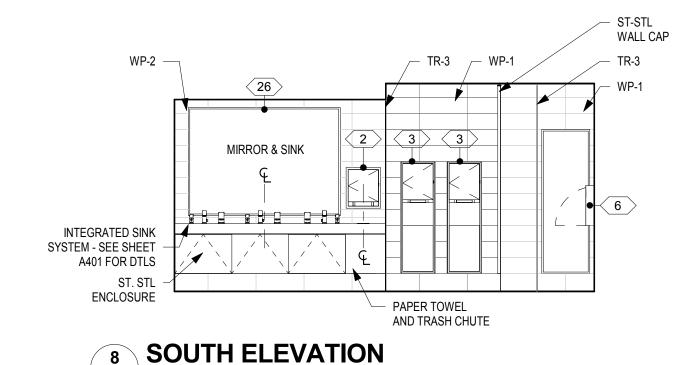

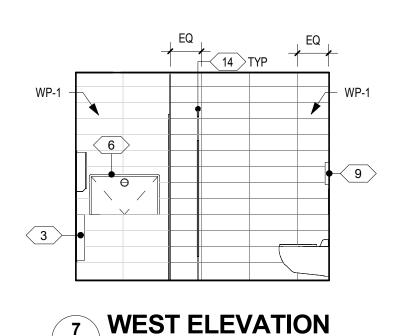

A509 SCALE: 1/4" = 1'-0"

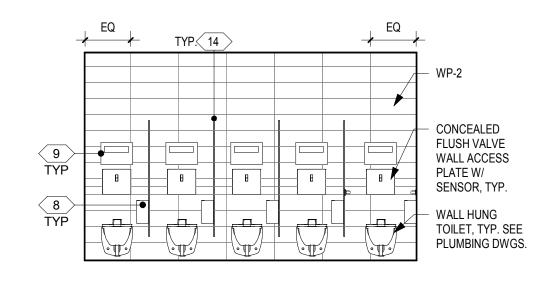



6 NORTH ELEVATION - WALL A509 SCALE: 1/4" = 1'-0"

INTERIOR ELEVATIONS - WOMEN'S ROOM R

A509 SCALE: 1/4" = 1'-0"


SEE A609 FOR FINISHES

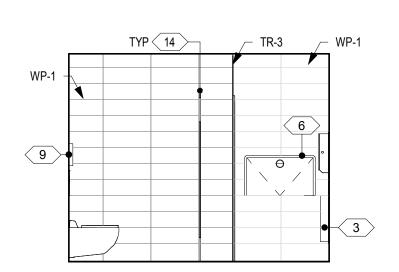

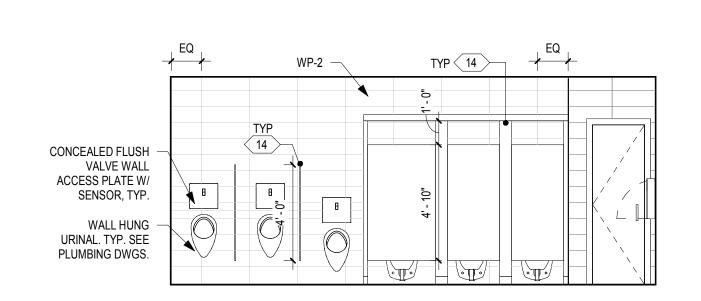

EAST ELEVATION A509 SCALE: 1/4" = 1'-0"



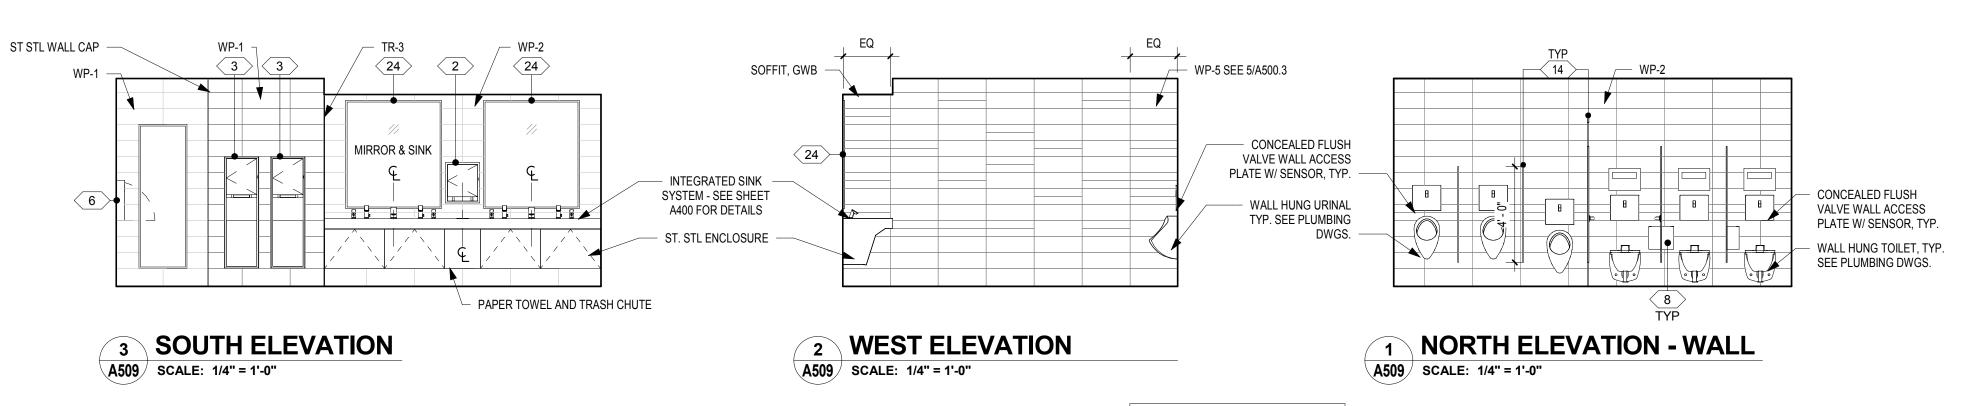


INTERIOR ELEVATIONS - MEN'S ROOM R

SEE A609 FOR FINISHES

DRAWING GENERAL NOTES

- 1. SEE A500 FOR ACCESSORY / EQUIPMENT LEGEND. 2. SEE A500 FOR TYPICAL TOILET COMPARTMENT
- ELEVATIONS AND ACCESSORY MOUNTING HEIGHTS.
- 3. SEE A500.3 FOR TYPICAL WALL TILE PATTERN DETAILS IN EXHIBIT HALL RESTROOMS.
- 4. SEE A500.4 FOR TYPICAL ACCENT WALL TILE ELEVATIONS IN SEMINAR-TYPE RESTROOMS.
- 5. SEE A600-SERIES FOR FINISH PLANS, LEGENDS, AND
- SCHEDULES.
- 6. ALL OUTSIDE CORNERS TO RECEIVE TRANSITION PROFILE TR-3 EXCEPT AT CT-13 ACCENT TILE.
- 7. PROVIDE 5" ROUND ST. STL. ACCESS PLATE IN WALL AT WATER HAMMER ARRESTOR LOCATIONS - SEE PLUMBING DWGS & COORDINATE WITH OWNER/ARCHITECT.
- 8. SEE DRAWING GENERAL NOTES IN A100-SERIES FOR ADDITIONAL INFORMATION.

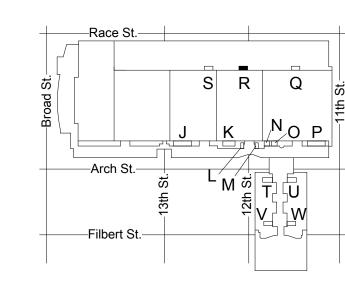

KEY PLAN - LEVEL 200

CONVERSE **WINKLER** ARCHITECTURE 331 MONTGOMERY AVE BALA CYNWYD, PA 19144

ARCHITECTS:CONVERSE WINKLER ARCHITECTURE 331 Montgomery Avenue, Bala Cynwyd, PA, 19144

Ph: 610.664.0806 Fax: 215.664.1075

Contact: Elin Westrick e-mail: ewestrick@cwarc.com

MEP ENGINEERS:



P (610) 459-7900 | F (610) 459-7950 | aroraengineers.com

Contact: Kevin Sultanik


e-mail: ksultanik@aroraengineers.com

STRUCTURAL ENGINEERS: CSA GROUP 1341 NORTH DELAWARE AVENUE, SUITE 507

PHILADELPHIA, PA 19125

Ph: 215.427.8700 Fax: 215.427.8752

Contact: Wing Au e-mail: wau@csagroup.com

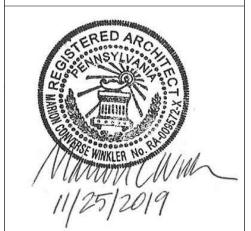

REVISIONS: Description

PENNSYLVANIA CONVENTION CENTER RESTROOM RENOVATIONS
101 ARCH STREET, PHILADELPHIA, PA 191


ELEVATIONS & DETAILS - ROOM R (EXHIBIT)


CW1615 Project number November 25, 2019 Date LC/KR Drawn by

EW

Checked by A509


NTS

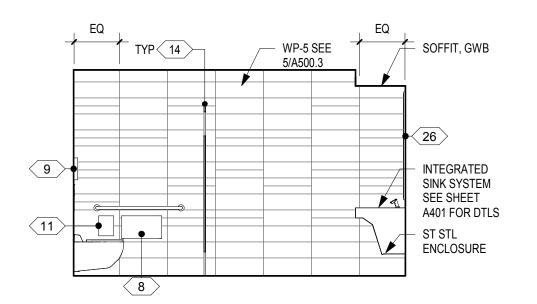


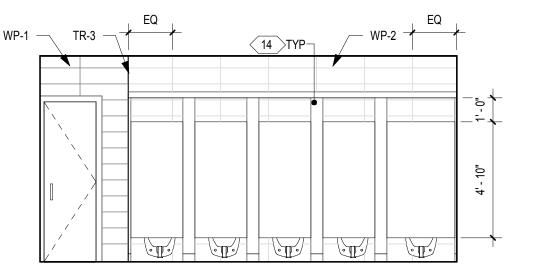


10 EAST ELEVATION A510 SCALE: 1/4" = 1'-0"

NORTH ELEVATION - PARTITIONS A510 SCALE: 1/4" = 1'-0"

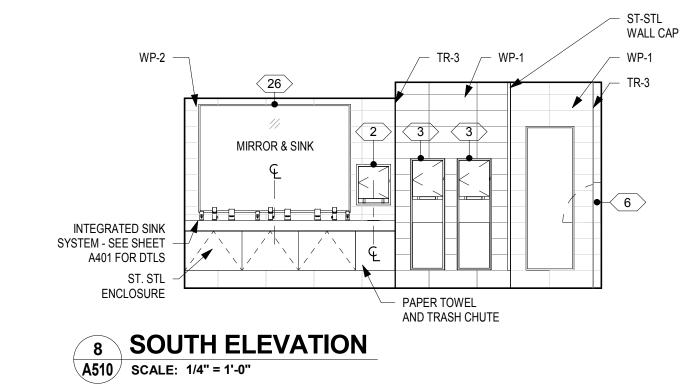

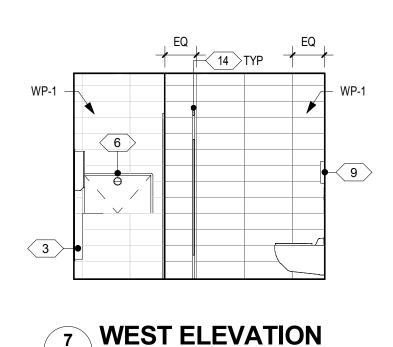

A510 SCALE: 1/4" = 1'-0"

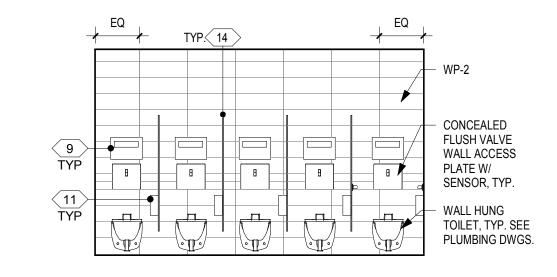


6 NORTH ELEVATION - WALL A510 SCALE: 1/4" = 1'-0"

INTERIOR ELEVATIONS - WOMEN'S ROOM S

INTERIOR ELEVATIONS - MEN'S ROOM S

SEE A610 FOR FINISHES


SEE A610 FOR FINISHES

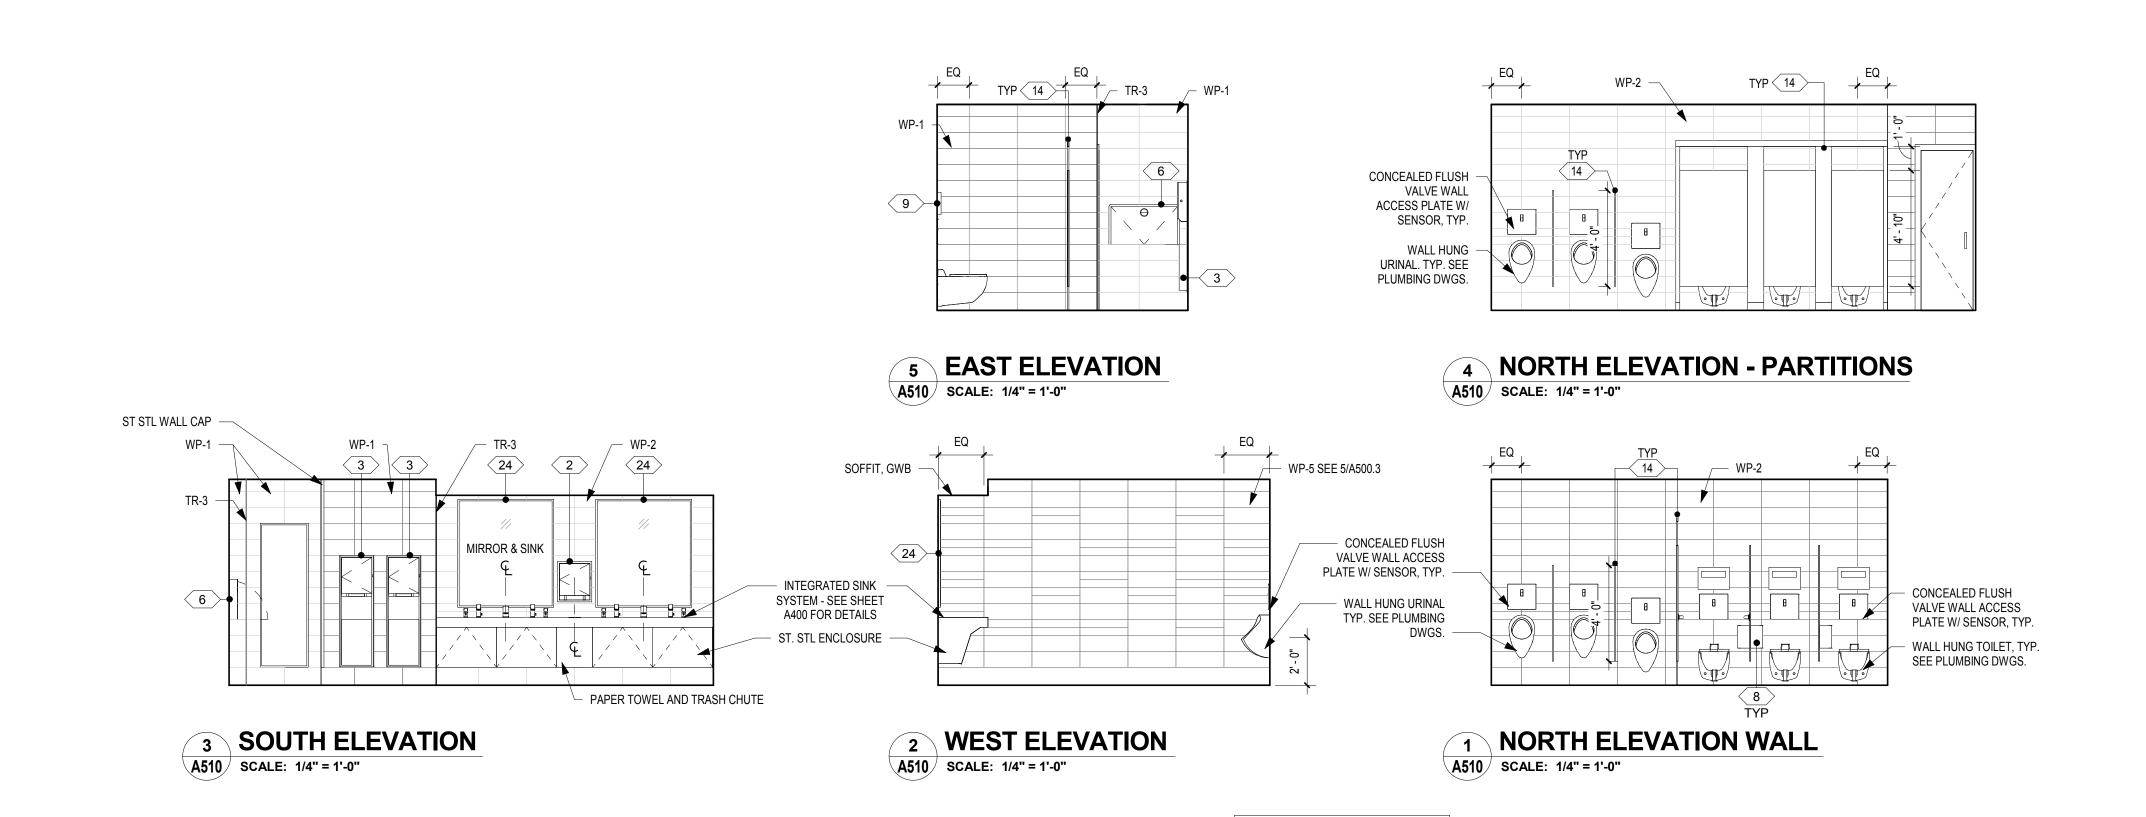

DRAWING GENERAL NOTES

- 1. SEE A500 FOR ACCESSORY / EQUIPMENT LEGEND. 2. SEE A500 FOR TYPICAL TOILET COMPARTMENT
- ELEVATIONS AND ACCESSORY MOUNTING HEIGHTS.
- 3. SEE A500.3 FOR TYPICAL WALL TILE PATTERN DETAILS IN EXHIBIT HALL RESTROOMS. 4. SEE A500.4 FOR TYPICAL ACCENT WALL TILE ELEVATIONS IN SEMINAR-TYPE RESTROOMS.
- 5. SEE A600-SERIES FOR FINISH PLANS, LEGENDS, AND
- SCHEDULES.
- 6. ALL OUTSIDE CORNERS TO RECEIVE TRANSITION PROFILE
- TR-3 EXCEPT AT CT-13 ACCENT TILE.

 7. PROVIDE 5" ROUND ST. STL. ACCESS PLATE IN WALL AT WATER HAMMER ARRESTOR LOCATIONS - SEE PLUMBING
- DWGS & COORDINATE WITH OWNER/ARCHITECT. 8. SEE DRAWING GENERAL NOTES IN A100-SERIES FOR
- ADDITIONAL INFORMATION.

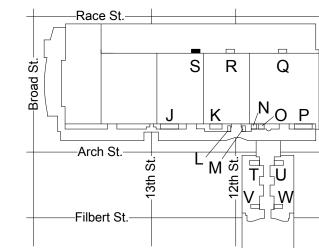

KEY PLAN - LEVEL 200

NTS

November 25, 2019 Date LC/KR Drawn by EW

Project number

A510

As indicated

CW1615

ARCHITECTS:CONVERSE WINKLER ARCHITECTURE 331 Montgomery Avenue, Bala Cynwyd, PA, 19144 Ph: 610.664.0806 Fax: 215.664.1075

CONVERSE **WINKLER** ARCHITECTURE

331 MONTGOMERY AVE BALA CYNWYD, PA 19144

Contact: Elin Westrick e-mail: ewestrick@cwarc.com

MEP ENGINEERS:



P (610) 459-7900 | F (610) 459-7950 | aroraengineers.com


Contact: Kevin Sultanik e-mail: ksultanik@aroraengineers.com

STRUCTURAL ENGINEERS: CSA GROUP 1341 NORTH DELAWARE AVENUE, SUITE 507

PHILADELPHIA, PA 19125

Ph: 215.427.8700 Fax: 215.427.8752

Contact: Wing Au e-mail: wau@csagroup.com

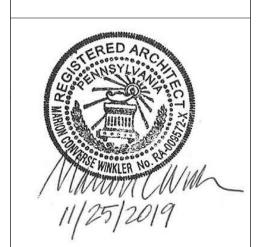


REVISIONS: Description


PENNSYLVANIA CONVENTION CENTER


RESTROOM RENOVATIONS
101 ARCH STREET, PHILADELPHIA, PA 191

ELEVATIONS & DETAILS - ROOM S (EXHIBIT)

Checked by

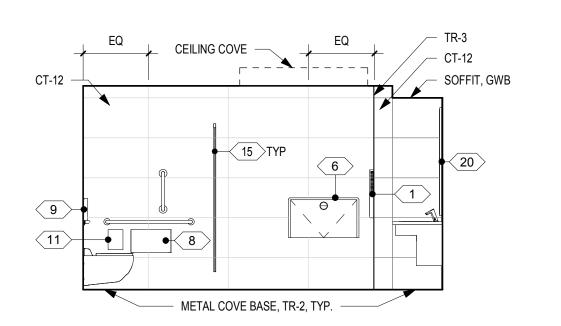

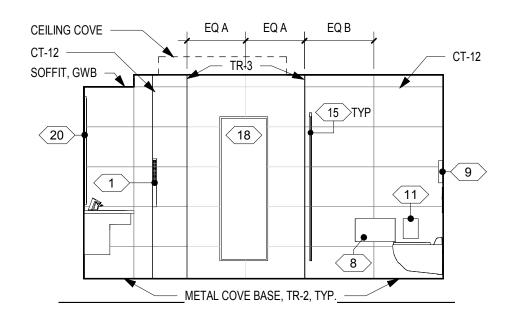

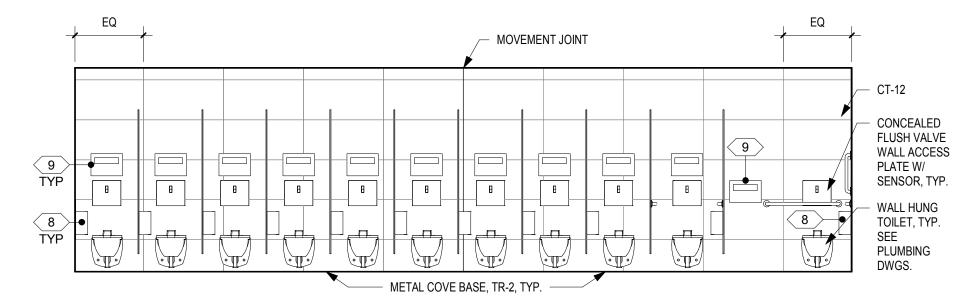



12 EAST ELEVATION A511 SCALE: 1/4" = 1'-0"

11 WEST ELEVATION A511 SCALE: 1/4" = 1'-0"

10 NORTH ELEVATION - WALL

A511 SCALE: 1/4" = 1'-0"

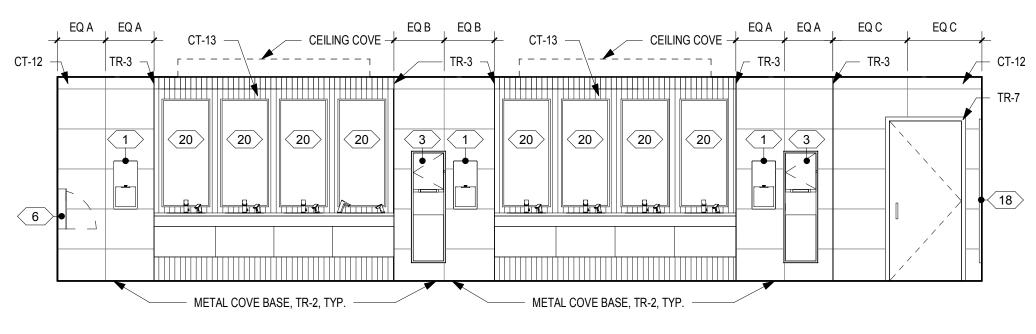

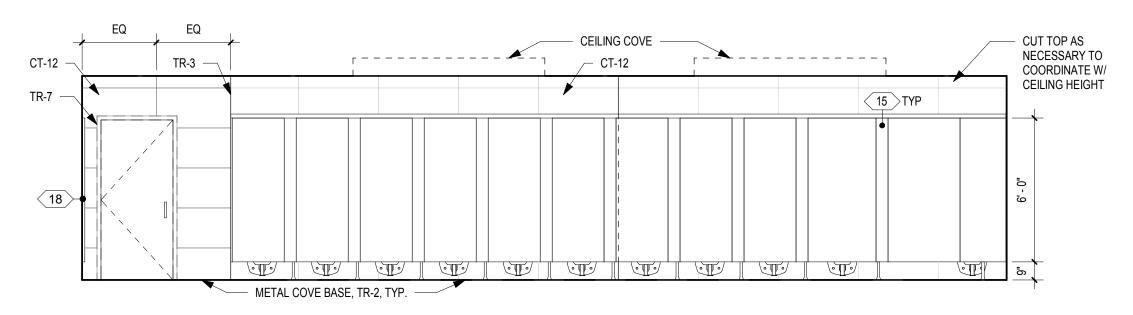



9 SOUTH ELEVATION A511 SCALE: 1/4" = 1'-0"


8 NORTH ELEVATION - PARTITIONS A511 SCALE: 1/4" = 1'-0"


INTERIOR ELEVATIONS - WOMEN'S ROOM A

SEE A611 FOR FINISHES

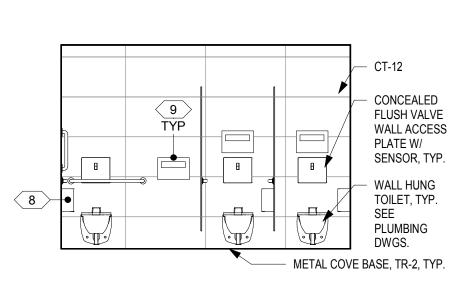

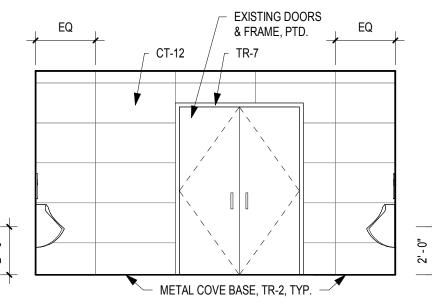

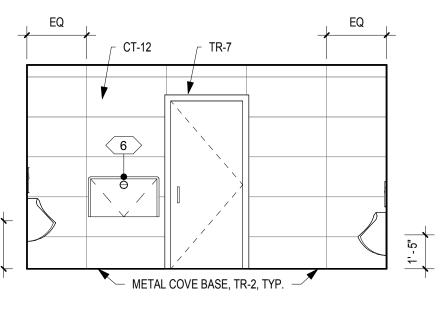

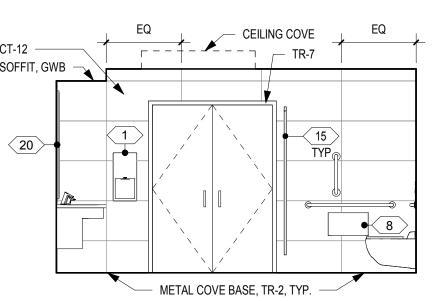



SOUTH ELEVATION - WALL A511 SCALE: 1/4" = 1'-0"


6 WEST ELEVATION - WALL A511 SCALE: 1/4" = 1'-0"

EAST ELEVATION - WALL A511 SCALE: 1/4" = 1'-0"


EAST ELEVATION - SINK A511 SCALE: 1/4" = 1'-0"

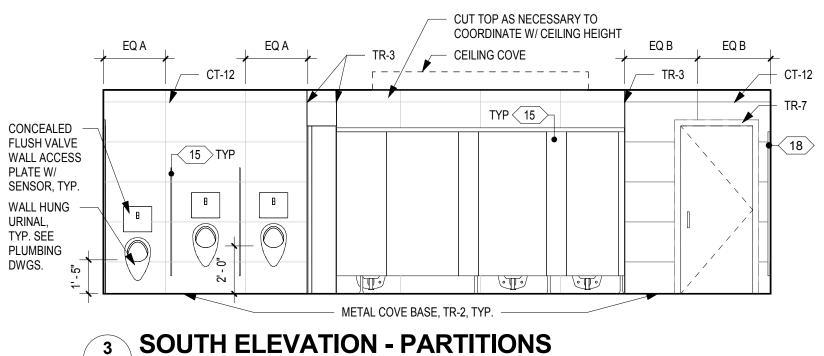

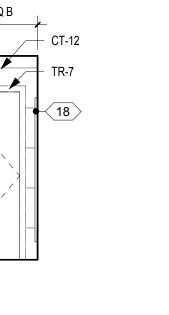

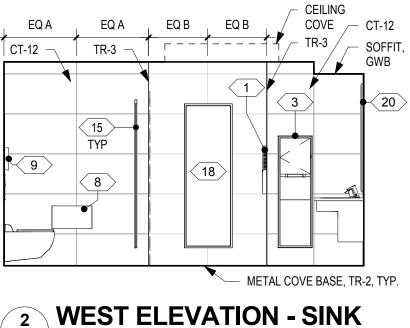

A511 SCALE: 1/4" = 1'-0"

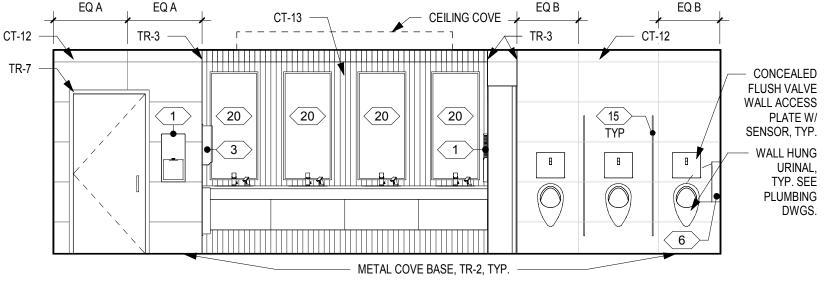

NORTH ELEVATION A511 SCALE: 1/4" = 1'-0"


INTERIOR ELEVATIONS - MEN'S ROOM A

A511 SCALE: 1/4" = 1'-0"

SEE A611 FOR FINISHES

DRAWING GENERAL NOTES

- 1. SEE A500 FOR ACCESSORY / EQUIPMENT LEGEND. 2. SEE A500 FOR TYPICAL TOILET COMPARTMENT
- ELEVATIONS AND ACCESSORY MOUNTING HEIGHTS. 3. SEE A500.3 FOR TYPICAL WALL TILE PATTERN DETAILS IN
- EXHIBIT HALL RESTROOMS. 4. SEE A500.4 FOR TYPICAL ACCENT WALL TILE ELEVATIONS
- IN SEMINAR-TYPE RESTROOMS.
- 5. SEE A600-SERIES FOR FINISH PLANS, LEGENDS, AND
- SCHEDULES. 6. ALL OUTSIDE CORNERS TO RECEIVE TRANSITION PROFILE
- TR-3 EXCEPT AT CT-13 ACCENT TILE. 7. PROVIDE 5" ROUND ST. STL. ACCESS PLATE IN WALL AT
- WATER HAMMER ARRESTOR LOCATIONS SEE PLUMBING DWGS & COORDINATE WITH OWNER/ARCHITECT.
- 8. SEE DRAWING GENERAL NOTES IN A100-SERIES FOR

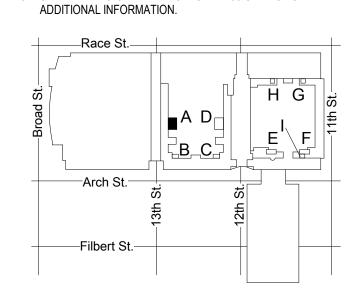

KEY PLAN - LEVEL 100

CONVERSE **WINKLER** ARCHITECTURE 331 MONTGOMERY AVE BALA CYNWYD, PA 19144

ARCHITECTS: CONVERSE WINKLER ARCHITECTURE 331 Montgomery Avenue, Bala Cynwyd, PA, 19144

Ph: 610.664.0806 Fax: 215.664.1075

Contact: Elin Westrick e-mail: ewestrick@cwarc.com

MEP ENGINEERS:



P (610) 459-7900 F (610) 459-7950 aroraengineers.com


Contact: Kevin Sultanik e-mail: ksultanik@aroraengineers.com

STRUCTURAL ENGINEERS: CSA GROUP 1341 NORTH DELAWARE AVENUE, SUITE 507

Ph: 215.427.8700 Fax: 215.427.8752

Contact: Wing Au e-mail: wau@csagroup.com

PHILADELPHIA, PA 19125

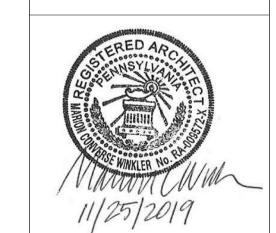

REVISIONS: Description

PENNSYLVANIA CONVENTION CENTER

RESTROOM RENOVATIONS
101 ARCH STREET, PHILADELPHIA, PA 191

ELEVATIONS & DETAILS - ROOM A (SEMINAR)


CW1615 Project number November 25, 2019 LC/KR Drawn by

A511

Checked by

NTS

As indicated

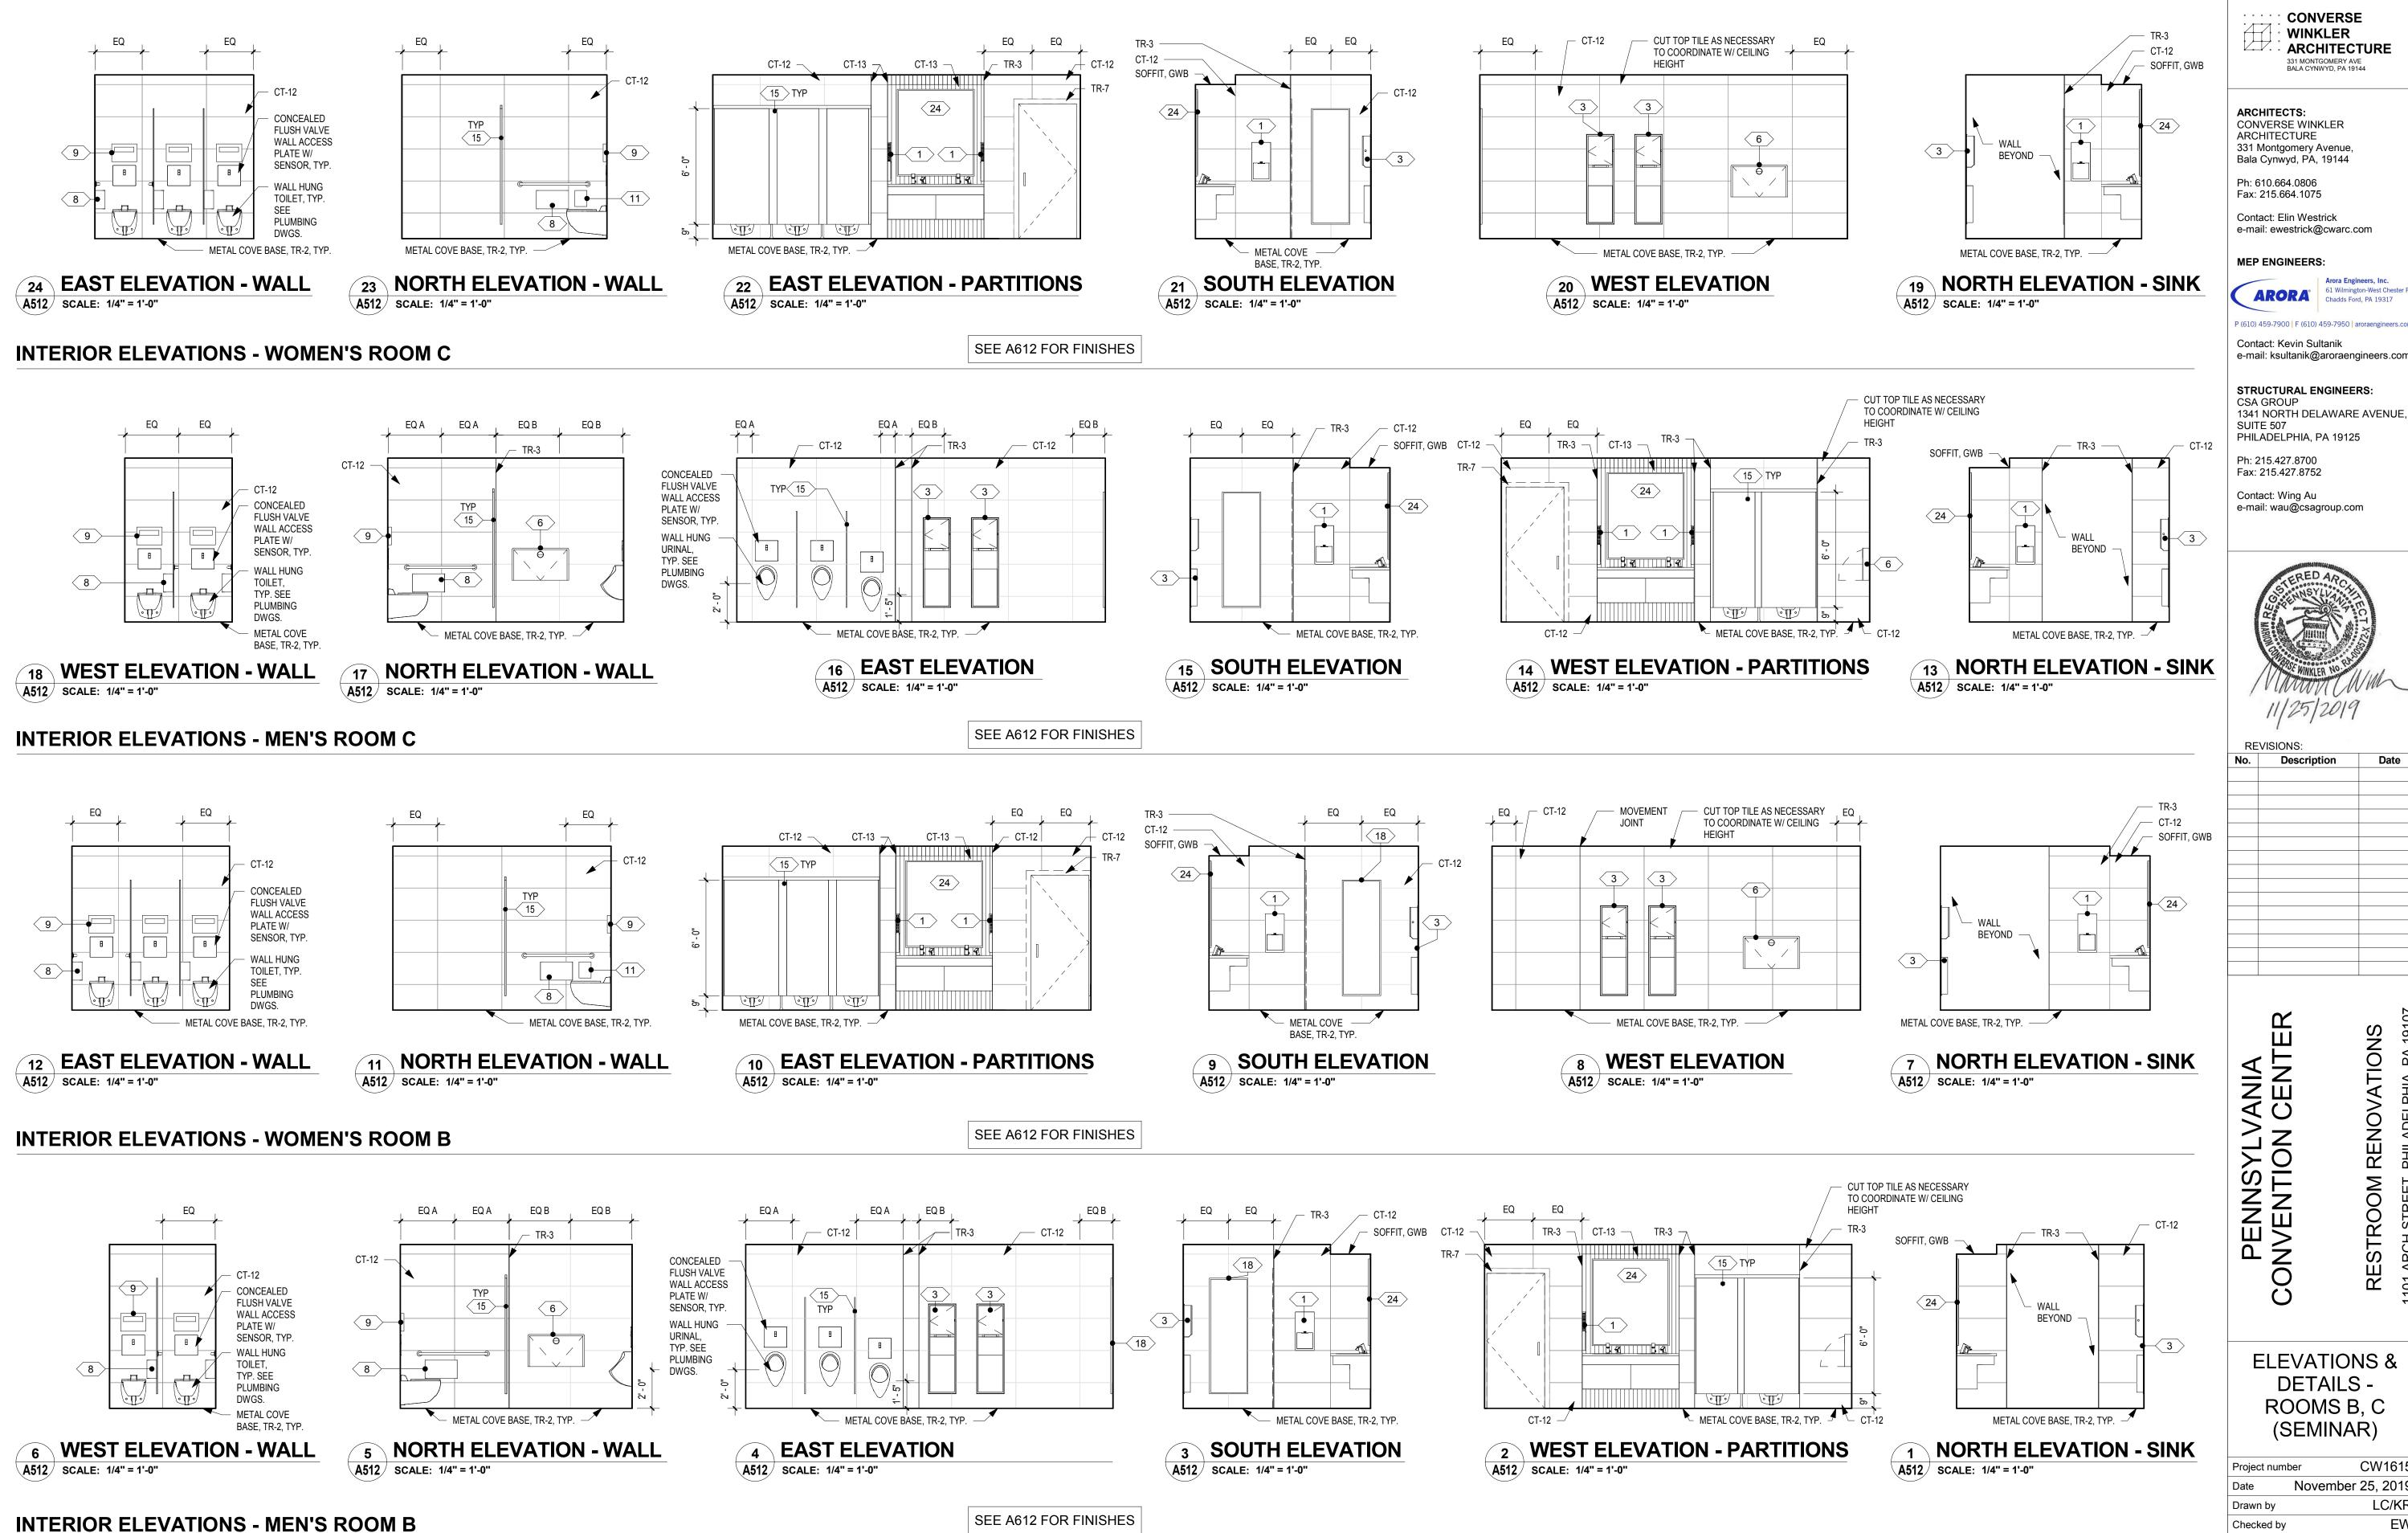

SEE PREVIOUS SHEET FOR DRAWING GENERAL NOTES

Checked by EW A512 1/4" = 1'-0"

ELEVATIONS &

DETAILS -

ROOMS B, C

(SEMINAR)

November 25, 2019

CONVERSE WINKLER ARCHITECTURE

331 MONTGOMERY AVE BALA CYNWYD, PA 19144

Arora Engineers, Inc. 61 Wilmington-West Chester F Chadds Ford, PA 19317

e-mail: ksultanik@aroraengineers.com

ARORA°

REVISIONS:

PENNSYLVANIA CONVENTION CENTER


Description


Date

RESTROOM RENOVATIONS
101 ARCH STREET, PHILADELPHIA, PA 191

CW1615

LC/KR

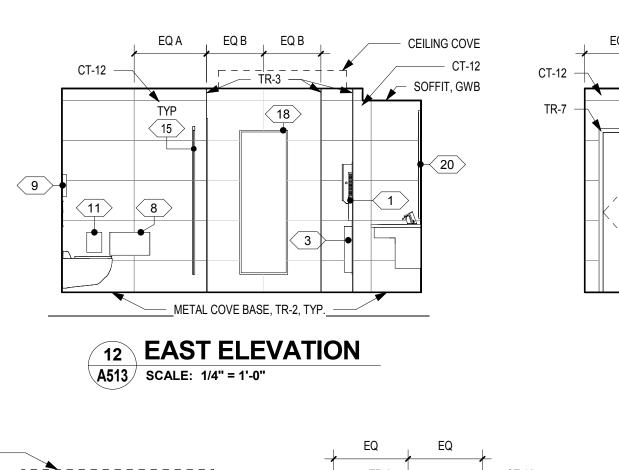


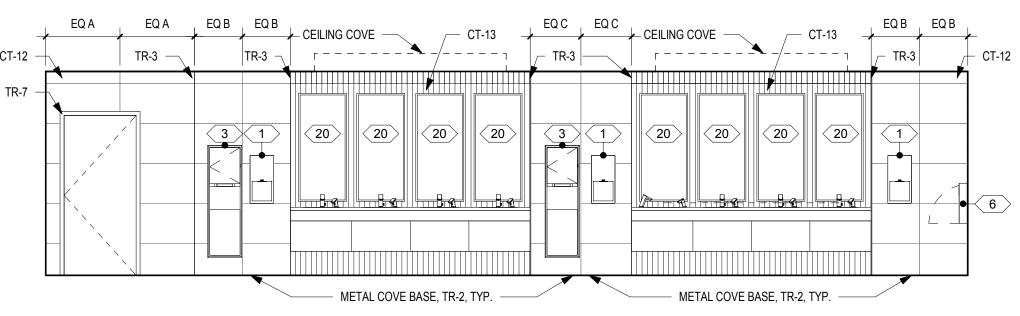

MOVEMENT JOINT

METAL COVE BASE, TR-2, TYP.

SOUTH ELEVATION A513 SCALE: 1/4" = 1'-0"

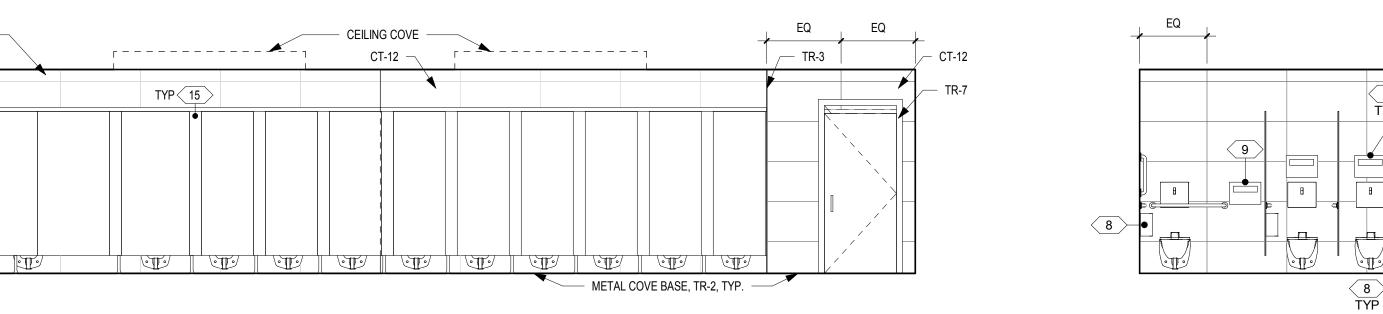

8 NORTH ELEVATION - WALL 9 NORTH ELEVATION - PARTITIONS A513 | SCALE: 1/4" = 1'-0"

INTERIOR ELEVATIONS - MEN'S ROOM D

METAL COVE BASE, TR-2, TYP.

10 WEST ELEVATION

A513 SCALE: 1/4" = 1'-0"

CEILING COVE

SOFFIT, GWB

(20)


CUT TOP AS

NECESSARY TO


CEILING HEIGHT

CT-12 COORDINATE W/

SEE A613 FOR FINISHES

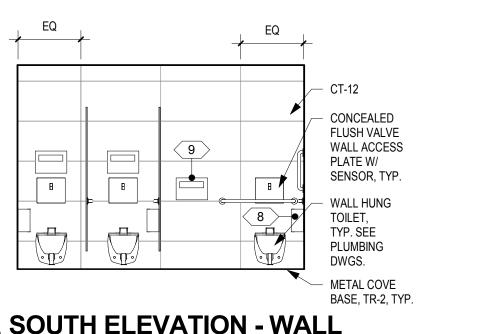




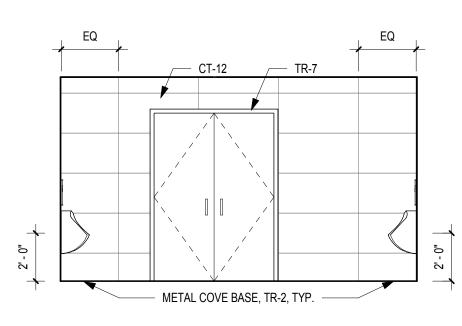


A513 SCALE: 1/4" = 1'-0"


EAST ELEVATION - WALL A513 SCALE: 1/4" = 1'-0"

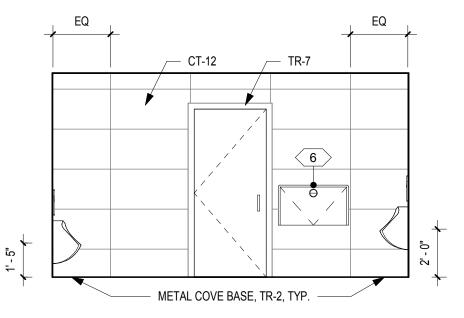


5 WEST ELEVATION - WALL A513 SCALE: 1/4" = 1'-0"

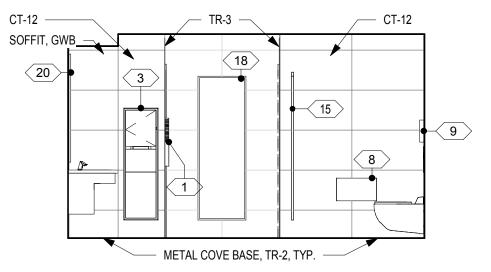


4 EAST ELEVATION - SINK A513 SCALE: 1/4" = 1'-0"

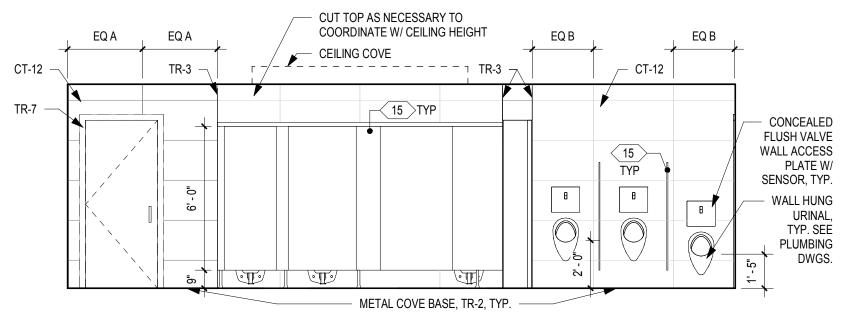

3 SOUTH ELEVATION - PARTITIONS A513 SCALE: 1/4" = 1'-0"

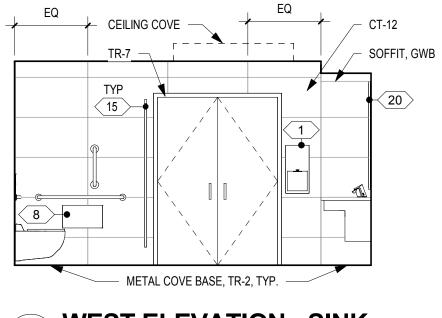

WEST ELEVATION - SINK A513 SCALE: 1/4" = 1'-0"

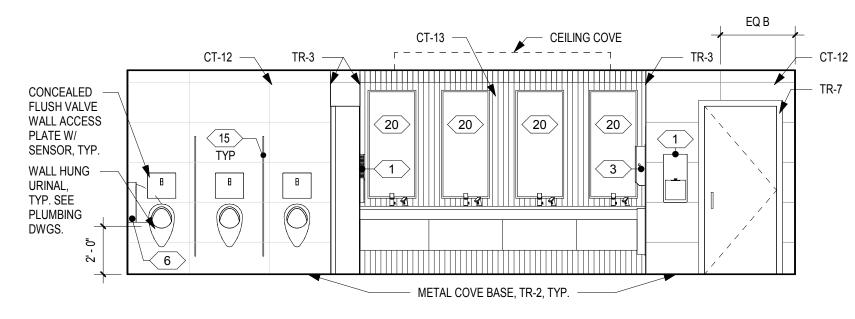

NORTH ELEVATION A513 SCALE: 1/4" = 1'-0"

INTERIOR ELEVATIONS - MEN'S ROOM D

SEE A613 FOR FINISHES

DRAWING GENERAL NOTES

- 1. SEE A500 FOR ACCESSORY / EQUIPMENT LEGEND. 2. SEE A500 FOR TYPICAL TOILET COMPARTMENT
- ELEVATIONS AND ACCESSORY MOUNTING HEIGHTS.
- 3. SEE A500.3 FOR TYPICAL WALL TILE PATTERN DETAILS IN EXHIBIT HALL RESTROOMS.
- 4. SEE A500.4 FOR TYPICAL ACCENT WALL TILE ELEVATIONS


CONCEALED FLUSH VALVE

WALL ACCESS PLATE W/ SENSOR, TYP. WALL HUNG TOILET, TYP.

PLUMBING DWGS.

- IN SEMINAR-TYPE RESTROOMS.

 5. SEE A600-SERIES FOR FINISH PLANS, LEGENDS, AND
- SCHEDULES.
 ALL OUTSIDE CORNERS TO RECEIVE TRANSITION PROFILE TR-3 EXCEPT AT CT-13 ACCENT TILE.
 PROVIDE 5" ROUND ST. STL. ACCESS PLATE IN WALL AT WATER HAMMER ARRESTOR LOCATIONS SEE PLUMBING
- DWGS & COORDINATE WITH OWNER/ARCHITECT.
- 8. SEE DRAWING GENERAL NOTES IN A100-SERIES FOR ADDITIONAL INFORMATION.

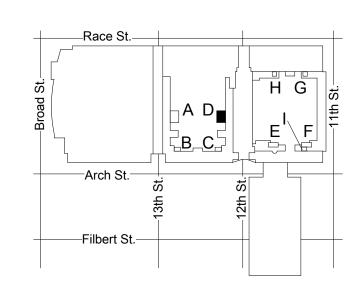

KEY PLAN - LEVEL 100

CONVERSE **WINKLER** ARCHITECTURE 331 MONTGOMERY AVE BALA CYNWYD, PA 19144

ARCHITECTS: CONVERSE WINKLER ARCHITECTURE 331 Montgomery Avenue, Bala Cynwyd, PA, 19144

Ph: 610.664.0806

Fax: 215.664.1075

Contact: Elin Westrick e-mail: ewestrick@cwarc.com



P (610) 459-7900 F (610) 459-7950 aroraengineers.com


Contact: Kevin Sultanik e-mail: ksultanik@aroraengineers.com

STRUCTURAL ENGINEERS:

CSA GROUP 1341 NORTH DELAWARE AVENUE, SUITE 507 PHILADELPHIA, PA 19125

Ph: 215.427.8700 Fax: 215.427.8752

Contact: Wing Au e-mail: wau@csagroup.com

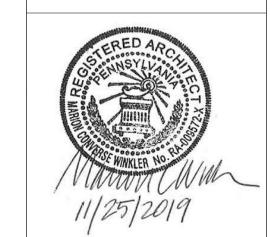

REVISIONS: Description


PENNSYLVANIA CONVENTION CENTER RESTROOM RENOVATIONS
101 ARCH STREET, PHILADELPHIA, PA 191


ELEVATIONS & DETAILS - ROOM D (SEMINAR)

CW1615 Project number November 25, 2019 LC/KR Drawn by EW Checked by

A513

NTS

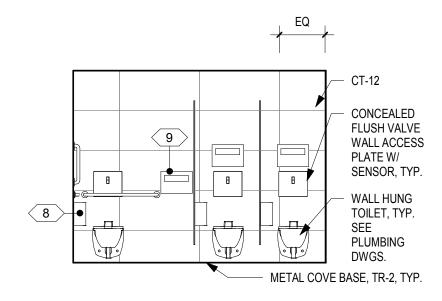


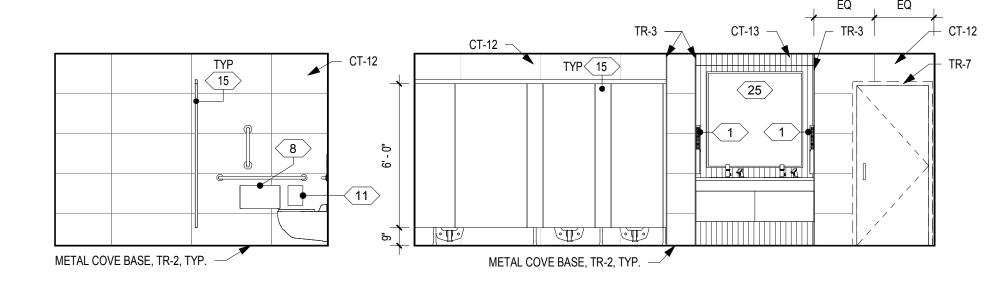



EAST ELEVATION - WALL A514 SCALE: 1/4" = 1'-0"

NORTH ELEVATION - WALL A514 SCALE: 1/4" = 1'-0"

10 EAST ELEVATION - PARTITIONS A514 SCALE: 1/4" = 1'-0"

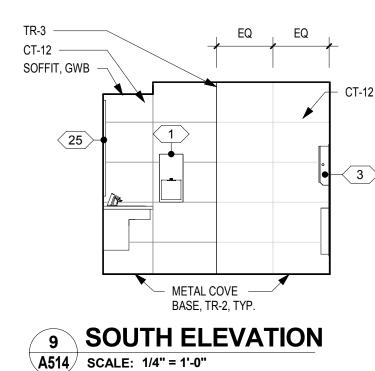

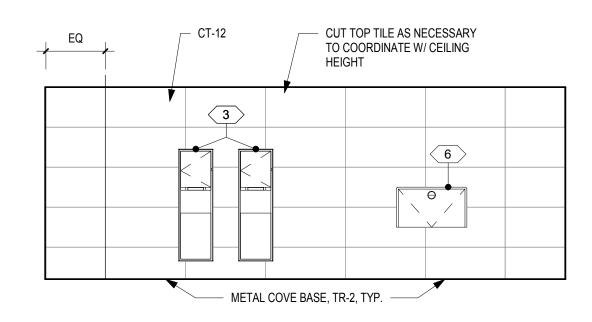

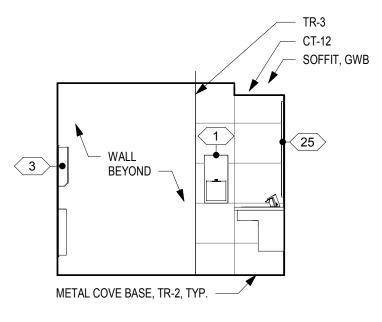



8 WEST ELEVATION A514 SCALE: 1/4" = 1'-0"

NORTH ELEVATION - SINK A514 SCALE: 1/4" = 1'-0"

INTERIOR ELEVATIONS - WOMEN'S ROOM I

SEE A614 FOR FINISHES

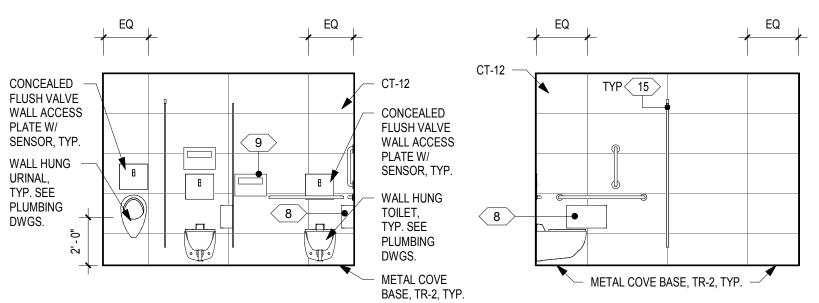


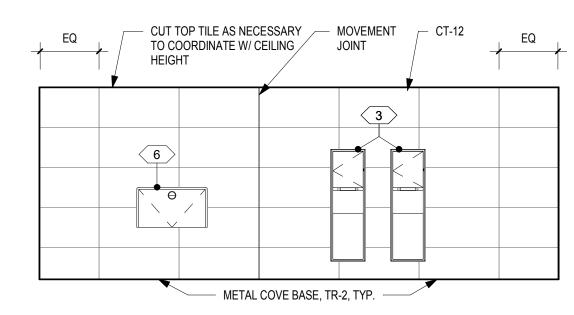



6 WEST ELEVATION - WALL A514 SCALE: 1/4" = 1'-0"





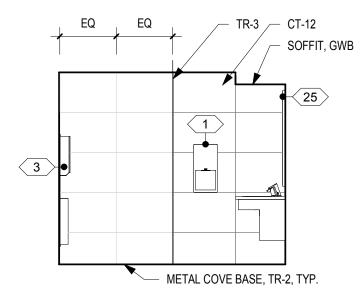

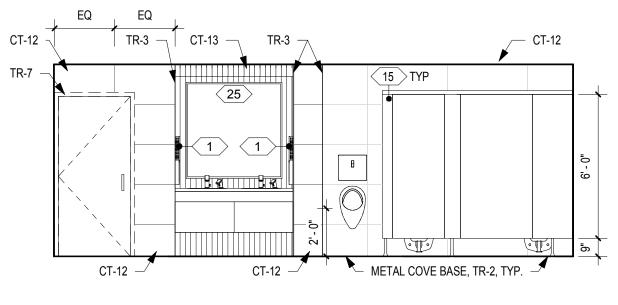

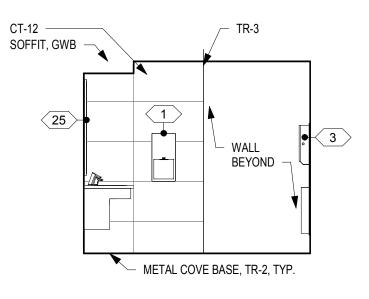

3 SOUTH ELEVATION A514 SCALE: 1/4" = 1'-0"

2 WEST ELEVATION - PARTITIONS A514 SCALE: 1/4" = 1'-0"


NORTH ELEVATION - SINK A514 SCALE: 1/4" = 1'-0"

INTERIOR ELEVATIONS - MEN'S ROOM I

SEE A614 FOR FINISHES

DRAWING GENERAL NOTES

- 1. SEE A500 FOR ACCESSORY / EQUIPMENT LEGEND. 2. SEE A500 FOR TYPICAL TOILET COMPARTMENT
- ELEVATIONS AND ACCESSORY MOUNTING HEIGHTS. 3. SEE A500.3 FOR TYPICAL WALL TILE PATTERN DETAILS IN
- EXHIBIT HALL RESTROOMS. 4. SEE A500.4 FOR TYPICAL ACCENT WALL TILE ELEVATIONS
- IN SEMINAR-TYPE RESTROOMS.
 5. SEE A600-SERIES FOR FINISH PLANS, LEGENDS, AND
- SCHEDULES.
- 6. ALL OUTSIDE CORNERS TO RECEIVE TRANSITION PROFILE TR-3 EXCEPT AT CT-13 ACCENT TILE.
- 7. PROVIDE 5" ROUND ST. STL. ACCESS PLATE IN WALL AT WATER HAMMER ARRESTOR LOCATIONS - SEE PLUMBING
- DWGS & COORDINATE WITH OWNER/ARCHITECT.
- 8. SEE DRAWING GENERAL NOTES IN A100-SERIES FOR ADDITIONAL INFORMATION.

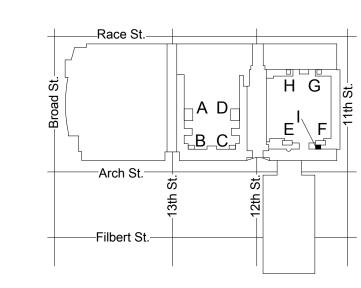

KEY PLAN - LEVEL 100

CONVERSE **WINKLER** ARCHITECTURE 331 MONTGOMERY AVE BALA CYNWYD, PA 19144

ARCHITECTS:CONVERSE WINKLER ARCHITECTURE 331 Montgomery Avenue, Bala Cynwyd, PA, 19144

Ph: 610.664.0806 Fax: 215.664.1075

Contact: Elin Westrick e-mail: ewestrick@cwarc.com

MEP ENGINEERS:



P (610) 459-7900 F (610) 459-7950 aroraengineers.com Contact: Kevin Sultanik

e-mail: ksultanik@aroraengineers.com

STRUCTURAL ENGINEERS: **CSA GROUP** 1341 NORTH DELAWARE AVENUE,

Ph: 215.427.8700 Fax: 215.427.8752

SUITE 507

Contact: Wing Au e-mail: wau@csagroup.com

PHILADELPHIA, PA 19125



REVISIONS: Description

PENNSYLVANIA CONVENTION CENTER

RESTROOM RENOVATIONS
101 ARCH STREET, PHILADELPHIA, PA 191

ELEVATIONS & DETAILS - ROOM I (SEMINAR)


CW1615 Project number November 25, 2019 Date LC/KR Drawn by

A514


Checked by

NTS


As indicated

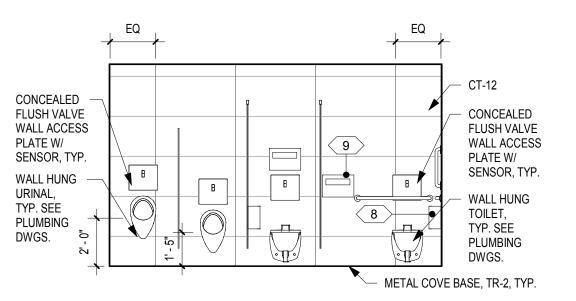



12 WEST ELEVATION - WALL A515 SCALE: 1/4" = 1'-0"

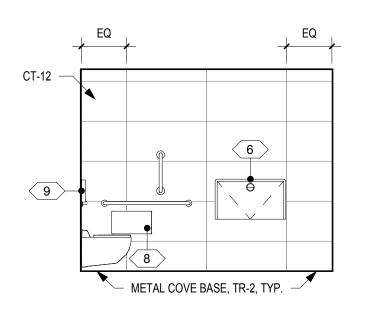


11 NORTH ELEVATION - WALL A515 SCALE: 1/4" = 1'-0"

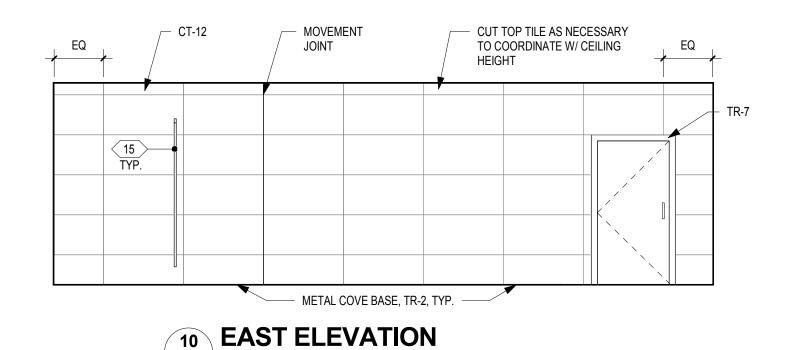

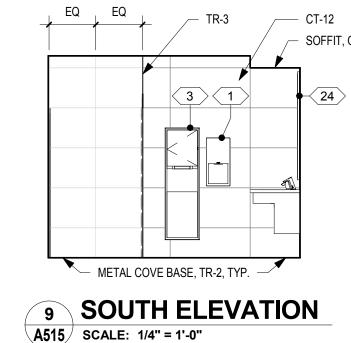

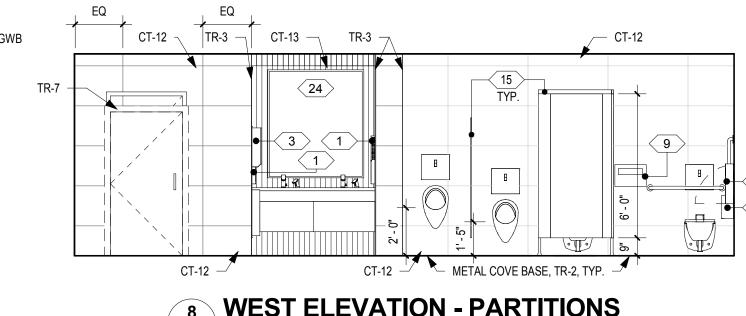

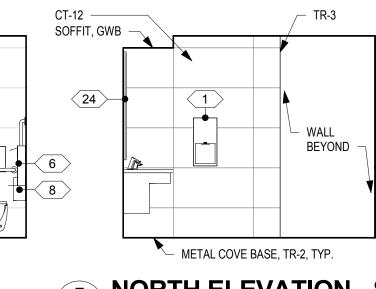


8 WEST ELEVATION - PARTITIONS A515 SCALE: 1/4" = 1'-0"

NORTH ELEVATION - SINK A515 SCALE: 1/4" = 1'-0"


INTERIOR ELEVATIONS - MEN'S ROOM M

A515 SCALE: 1/4" = 1'-0"


SEE A615 FOR FINISHES

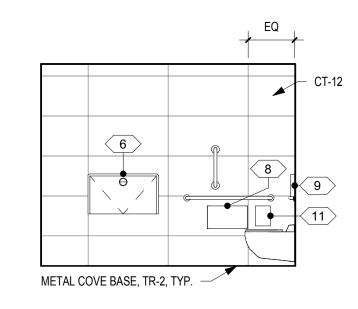

6 NORTH ELEVATION - WALL

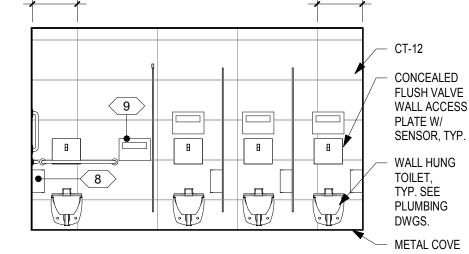


A515 SCALE: 1/4" = 1'-0"

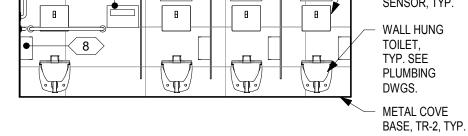

____ CT-12

SOFFIT, GWB

5 EAST ELEVATION - WALL

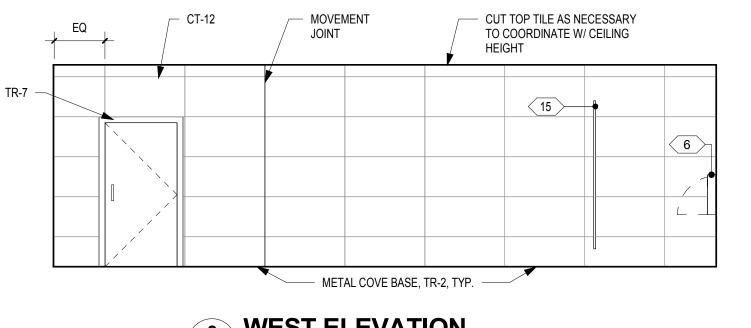

WALL BEYOND METAL COVE BASE, TR-2, TYP. —

NORTH ELEVATION - SINK A515 SCALE: 1/4" = 1'-0"

SEE A615 FOR FINISHES

3 SOUTH ELEVATION A515 SCALE: 1/4" = 1'-0"

METAL COVE —
 BASE, TR-2, TYP.

CT-12 -

SOFFIT, GWB

WEST ELEVATION A515 SCALE: 1/4" = 1'-0"

A515 SCALE: 1/4" = 1'-0"

S R -Arch St.

DRAWING GENERAL NOTES

EXHIBIT HALL RESTROOMS.

ADDITIONAL INFORMATION.

IN SEMINAR-TYPE RESTROOMS.

1. SEE A500 FOR ACCESSORY / EQUIPMENT LEGEND. 2. SEE A500 FOR TYPICAL TOILET COMPARTMENT

ELEVATIONS AND ACCESSORY MOUNTING HEIGHTS.

4. SEE A500.4 FOR TYPICAL ACCENT WALL TILE ELEVATIONS

schedules.
6. All outside corners to receive transition profile tr-3 except at Ct-13 accent tile.
7. Provide 5" round st. stl. access plate in wall at

WATER HAMMER ARRESTOR LOCATIONS - SEE PLUMBING

5. SEE A600-SERIES FOR FINISH PLANS, LEGENDS, AND

DWGS & COORDINATE WITH OWNER/ARCHITECT.

8. SEE DRAWING GENERAL NOTES IN A100-SERIES FOR

SEE A500.3 FOR TYPICAL WALL TILE PATTERN DETAILS IN

KEY PLAN - LEVEL 200

ARCHITECTURE 331 MONTGOMERY AVE BALA CYNWYD, PA 19144

CONVERSE **WINKLER**

ARCHITECTS:CONVERSE WINKLER ARCHITECTURE 331 Montgomery Avenue, Bala Cynwyd, PA, 19144

Ph: 610.664.0806 Fax: 215.664.1075

Contact: Elin Westrick e-mail: ewestrick@cwarc.com

MEP ENGINEERS:



P (610) 459-7900 F (610) 459-7950 aroraengineers.com


Contact: Kevin Sultanik e-mail: ksultanik@aroraengineers.com

STRUCTURAL ENGINEERS: CSA GROUP 1341 NORTH DELAWARE AVENUE, SUITE 507

PHILADELPHIA, PA 19125

Ph: 215.427.8700 Fax: 215.427.8752

Contact: Wing Au e-mail: wau@csagroup.com

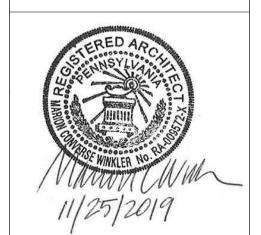

REVISIONS: Description

PENNSYLVANIA CONVENTION CENTER

RESTROOM RENOVATIONS
101 ARCH STREET, PHILADELPHIA, PA 191

ELEVATIONS & DETAILS -ROOMS L, M (SEMINAR)

CW1615 Project number November 25, 2019 LC/KR Drawn by EW Checked by

A515

As indicated

INTERIOR ELEVATIONS - WOMEN'S ROOM L

A515 SCALE: 1/4" = 1'-0"

- METAL COVE BASE, TR-2, TYP.

CT-12 —

TYP (15)

8

CT-13 -

EAST ELEVATION - PARTITIONS