SYMBOLS LIST



DETAIL TAG AA=DRAWING NUMBER XX=DETAIL NUMBER

CIRCUIT NUMBER

CONDUIT OR CABLE

HOMERUN WITH PANEL AND/OR

PANELBOARD 208V

ABBREVIATIONS

- AMPERAGE
- A.F.F. ABOVE FINISHED FLOOR
- A.F.G. ABOVE FINISHED GRADE
- AMP FRAME
- AUTHORITY HAVING JURISDICTION

- AUTOMATIC TRANSFER SWITCH
- AMERICAN WIRE GAUGE

ALUMINIUM

- CONDUIT
- CIRCUIT BREAKER
- CEILING MOUNTED

- DEMO DEMOLITION
- DRAWING
- EXISTING TO REMAIN

CONTROL PANEL

- ELEC. ELECTRICAL
- ELECTRICAL METALLIC TUBING
- EQUIP EQUIPMENT

- GROUND FAULT CIRCUIT INTERRUPTER
- GALVANIZED RIGID STEEL CONDUIT
- HAND-OFF-AUTO
- HORSEPOWER KILOVOLTS
- KILOVOLTS AMPS
- KILOWATT HOURS
- MCB MAIN CIRCUIT BREAKER
- MFR MANUFACTURER
- MAIN LUGS ONLY
- NEC NATIONAL ELECTRICAL CODE

MOUNTING

- N.T.S. NOT TO SCALE
- POLYVINYLCHLORIDE

- (R) TO BE REMOVED (DEMOLISHED)
- RGS RIGID GALVANIZED STEEL

POWER

- RECEP RECEPTACLE
- SCC SHORT CIRCUIT CURRENT
- SWBD SWITCHBOARD
- SWGR SWITCHGEAR
- UG UNDERGROUND
- U.O.N. UNLESS OTHERWISE NOTED
- VOLTS/VOLTAGE
- VARIABLE FREQUENCY DRIVE
- WEATHERPROOF
- + DENOTES 9" ABOVE COUNTERTOP OR SINK XX"DENOTES HEIGHT ABOVE EXAM BED

GENERAL REQUIREMENTS:


- 1. THE WORK TO BE DONE UNDER THIS PROJECT INCLUDES PROVIDING ALL EQUIPMENT, MATERIALS, LABOR AND SERVICES, AND PERFORMING ALL OPERATIONS FOR COMPLETE AND OPERATING SYSTEMS. ANY WORK NOT SPECIFICALLY COVERED BUT NECESSARY TO COMPLETE THIS INSTALLATION, SHALL BE PROVIDED. ALL EQUIPMENT AND WIRING TO BE NEW AND PROVIDED UNDER THIS CONTRACT UNLESS OTHERWISE NOTED.
- ENTIRE INSTALLATION, INCLUDING MATERIALS, EQUIPMENT AND WORKMANSHIP, SHALL CONFORM TO THE LATEST EDITION OF THE NATIONAL ELECTRIC CODE (NFPA 70 AND NECA-1) ADOPTED IN THIS STATE AS WELL AS ALL APPLICABLE LAWS AND REGULATIONS AND REGULATORY BODIES HAVING JURISDICTION OVER THIS WORK:
- 3. THE TERM "FURNISH" SHALL MEAN TO OBTAIN AND SUPPLY TO THE JOB SITE. THE TERM "INSTALL" SHALL MEAN TO FIX IN POSITION AND CONNECT FOR USE. THE TERM "PROVIDE" SHALL MEAN TO FURNISH AND INSTALL. THE TERM "CONTRACTOR" SHALL MEAN ELECTRICAL CONTRACTOR.
- 4. ONLY WRITTEN CHANGES AND/OR MODIFICATIONS APPROVED BY THE ARCHITECT, CONSULTING ENGINEER OR OWNER'S REPRESENTATIVE WILL BE
- 5. ALL NEW ELECTRICAL MATERIAL AND EQUIPMENT SHALL BE LISTED BY UNDERWRITERS' LABORATORIES, INC. (UL) AND BEAR THE UL LABEL.

RECOGNIZED.


- 6. PROVIDE ALL SCAFFOLDING, LADDERS, RIGGING, HOISTING, ETC., FOR THIS
- 7. PROVIDE TECHNICAL MANUALS, PER SPECIFICATIONS, AND GIVE INSTRUCTIONS TO USER FOR ALL EQUIPMENT AND SYSTEMS PROVIDED UNDER THIS CONTRACT AFTER ALL ARE CLEANED AND OPERATING.
- 8. THE DRAWINGS ARE DIAGRAMMATIC AND ALL SPECIALTIES AND APPURTENANCES ARE NOT SHOWN, BUT SHALL BE PROVIDED AS
- 9. CONTRACTOR SHALL FIELD VERIFY DIMENSIONS OF FINISHED CONSTRUCTION PRIOR TO FABRICATION AND INSTALLATION OF FIXTURES AND EQUIPMENT.
- 10. THE WORK SHALL INCLUDE ALL PANELS, DEVICES, FEEDERS AND BRANCH CIRCUIT WIRING AS REQUIRED FOR THE DISTRIBUTION SYSTEM INDICATED AND CALLED FOR ON THE DRAWINGS, REQUIRED BY SPECIFICATIONS AND AS NECESSARY FOR COMPLETE FUNCTIONAL SYSTEMS PRESENTED AND
- 11. CONTRACTOR SHALL FURNISH ALL MATERIAL, LABOR, TOOLS, EQUIPMENT, CONSUMABLES AND SERVICES REQUIRED FOR OBTAINING, DELIVERY, INSTALLATION, CONNECTION, DISCONNECTION, REMOVAL, RELOCATION, REPAIR, REPLACEMENT, TESTING AND COMMISSIONING OF ALL EQUIPMENT AND DEVICES INCLUDED IN OR NECESSARY FOR THE WORK, AS APPLICABLE.
- 12. ELECTRICAL WORK SHALL INCLUDE ALL REQUIRED CUTTING, PATCHING AND
- THE FULL RESTORATION OF WALL AND FLOOR STRUCTURE AND SURFACES. 13. EXACT ROUTING OF CONDUITS SHALL BE DETERMINED IN THE FIELD.
- 14. CONTRACTOR SHALL VISIT THE SITE AND BECOME FAMILIAR WITH ALL CONDITIONS AND SYSTEMS THAT EFFECT HIS BIDDING AND WORK, AND SHALL PROVIDE VALUE FOR SAME IN HIS BID.
- 15. UPON COMPLETION OF THE ELECTRICAL WORK, CONTRACTOR SHALL TEST THE COMPLETE ELECTRICAL SYSTEM FOR SHORTS, GROUNDS, AND PROPER OPERATION, IN THE PRESENCE OF THE OWNER'S REPRESENTATIVE.
- 16. UPON COMPLETION OF WORK, THE CONTRACTOR SHALL CLEAN AND ADJUST ALL EQUIPMENT AND LIGHTING AND TEST SYSTEMS TO THE SATISFACTION OF OWNER AND ENGINEER. RESULTS SHALL BE SUBMITTED TO THE ENGINEER FOR APPROVAL.
- 17. ALL WORK SHALL BE PERFORMED BY THOSE SKILLED IN THEIR PARTICULAR TRADE IN A NEAT AND WORKMANLIKE MANNER.
- 18. ELECTRICAL WORK SHALL BE DONE AT SUCH A TIME, AND IN SUCH MANNER, AS WILL LEAST INTERFERE WITH THE MAINTENANCE AND OPERATION OF THE SITE'S AND/OR BUILDING'S ACTIVITIES. PROVISIONS SHALL BE MADE TO PERMIT THE USE OF ALL EXISTING ELECTRICAL SYSTEMS AT ALL TIMES. PROVIDE TEMPORARY FACILITIES TO SECURE THESE CONDITIONS AND REMOVE SUCH TEMPORARY FACILITIES WHEN NO LONGER REQUIRED.
- 19. SHUTDOWN WORK SHALL BE SCHEDULED AT SUCH TIME AND IN SUCH MANNER AS DIRECTED BY THE OWNER AND ENGINEER. PROVIDE A MINIMUM ONE WEEK NOTICE.
- 20. WHERE ALLOWABLE SHUTDOWN PERIODS CANNOT BE OF DURATION TO ACCOMMODATE ALL OF THE REQUIRED WORK, THE CONTRACTOR SHALL PERFORM THE WORK IN A SERIES OF PREPLANNED STAGES DURING ALLOWABLE SHUTDOWN PERIODS. PROVIDE TEMPORARY FACILITIES TO ALLOW RE-ENERGIZING OF SERVICES BETWEEN WORKING STAGES.

LIGHTING FIXTURE LEGEND

LED surface ceiling mounted line voltage tape containing an extruded clear thermoplastic jacket, 580 lumens/ft output, 2"W x 6"L x 1 1/2"H inline feed boxes at each end and continuous white opaque mounting channel. The feed boxes shall contain a conduit entry on the top and flush cover on the bottom.	Apogee Lighting	SFAC-8-35-H-LENGTH-2MOD BOX-STD-PCTW	LED 3500°K	5W/LF	120	Surface	1.Provide lengths as shown on drawings. 2.Contractor to provide manufacturer with required field dimensioned lengths. Tape cannot be field cut or modified. 3.Adjacent sections of tape to daisy chain together with BX jumpers. 4.Maximum length per feed - 100'. 5.
Similar to FX2 except with a right angle power feed connector with an inline feed box at one end at one end and a termination cap at the other end.	Apogee Lighting	SFAC-8-35-H-LENGTH-MOD BOX-STD-PCTW	LED 3500°K	5W/LF	120	Surface	
Similar to FX1 except the mounting channel shall be mounted to the vertical wall of an existing ceiling slot via 1" x 1" aluminum angle.	Apogee Lighting	SFAC-8-35-H-LENGTH-2BXRAU- STD-PCTW	LED 3500°K	5W/LF	120	Surface	1. See drawing FX3.0 for details. 2. Tape, channel and mounting angle shall extend continuously as shown on the lighting plans. 3. Stop mounting angle 4" short at each end of tape run to allow for BX whips exiting the top of the feed connector(s). 4. Contractor to furnish and install mounting angles.

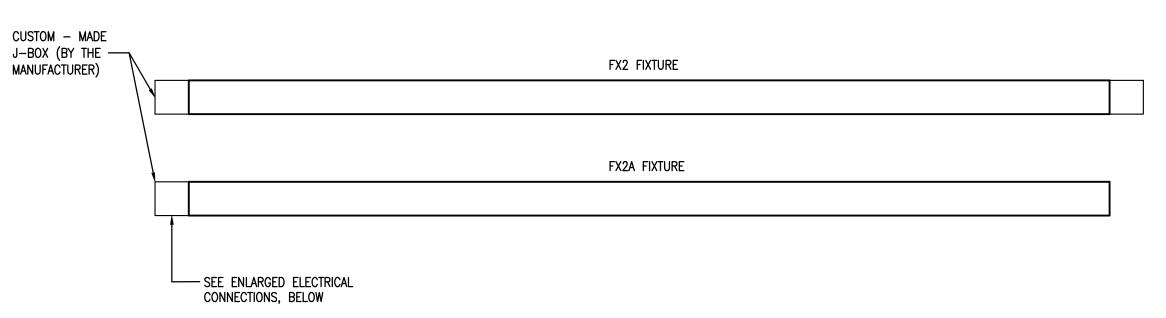


<u>PLAN VIEW OF FIXTURE MOUNTING</u>

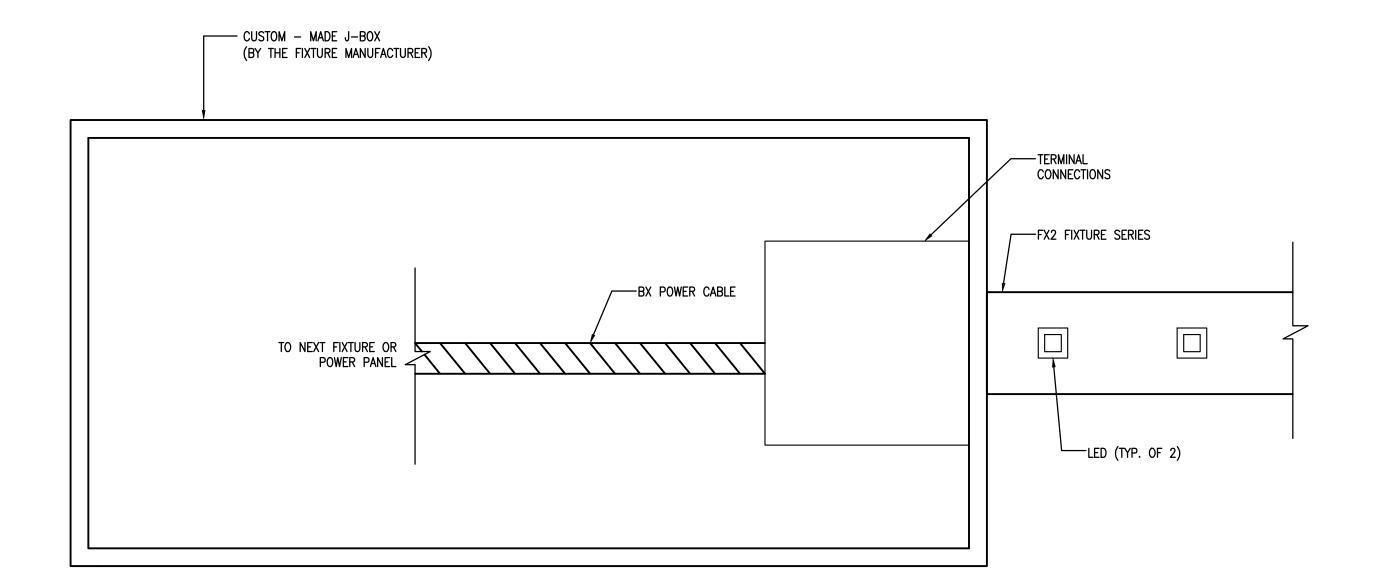

PLAN VIEW ELECTRICAL CONNECTIONS

1 FX2/FX2A SERIES - MOUNTING DETAIL
SCALE: NOT TO SCALE

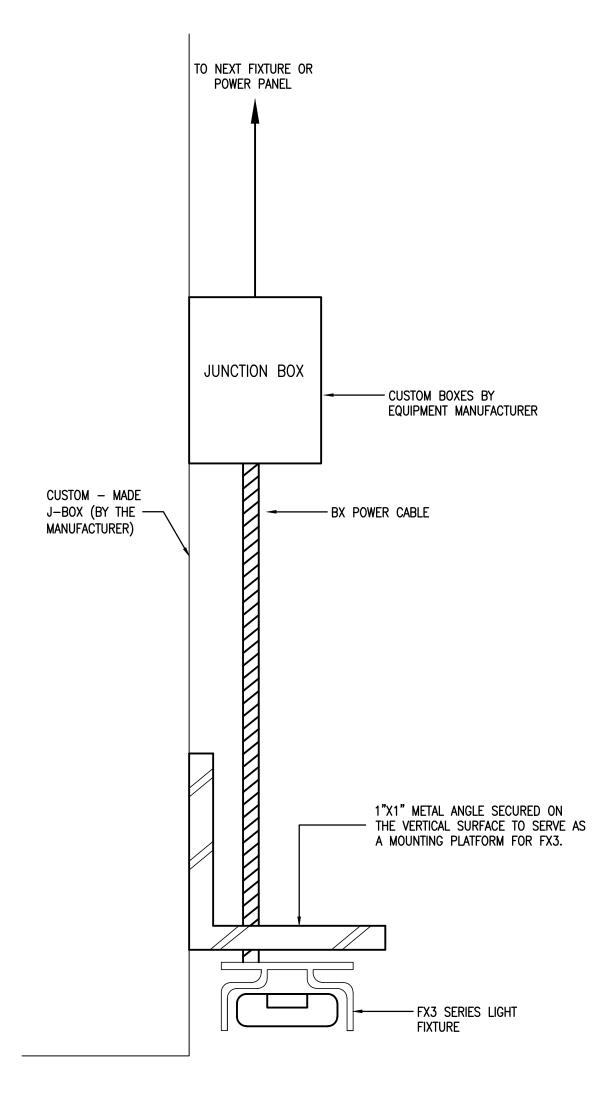


FX3 SERIES - MOUNTING DETAIL

SCALE: NOT TO SCALE

ol Pike PA 1902 215.633. seal:

consultant

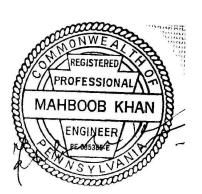

project:

ENTION

VANIA

revision no: **BID SET** 05.15.202

ELECTRICAL SYMBOL LIST, ABBREVIATION, **GENERAL NOTES & DETAILS**

sheet title:

scale: As Noted date: 5/15/2024 drawn by: J.M./P.O.D. checked by: M.K.


The Contractor on site shall verify all dimensions and existing conditions. The Contractor is required to perform all work in compliance with applicable codes and regulations of governing authorities having jurisdiction.

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drawing no.

E-0

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PARTIAL POWER PLAN - ELECTRICAL RM 000

SCALE: 1/4" = 1'-0"

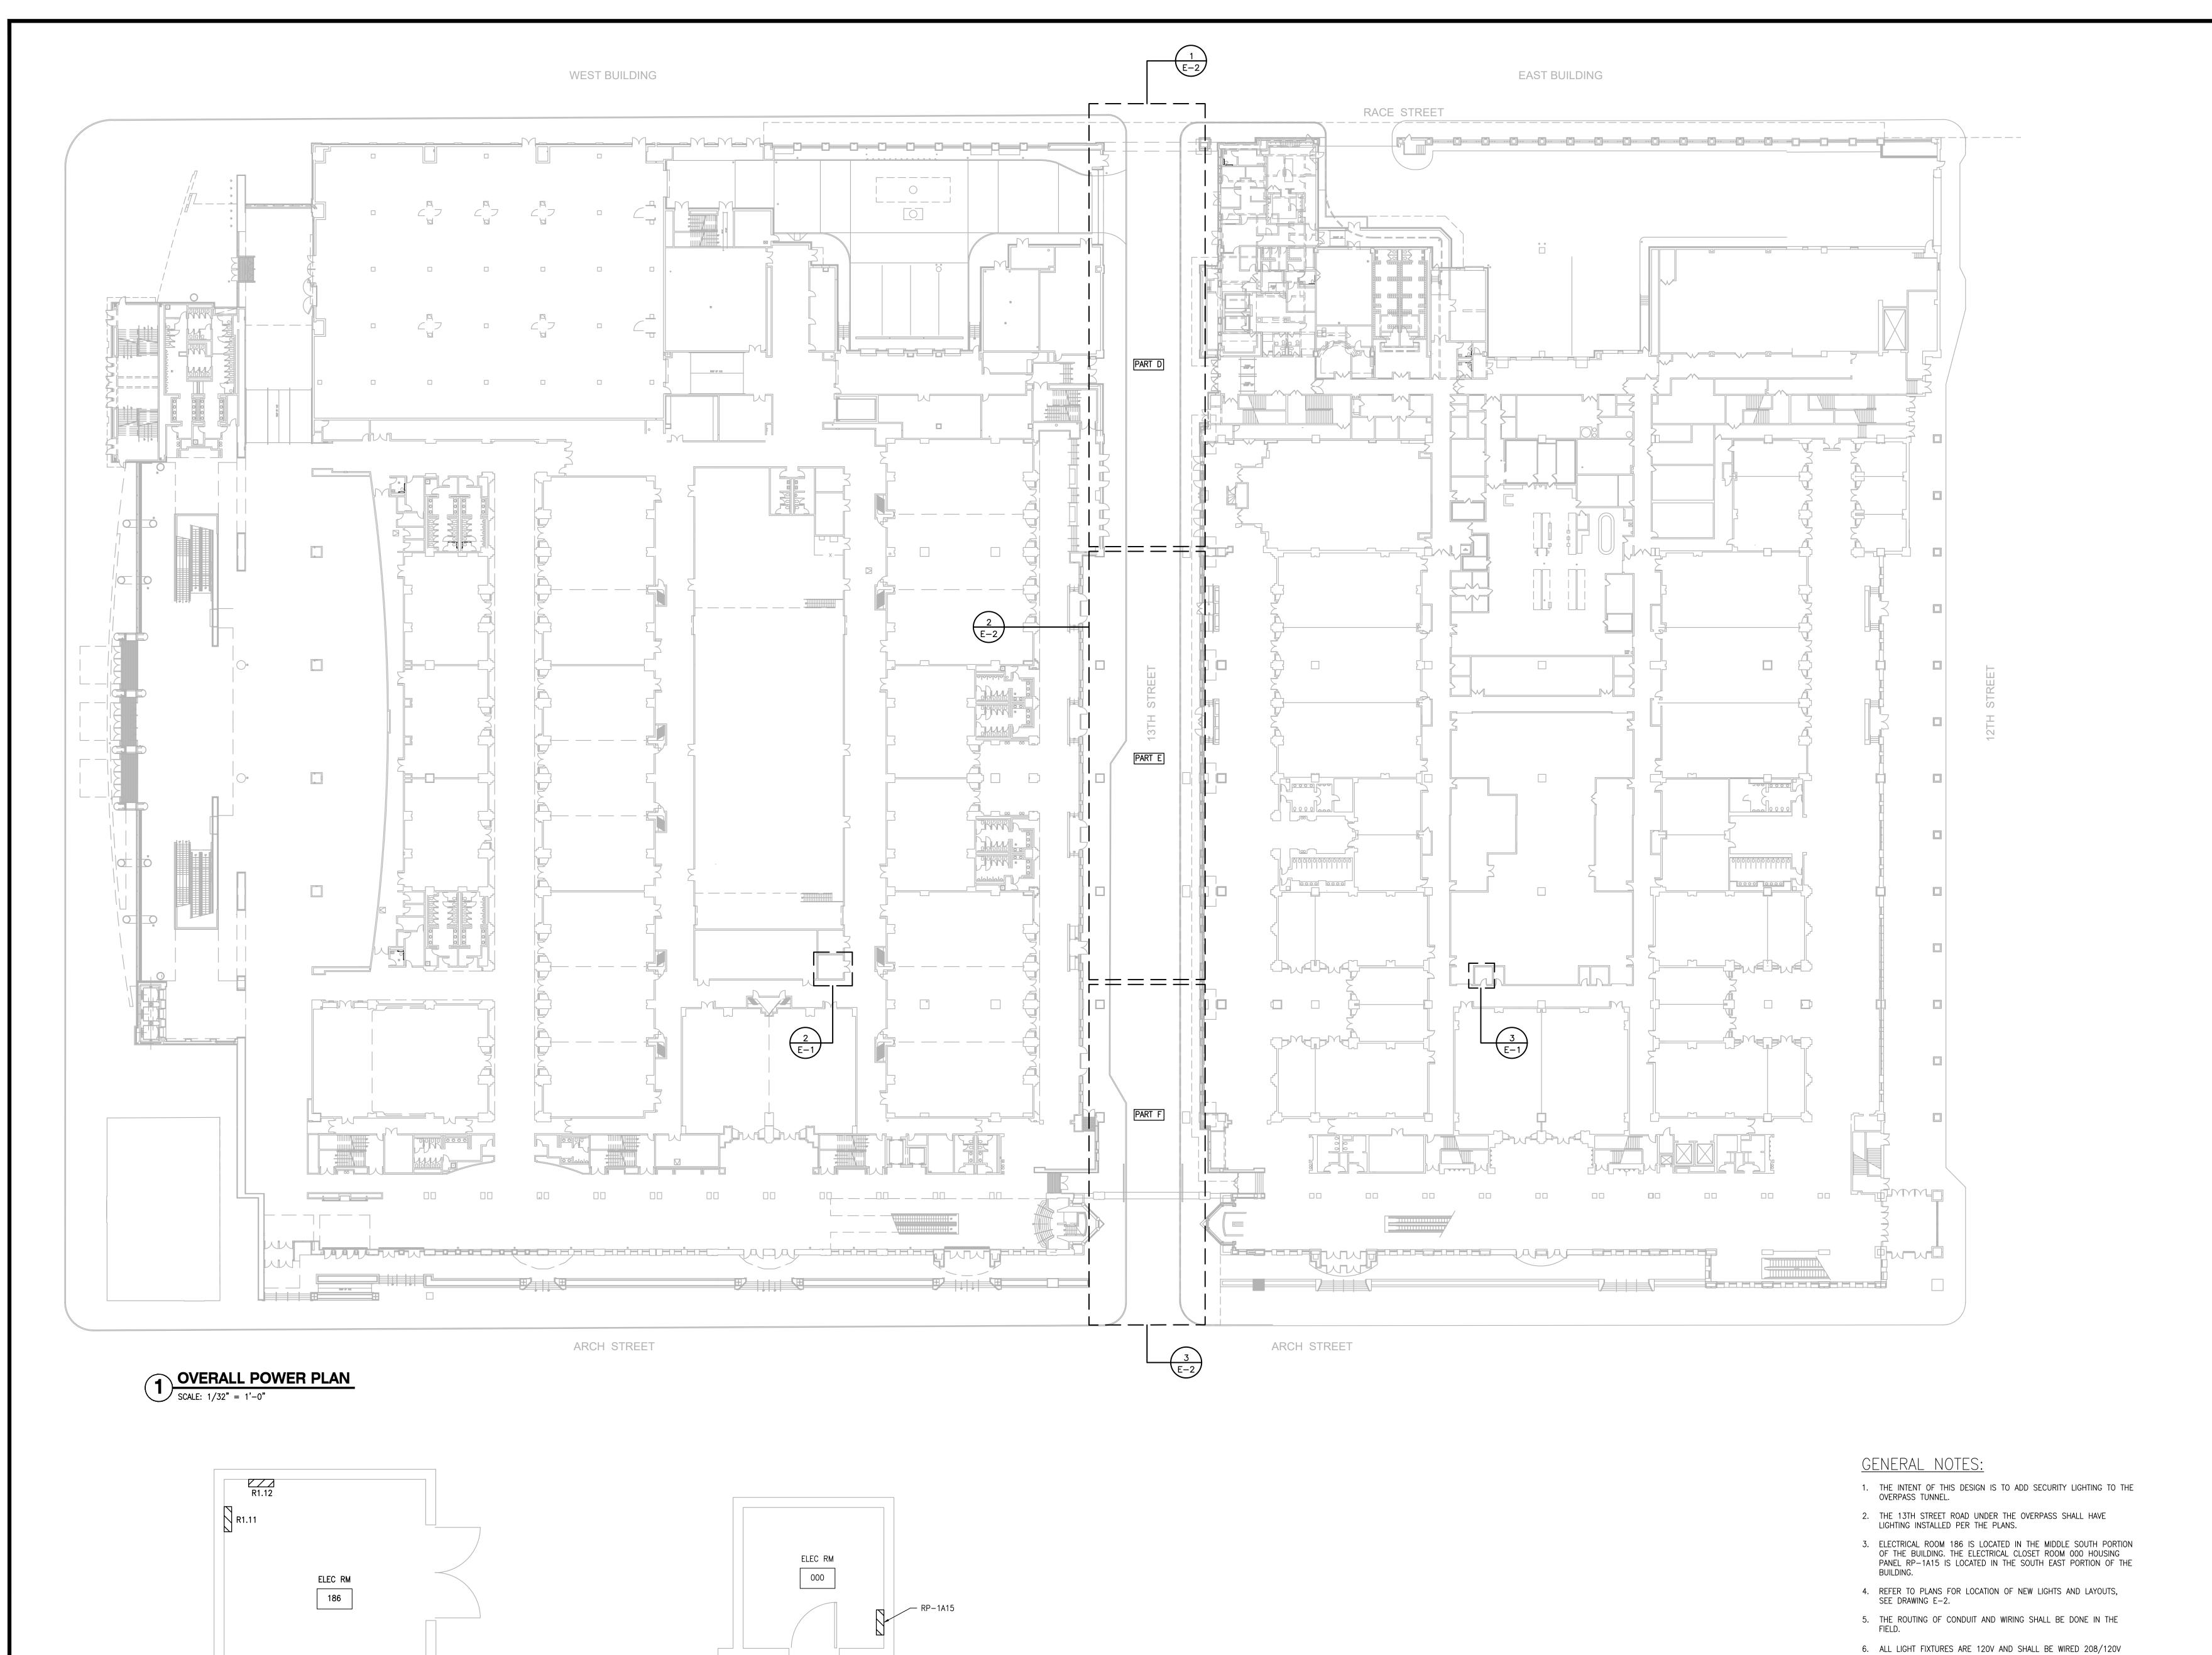PARTIAL POWER PLAN - ELEC RM 186

SCALE: 1/4" = 1'-0"


M AND S ENGINEERING SERVICE INC

Consulting Engineers

1581 Bristol Pike

Bensalem, PA 19020
Telephone 215 633 8337

seal.

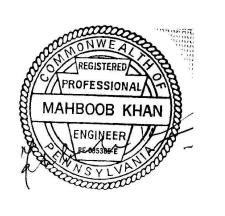

project:

/ENTION CENTER

ENNSYLVANIA

13TH STREET LIGHTING ELECTRICAL POWER DESI 1101 ARCH STREET

no:	revision	date
1	BID SET	05.15.202

sheet title:

ELECTRICAL OVERALL POWER PLAN

	scale:		As Noted
	date:		5/15/2024
•	drawn	by:	J.M./P.O.D.

checked by: M.K.

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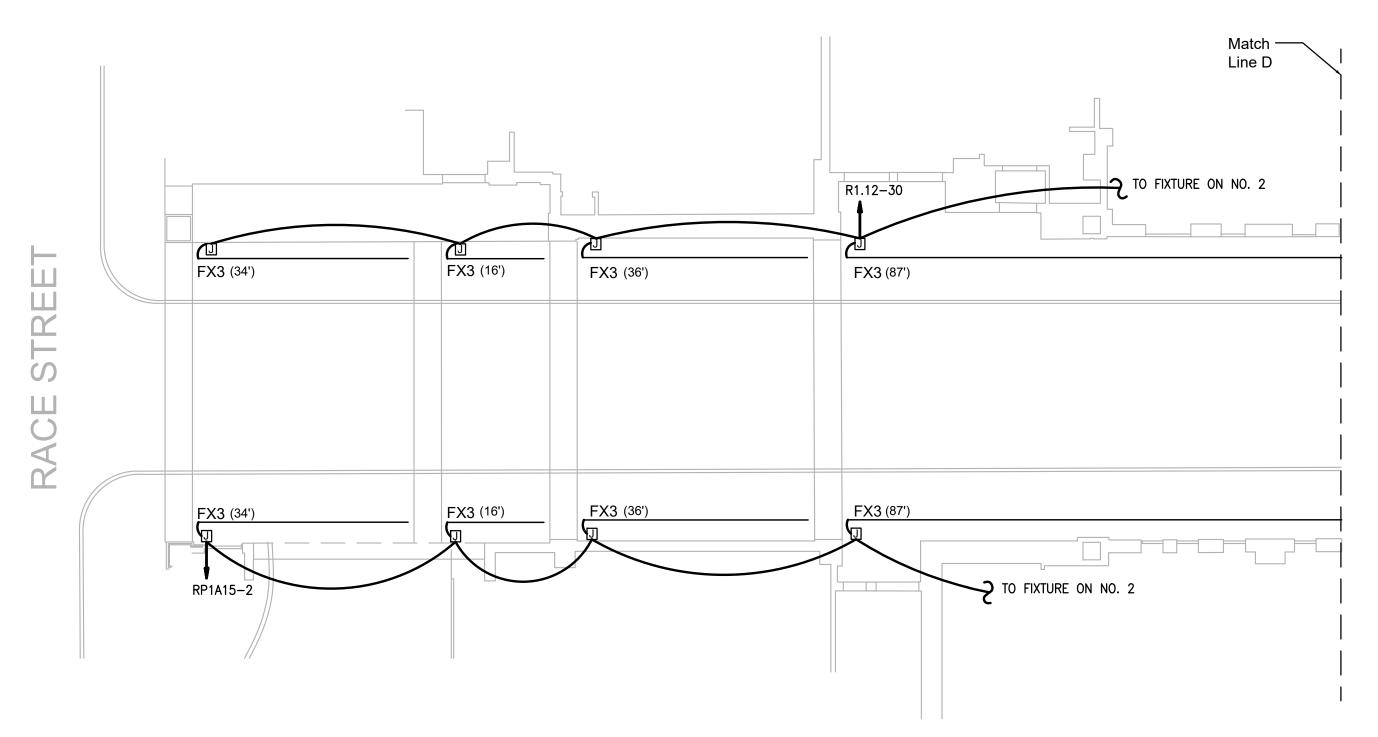
drawing no.

PANEL INDICATED ON THE PLANS.


7. FIXTURE MOUNTING SHALL BE PER NO. 1 & NO. 2 ON DRAWING

E-1


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PARTIAL LIGHT PLAN - PART D SCALE: 1/16" = 1'-0"



PARTIAL LIGHTING PLAN - PART E SCALE: 1/16" = 1'-0"

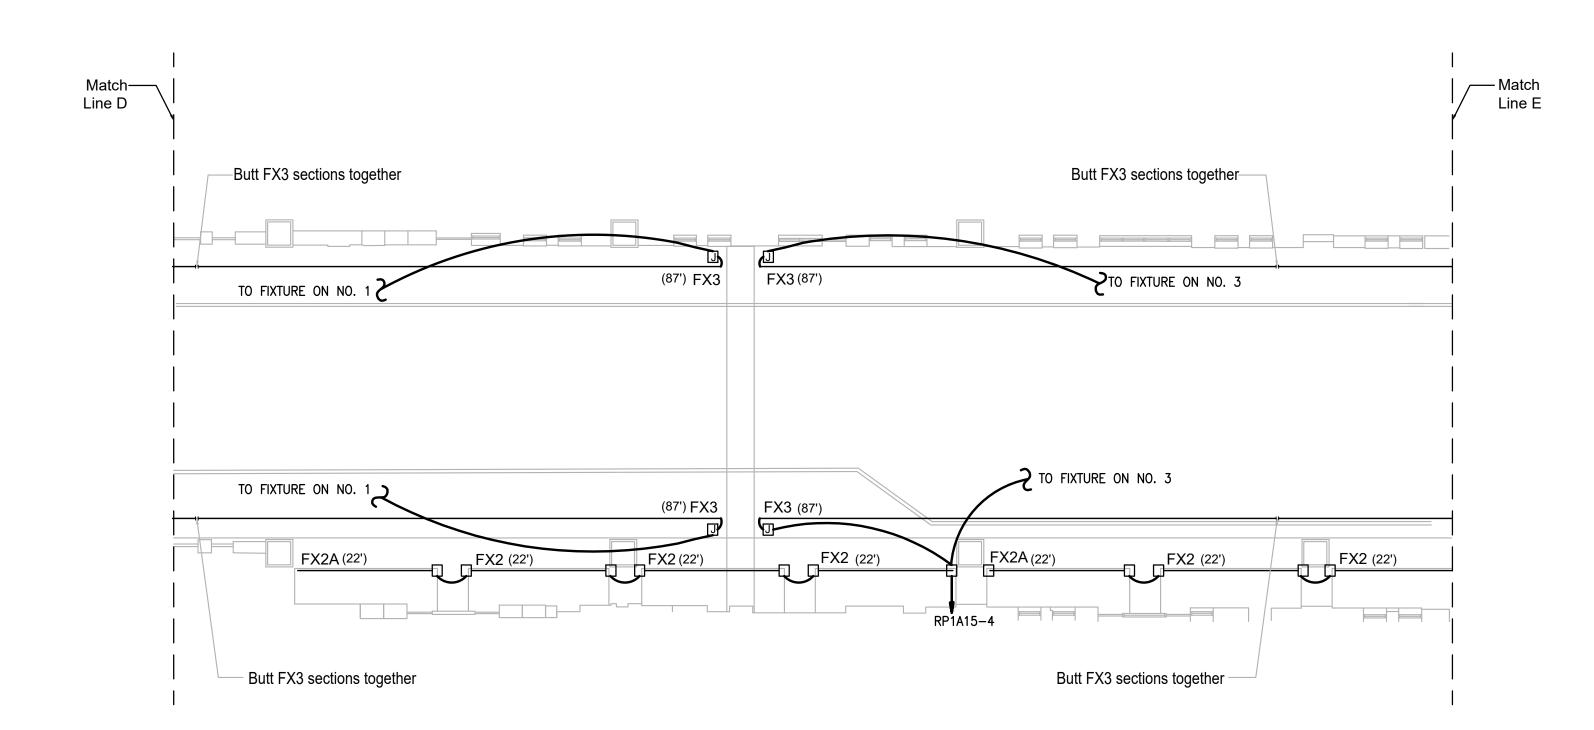


<u>GENERAL NOTES:</u>

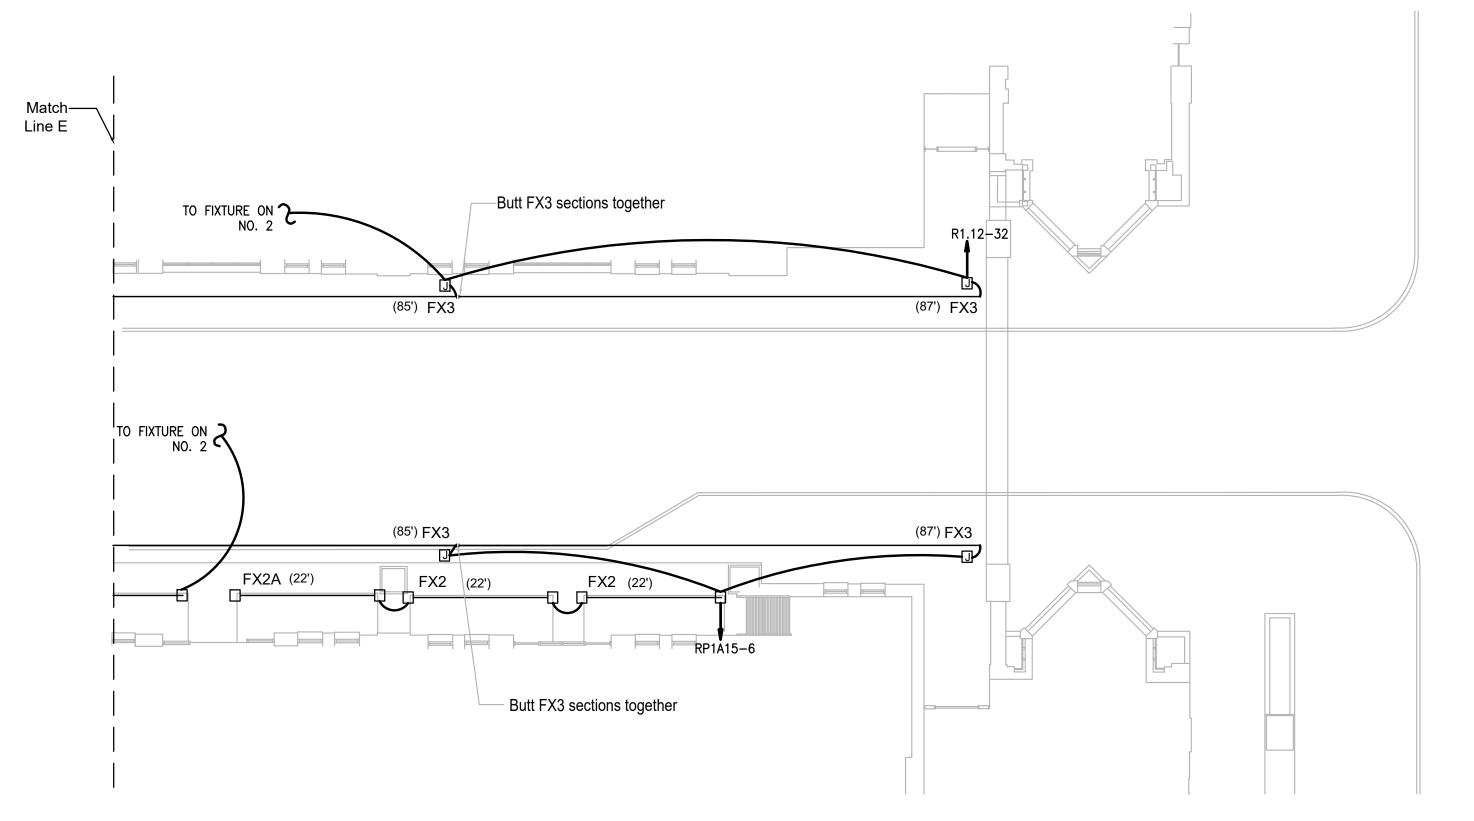- 1. WIRING SHALL BE CONCEALED AS MUCH AS POSSIBLE.
- 2. WIRING SHALL REFER TO BOTH CONDUIT AND CONDUCTORS.
- ALL WIRING SHALL BE WEATHERPROOF AND BE SUITABLE FOR OUTDOORS AND WET LOCATIONS.
- 4. FOR CIRCUIT PROVIDE NEW 20A/1P CIRCUIT BREAKER FOR EACH CIRCUIT SHOWN.
- 5. WIRE CIRCUIT DIRECTLY TO THE PANEL.
- 6. THE LENGTHS OF THE FIXTURES ARE INDICATED NEXT TO THE FIXTURE ID.

LEGEND:

- CUSTOM MADE J-BOX COMES WITH
 THE FIXTURE. (PROVIDED BY FIXTURE MANFACTURER.)
- J CONNECT BX WHIPS ATTACHED TO THE BACK OF THE FIXTURE CONNECTION BOXES TO A NEW JUNCTION BOX INSTALLED ABOVE AN ACCESSIBLE CEILING.

consultant

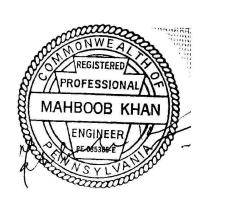

project:

no:	revision	date
1	BID SET	05.15.2024

PENNSYLVANIA

sheet title:

PARTIAL LIGHTING PLANS -PART D, E, & F

scale:	As Noted			
date:		5/15/2024		
drawn	by:	J.M./P.O.D.		

checked by: M.K.

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drawing no.

E-2

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PARTIAL LIGHTING PLAN - PART F

SCALE: 1/16" = 1'-0"